



The map displays the Silver Bay area, including neighborhoods such as Snug Harbor, Oak Glen, Woodville, Fairview Estates, Sky View Manor, Bellerest Park, Barnegat Bay Estates, Seaside Heights Harbor, Windsor Park, Bayview Harbors, and Titton Point. Water bodies shown include Silver Bay, Silver Creek, Applegate Cove, and various coves. Roads are labeled with names like Silver Bay Blvd, Snug Harbor Blvd, Oak Glen Blvd, and others. A compass rose indicates North, and a scale bar shows distances up to 1 mile. A legend identifies symbols for water, land, and roads. A red dot marks the project location near the intersection of Silver Bay Blvd and Snug Harbor Blvd.

SOURCE: 2019 USGS QUADRANGLE

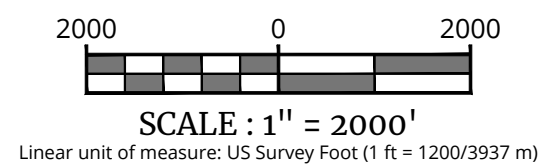

INDEX OF SHEETS		
SHT. No.	DESCRIPTION	LATEST REVISION
1	COVER SHEET	
2	GENERAL NOTES & LEGEND	
3	EXISTING CONDITIONS PLAN	
4	SHORELINE LAYOUT PLAN	
5	GRADING PLAN	
6	TYPICAL SECTIONS	
7	TYPICAL SECTIONS	
8	BREAKWATER BRANCH CROSS SECTIONS	
9	SOIL EROSION & SEDIMENT CONTROL NOTES & DETAILS	

[illegible]

NEW JERSEY
PROFESSIONAL ENGINEER
LICENSE NUMBER: GE39023
Date: 2/20/21

Richard C. Maloney

Digitally signed by Richard Maloney
Date: 2020.11.10 09:45:40-0500

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NEW JERSEY LICENSED PROFESSIONAL ENGINEER
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N.J. C.O.A. #: 24G247986500

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SCALE: AS SHOWN	DATE: 02/29/2024	DRAWN BY: SM	CHECKED BY: NM
PROJECT NUMBER: 23004440G		DRAWING NAME: C-COVER	

SHEET TITLE:

COVER SHEET


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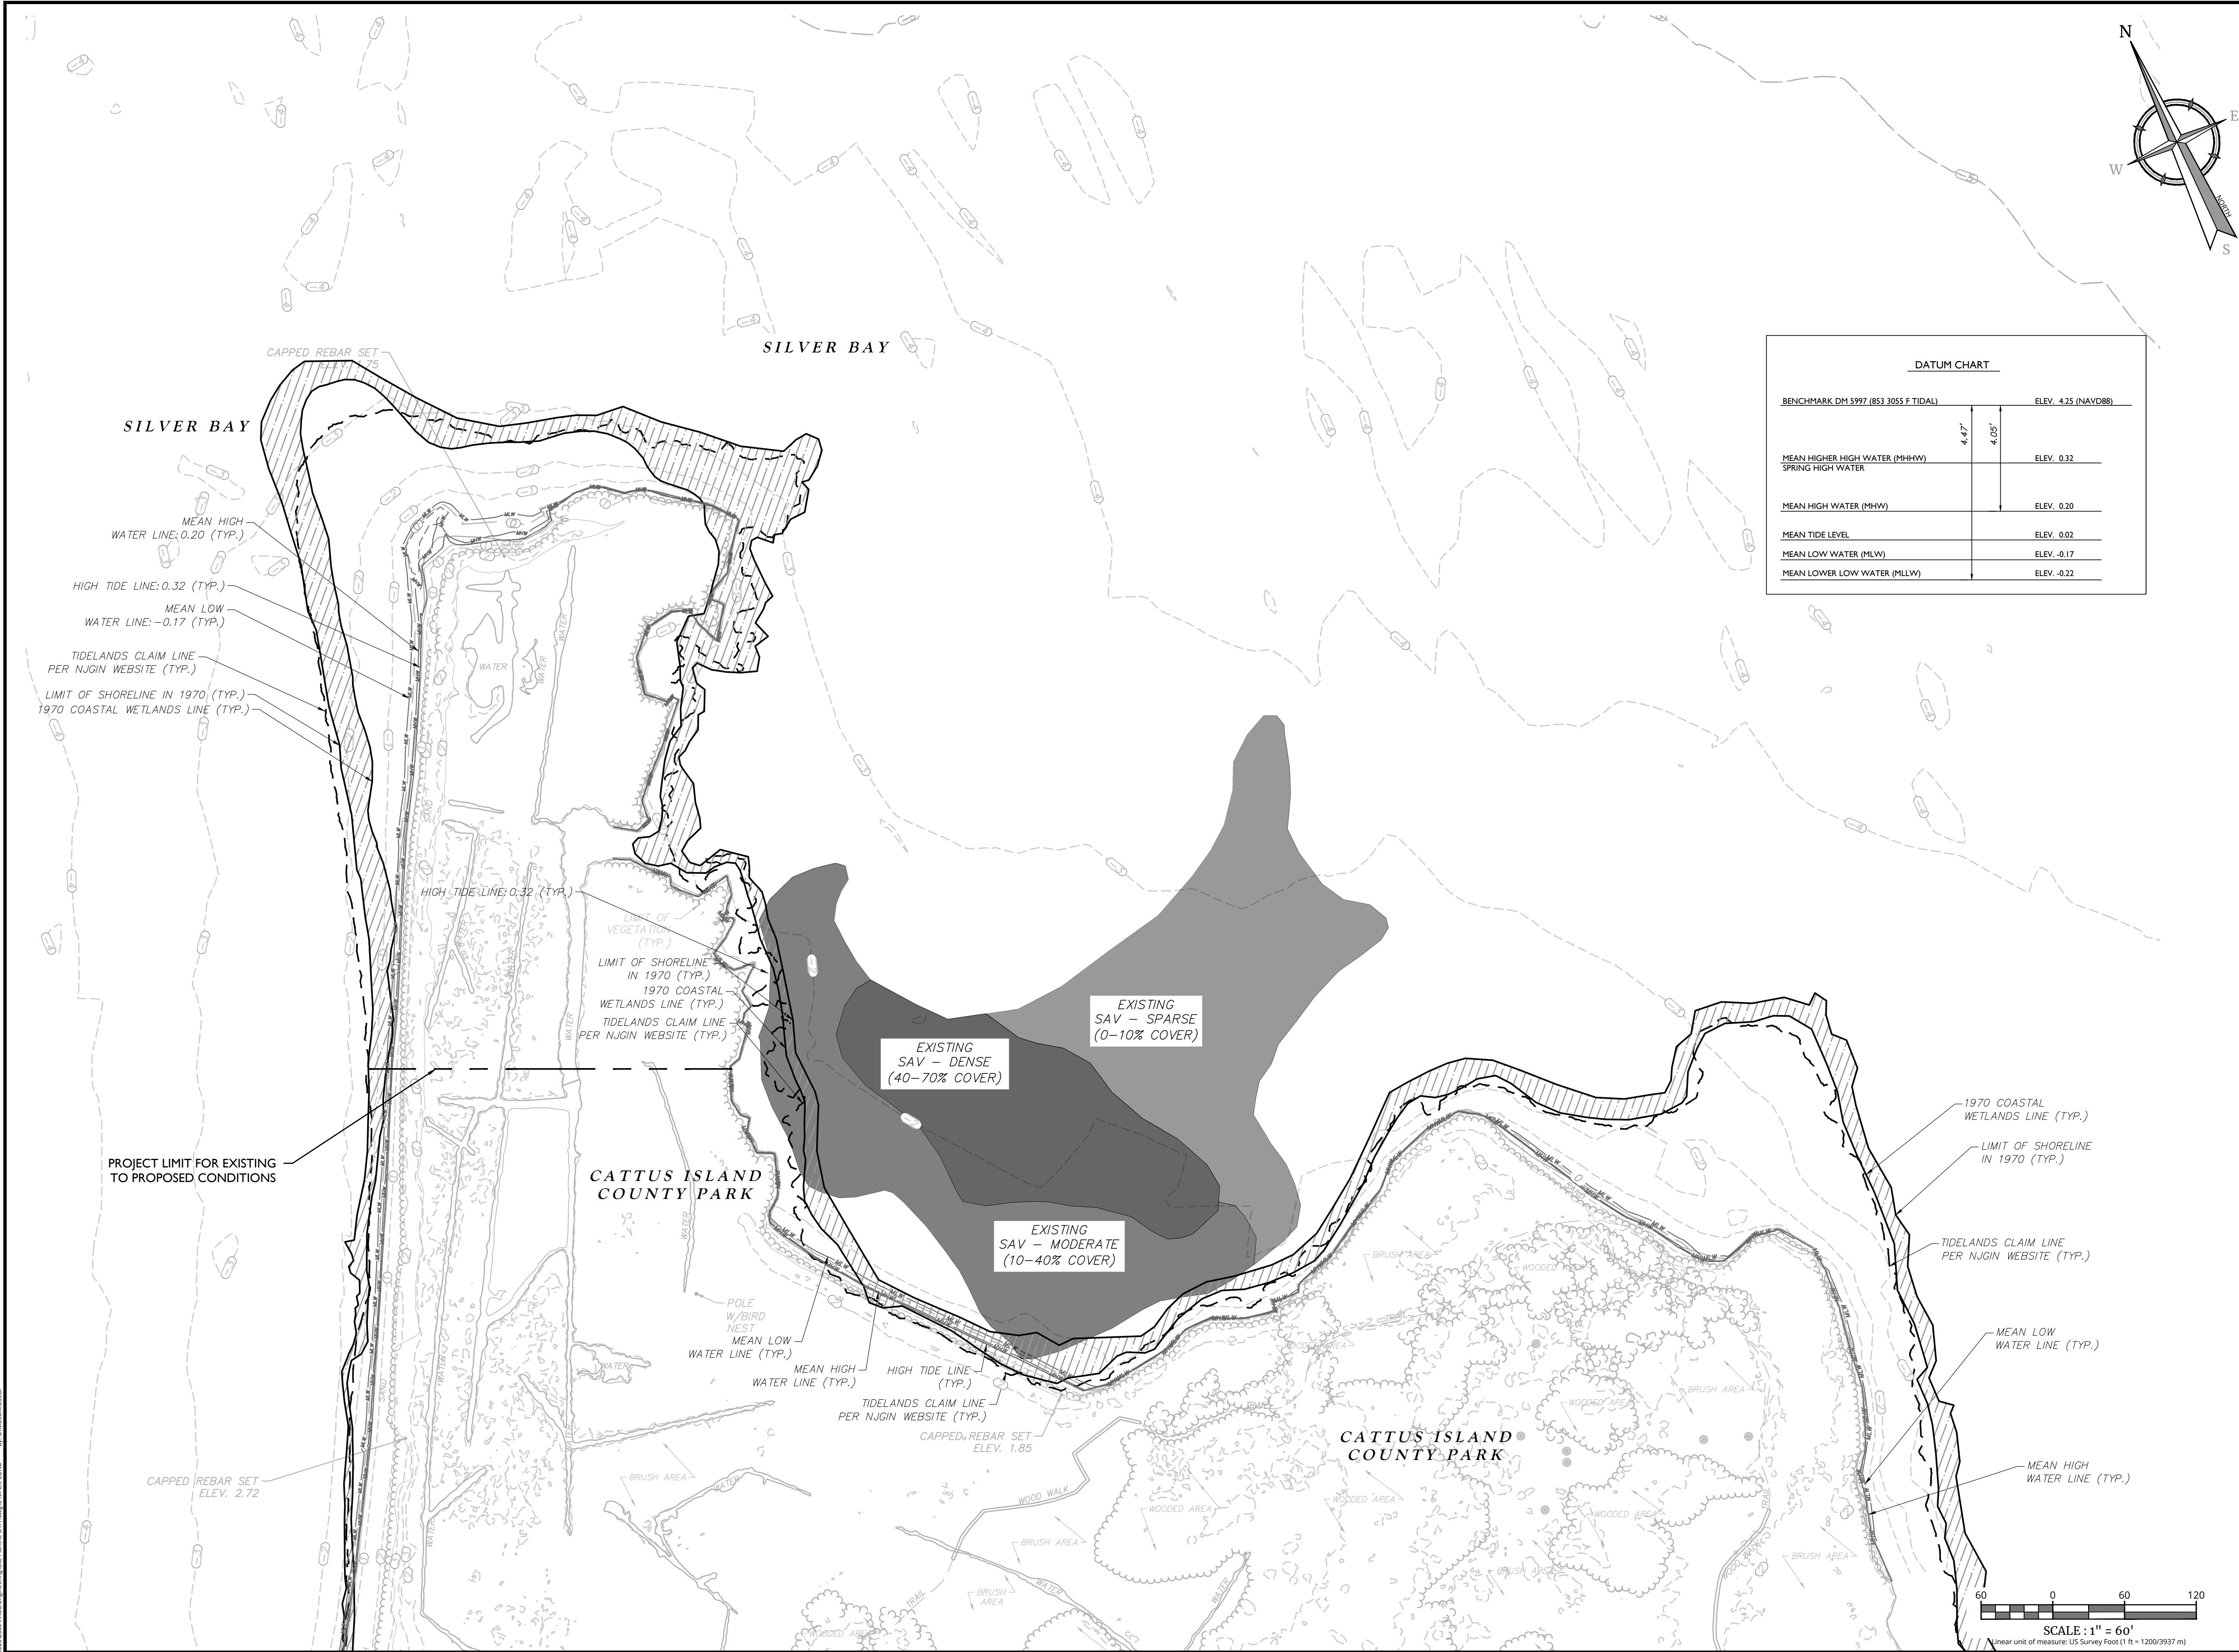
THE OWNER, OR HIS REPRESENTATIVE, IS TO DESIGNATE AN INDIVIDUAL RESPONSIBLE FOR CONSTRUCTION SITE SAFETY DURING THE COURSE OF THE SITE IMPROVEMENTS PURSUANT TO N.J.A.C. 5:23-2.1(e) OF THE N.J. UNIFORM CONSTRUCTION CODE AND CFR 1926.32(f) (OSHA COMPETENT PERSON)".

NOTE: DO NOT SCALE DRAWINGS FOR CONSTRUCTION.

1. SPECIFIC TO THIS PROJECT: BASED UPON THE NEW JERSEY STATE PLANE COORDINATE SYSTEM, NAD 83 (NEAR SURFACE DERIVED COORDINATES UTILIZING KEYNET GPS).
2. EXISTING SITE TOPOGRAPHIC INFORMATION AS SHOWN IS BASED UPON NAVD 88 (NORTH AMERICAN VERTICAL DATUM OF 1988) PER GPS OBSERVATION BY COLLIER ENGINEERING & DESIGN, UTILIZING SMARTNET GPS.
3. WETLANDS AND TOXIC WASTES: THE UNDERSIGNED PROFESSIONAL IS NOT QUALIFIED TO DETERMINE THE EXISTENCE OR NON-EXISTENCE OF WETLANDS AND/OR TOXIC WASTES. THEREFORE, IT SHOULD NOT BE ASSUMED OR CONSTRUED THAT ANY STATEMENT IS BEING MADE BY THE FACT THAT NO EVIDENCE OF WETLANDS AND/OR TOXIC WASTE IS PORTRAYED HEREON. IT IS IN THE BEST INTEREST OF THE CLIENT TO PURSUE THESE MATTERS AS A SEPARATE CONCERN APART FROM THESE PLANS.
4. TOPOGRAPHY IN LAND AREAS BASED ON AERIAL SURVEY PERFORMED BY UAS, WATER AREAS BASED ON BATHYMETRIC SURVEY BY HYDROLITE ECHO SOUNDER.
5. MEAN TIDAL RANGE IS 0.37'.
6. MEAN HIGH WATER LEVEL IS 0.20'.
7. MEAN LOW WATER LEVEL IS -0.17'.
8. ALL DIMENSIONS & COORDINATES ARE GIVEN IN FEET.
9. ALL EARTH/ROCK INTERFACES SHALL BE LINED FILTER CLOTH.

1. CONTRACTOR SHALL NOTIFY NJDEP OF THE DATE CONSTRUCTION IS TO BEGIN AT LEAST SEVEN (7) DAYS PRIOR TO THE DATE (1 DAY).
2. CLEAR ENTRANCE TO SITE, INSTALL SILT FENCE, STOCKPILE & STAGING AREA, AND CONSTRUCTION ENTRANCE PAD (1 WEEK).
3. CLEARING, INSTALL TURBIDITY CURTAIN (2 WEEKS).
4. REMOVE ALL DEBRIS INTERFERING WITH SHORELINE CONSTRUCTION AS CONSTRUCTION PROCEEDS (CONTINUOUS).
5. MARKOUT CONSTRUCTION BASELINE, INSTALL ROCK BREAKWATERS & REEF BALLS (9 MONTHS).
6. INSTALL FILL AREA AND ROUGH GRADING (2 MONTHS).
7. FINE GRADE AND INSTALL HIGH MARSH PLANTINGS (1 MONTH).
8. REMOVE SCD MEASURES & FINAL CLEAN-UP (2 WEEKS).



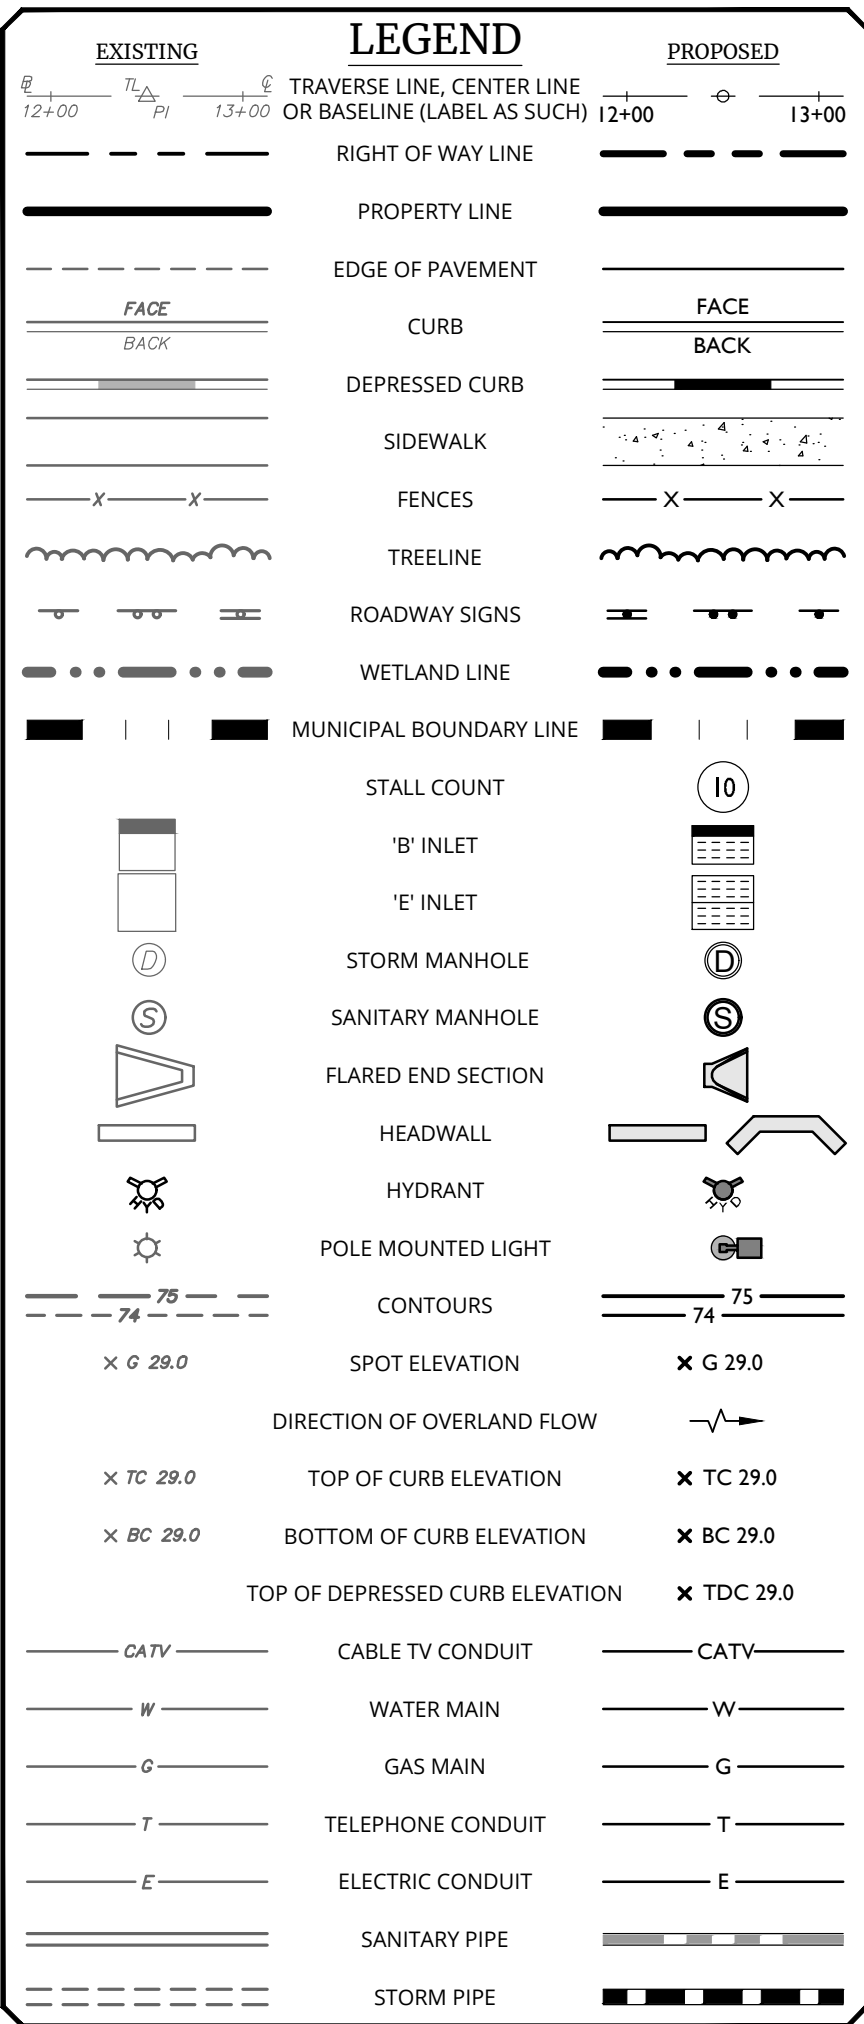

DATUM CHART	
BENCHMARK DM 5997 (853 3055 F TIDAL)	ELEV. 4.25 (NAVD88)
MEAN HIGHER HIGH WATER (MHHW) SPRING HIGH WATER	ELEV. 0.32
MEAN HIGH WATER (MHW)	ELEV. 0.20
MEAN TIDE LEVEL	ELEV. 0.02
MEAN LOW WATER (MLW)	ELEV. -0.17
MEAN LOWER LOW WATER (MLLW)	ELEV. -0.22

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1	07/10/24	SM	ADDED HIGH TIDE LINE

Richard C. Maloney
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LICENSE NUMBER: GE39023
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N.J. C.O.A. #: 24GA27986500

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SCALE: AS SHOWN	DATE: 02/29/2024	DRAWN BY: SM	CHECKED BY: NM
PROJECT NUMBER: 23004440G	DRAWING NAME: C-LAY1		


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EXISTING CONDITIONS PLAN

SHEET NUMBER:
3 of 9

20230204040G:\Engineering\the Point\C-LAY1.dwg C:\X EX COND. By: SAMUEL MCDONOP

NOTE: DO NOT SCALE DRAWINGS FOR CONSTRUCTION.

- NOTES:
- REEF BREAKWATERS SHOWN AT 12' WIDE SHALL BE COMPRISED OF 2 ROWS. REEF BREAKWATERS SHOWN AT 20' WIDE SHALL BE COMPRISED OF 3 ROWS. ALL REEF BREAKWATERS SHALL BE INSTALLED FOLLOWING TYPICAL SPACING, SEE DETAIL.
 - ROCK BREAKWATERS #2, #3, & #4 EACH HAVE A BRANCH POINTING LANDWARD AND HAVE CENTERLINES WHICH INTERSECT THE CONSTRUCTION BASELINE AT VARYING STATIONS & ANGLES, AS DIMENSIONED ON THE PLAN. ANGLES ARE MEASURED LEFT OF THE CONSTRUCTION BASELINE IN DEGREES-MINUTES-SECONDS.
 - REEF & STONE BREAKWATERS WITH RADII ARE MEASURED FROM CENTERLINE, DIMENSIONS ARE SHOWN ON TOP FOR CLARITY.

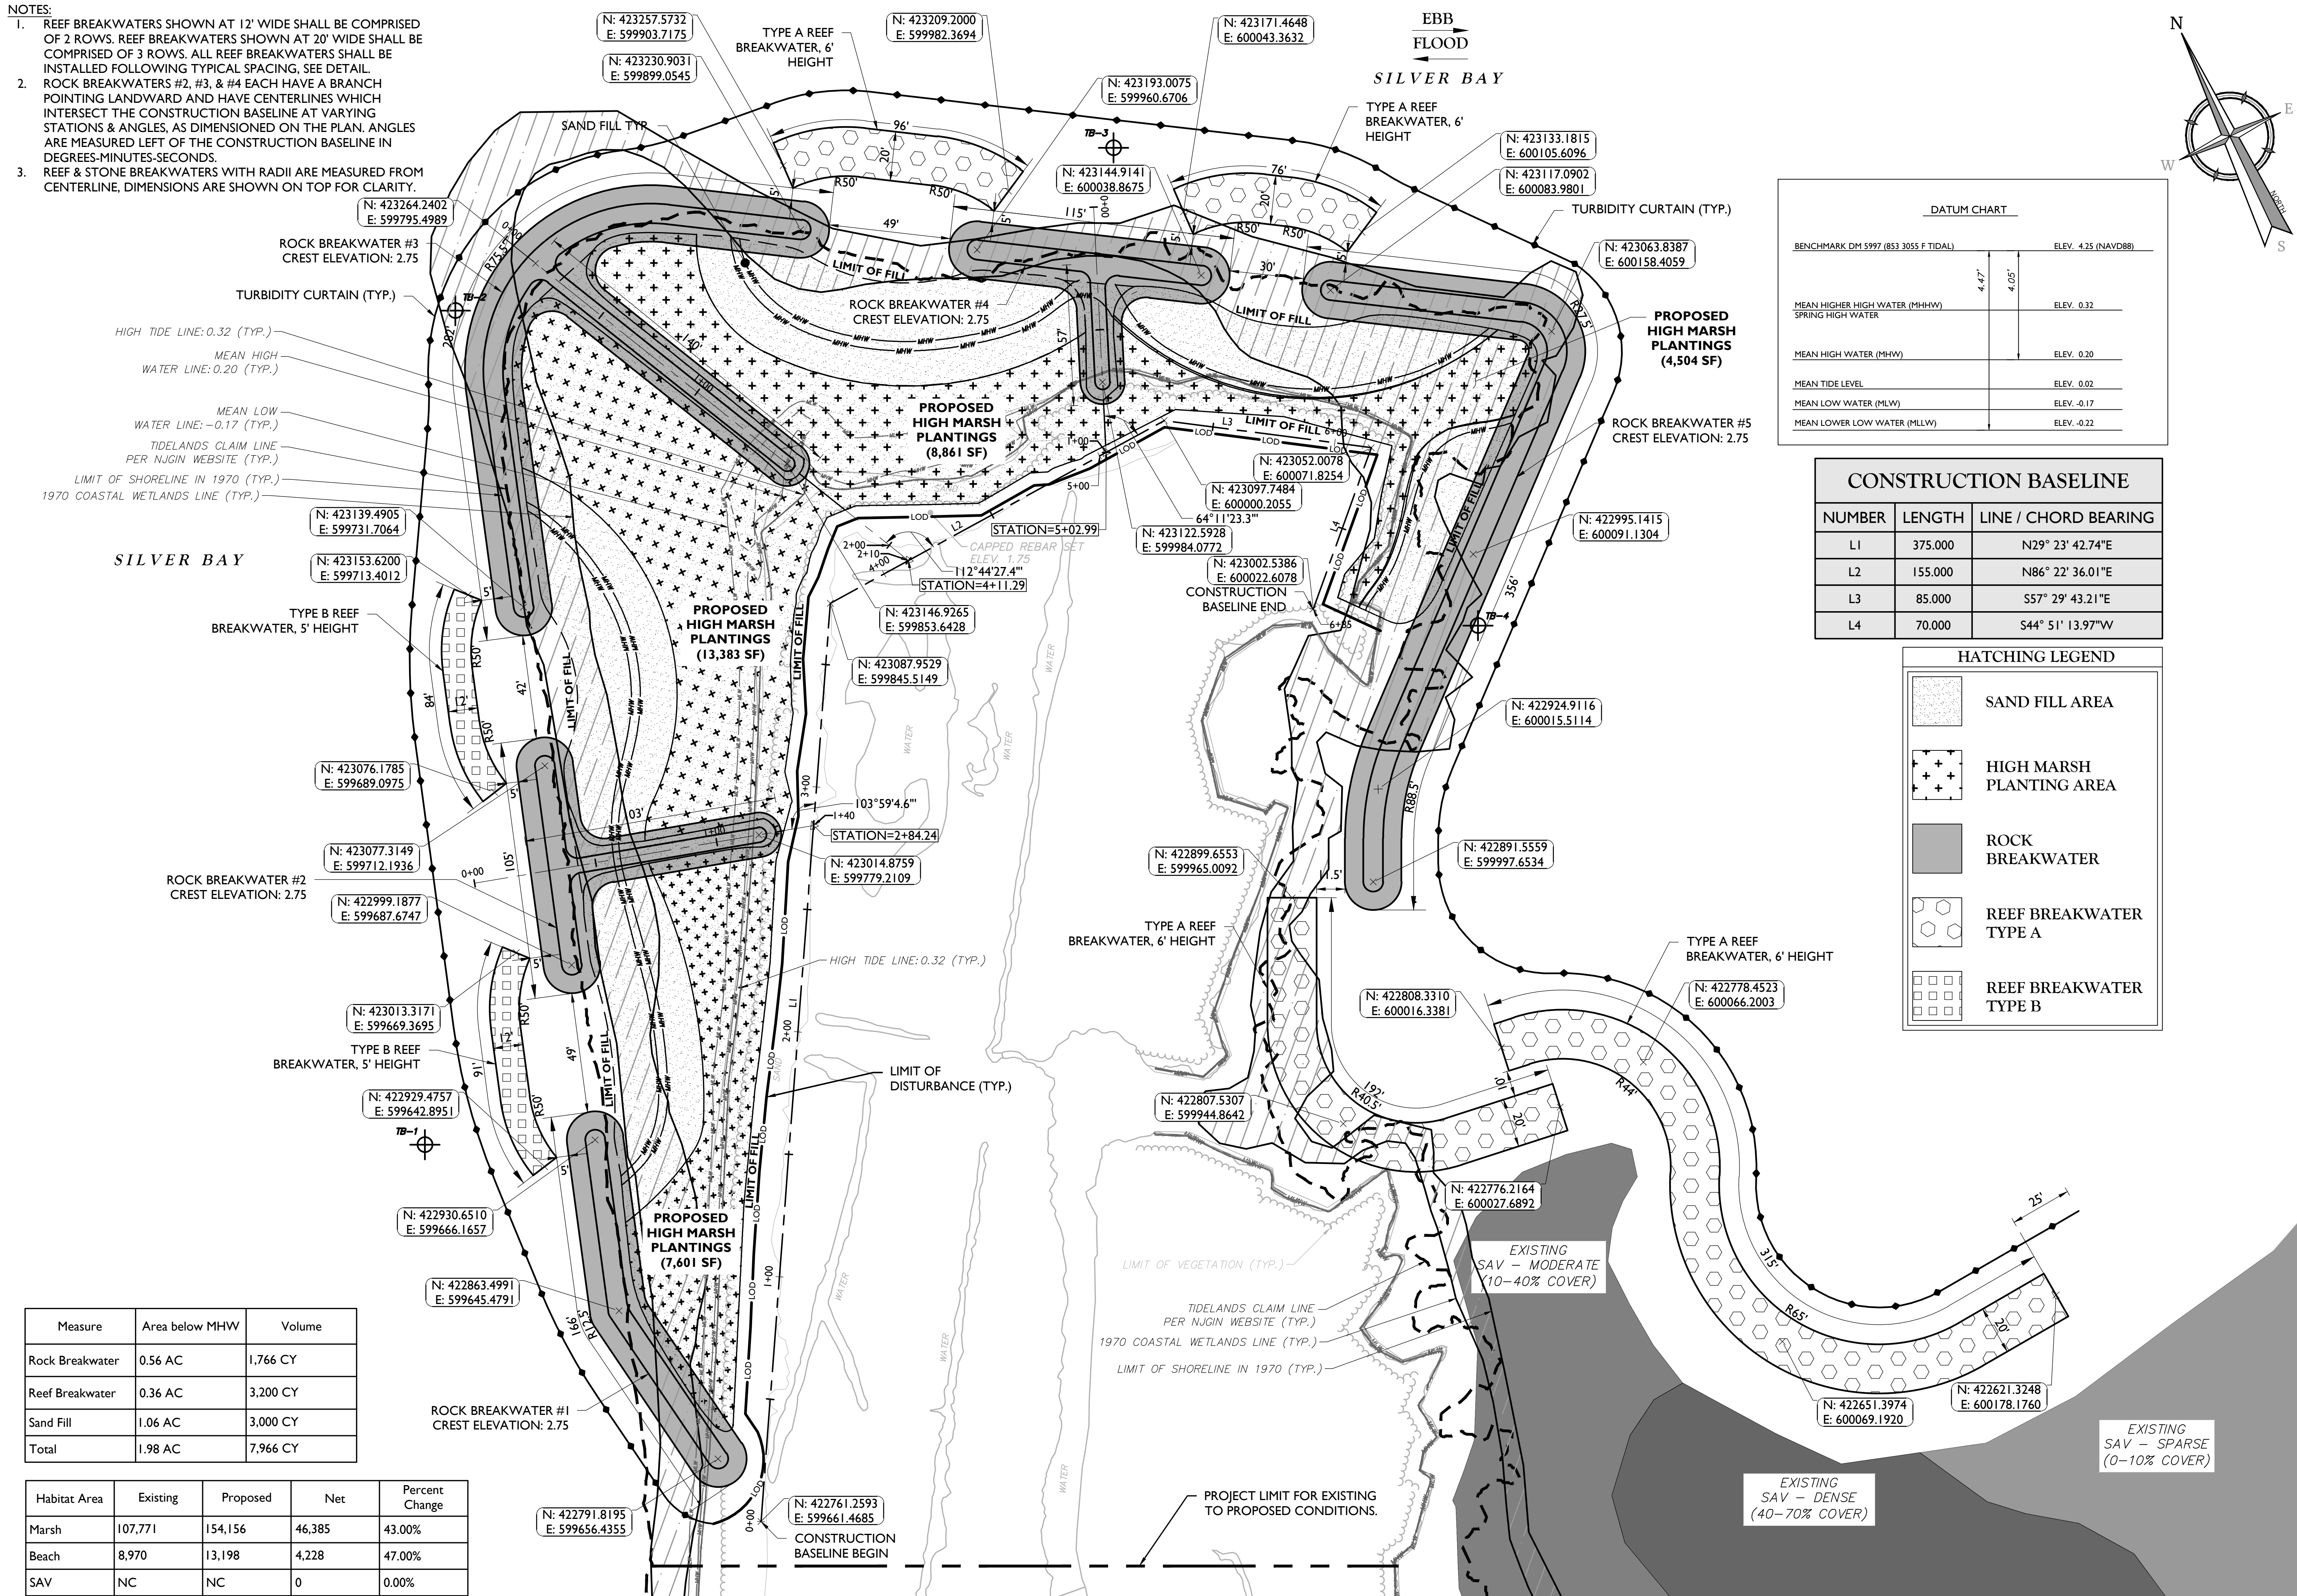

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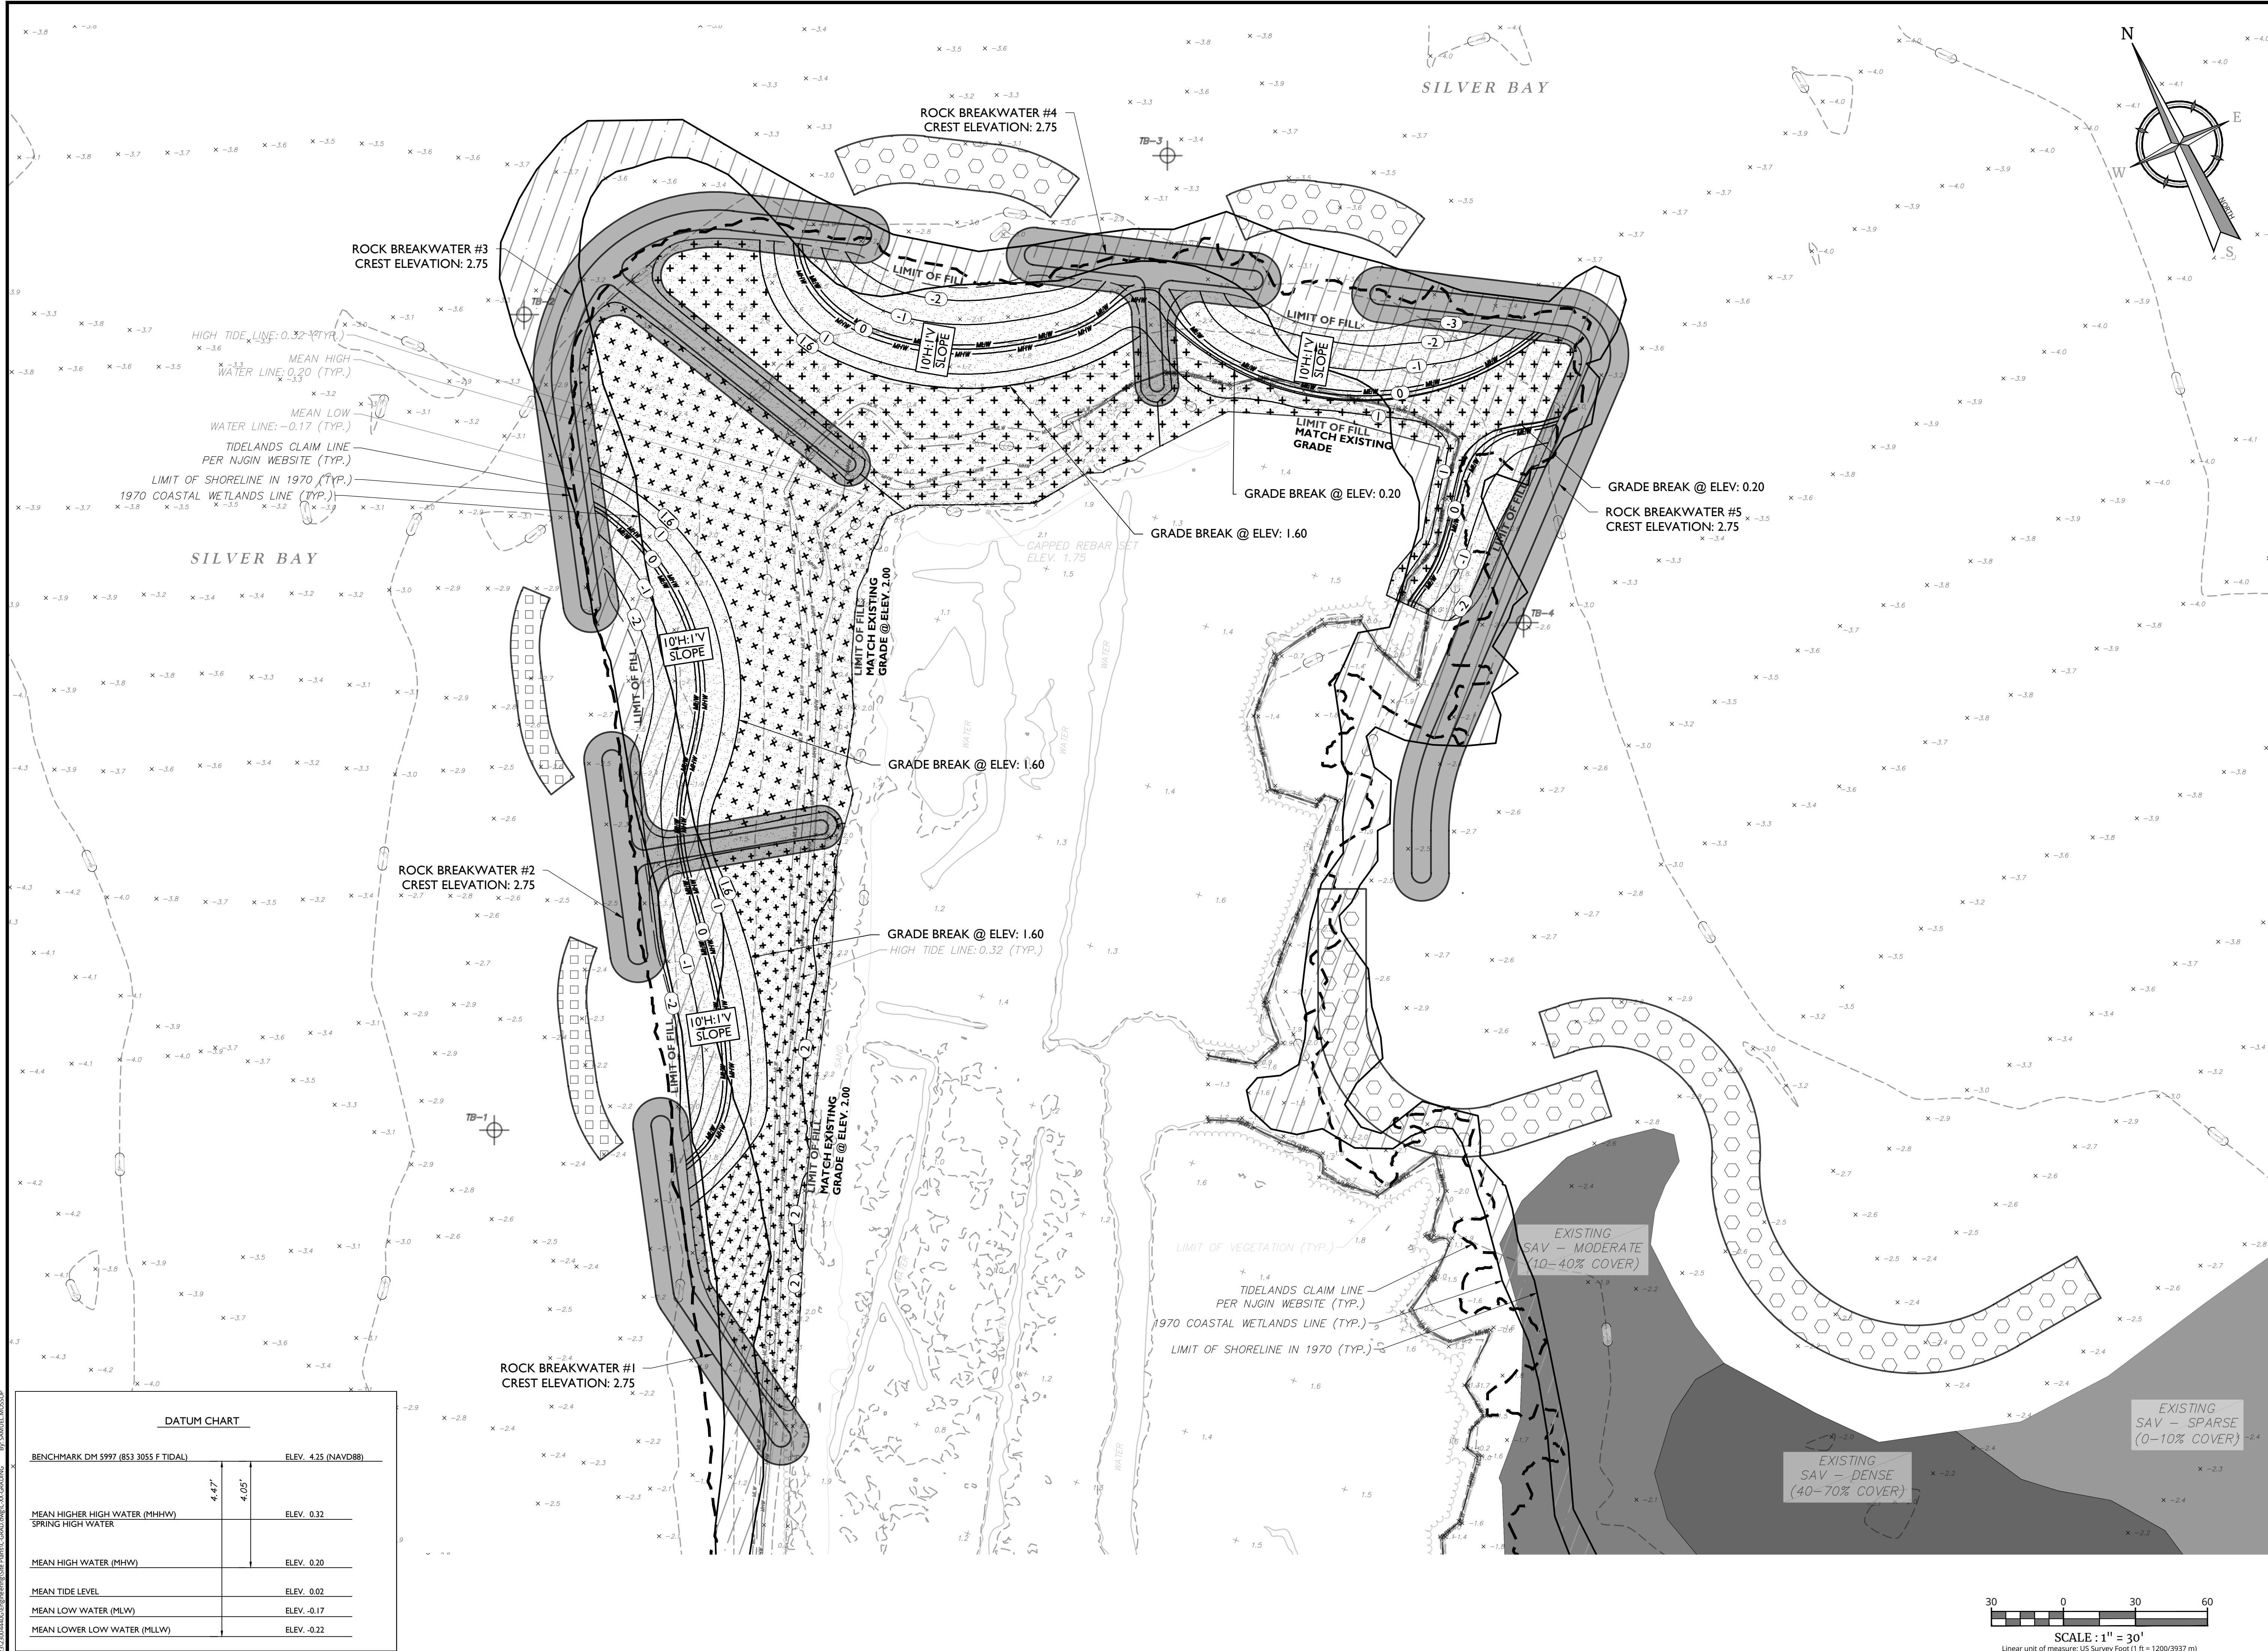
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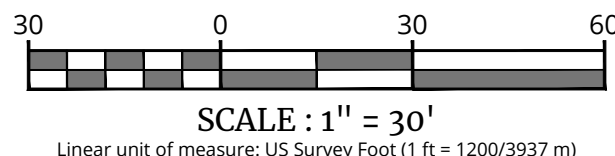
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SHORELINE LAYOUT PLAN

SHEET NUMBER:
4 of 9

NOTE: DO NOT SCALE DRAWINGS FOR CONSTRUCTION.



DATUM CHART		
BENCHMARK DM 5997 (853 3055 F TIDAL)		ELEV. 4.25 (NAVD88)
MEAN HIGHER HIGH WATER (MHHW)	4.47'	ELEV. 0.32
SPRING HIGH WATER	4.05'	
MEAN HIGH WATER (MHW)		ELEV. 0.20
MEAN TIDE LEVEL		ELEV. 0.02
MEAN LOW WATER (MLW)		ELEV. -0.17
MEAN LOWER LOW WATER (MLLW)		ELEV. -0.22



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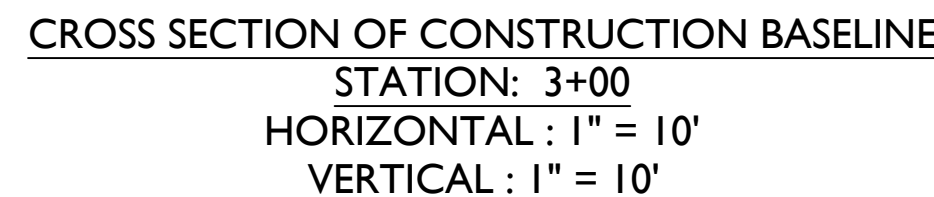
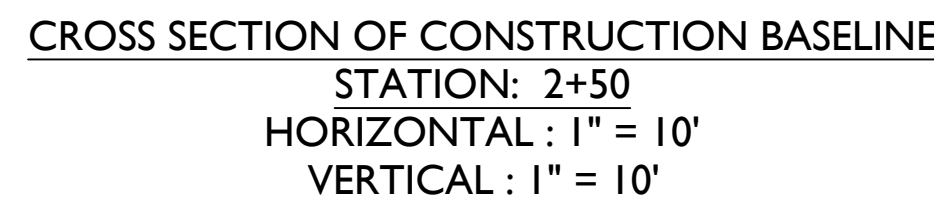
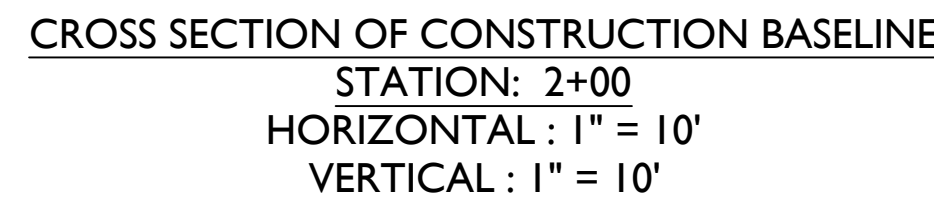
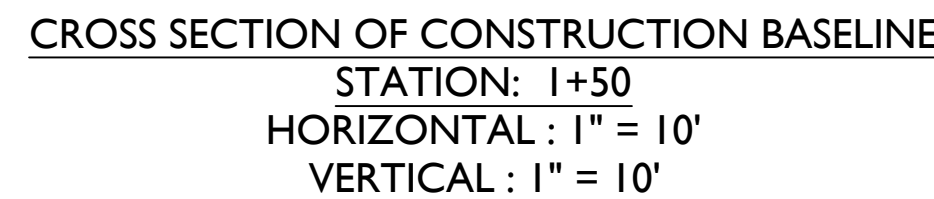
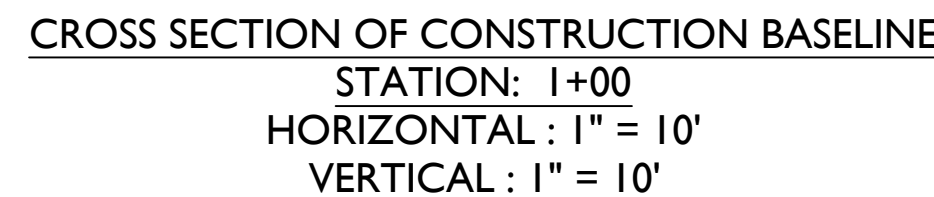
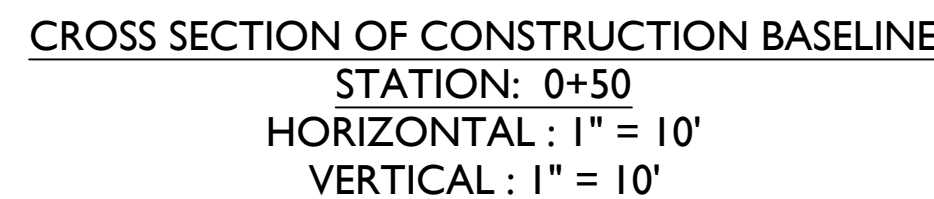
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SHEET NUMBER:






5 of 9

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NOTES:

1. IRREGULARITIES IN CROSS SECTIONS ARE PRESENT DUE TO THE GEOMETRY OF THE CONSTRUCTION BASELINE NOT BEING PARALLEL WITH THE BREAKWATERS, SLOPES, ETC.


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COLLIERS ENGINEERING & DESIGN, INC.
N.J. C.O.A. #: 24GA27986500

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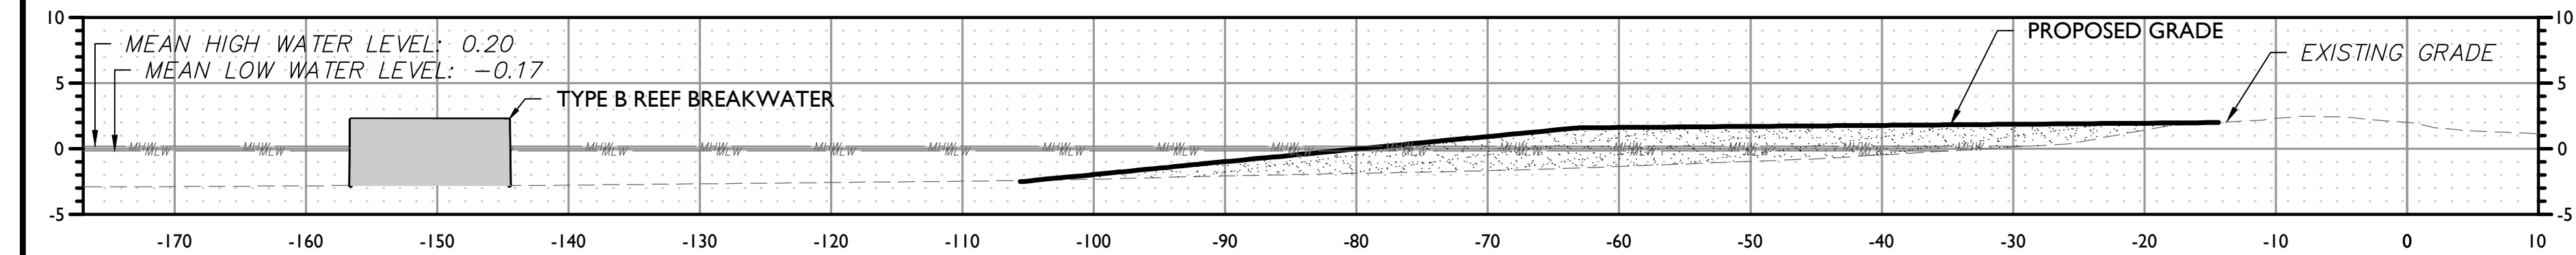
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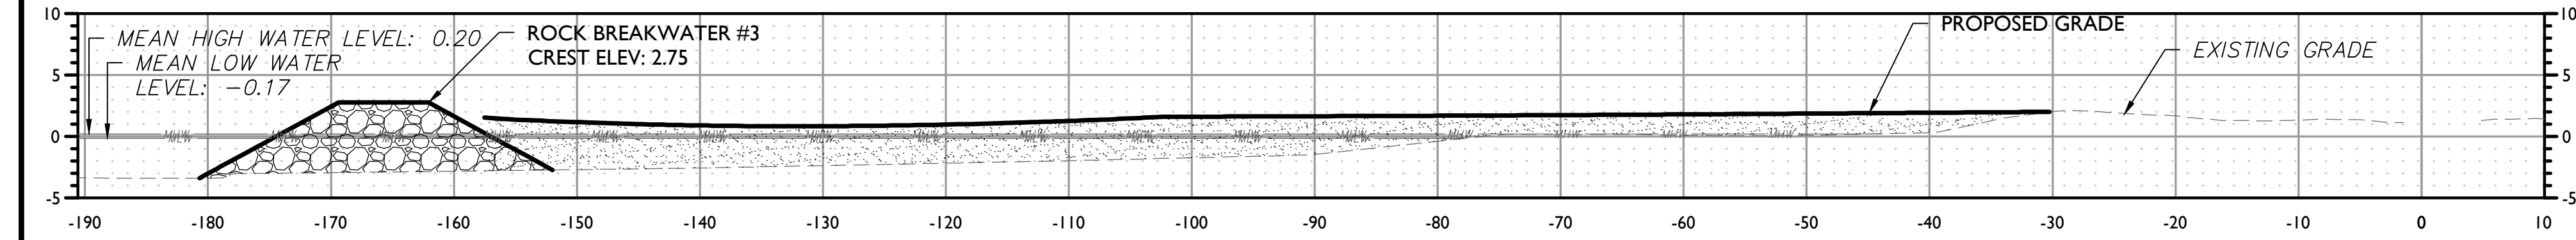
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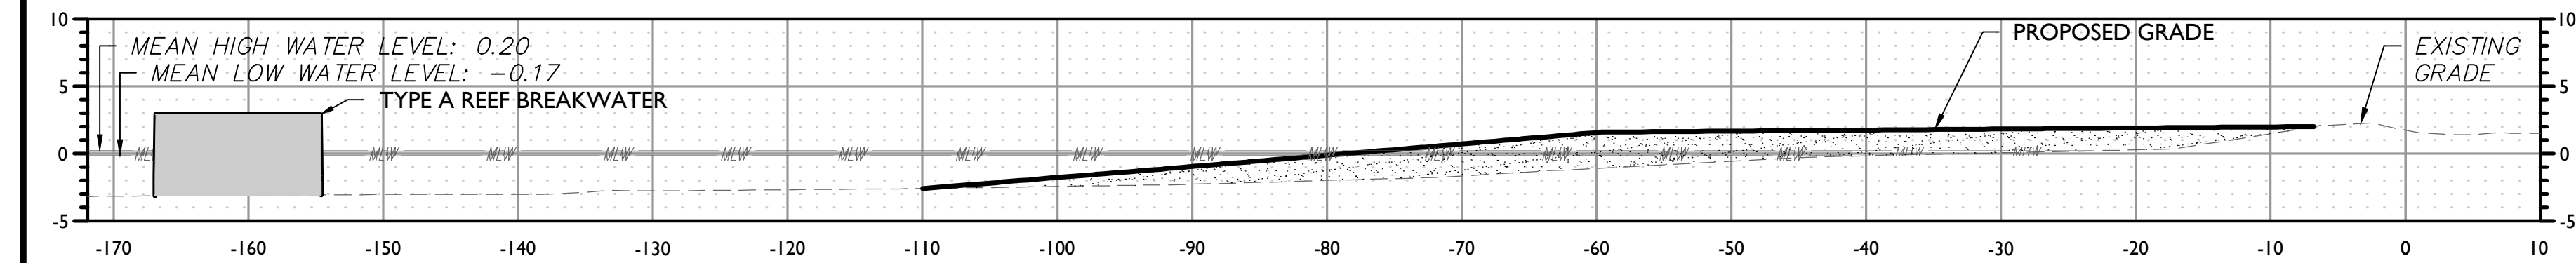
6 of 9

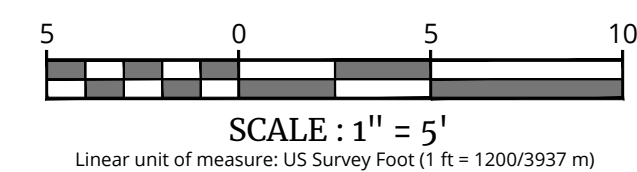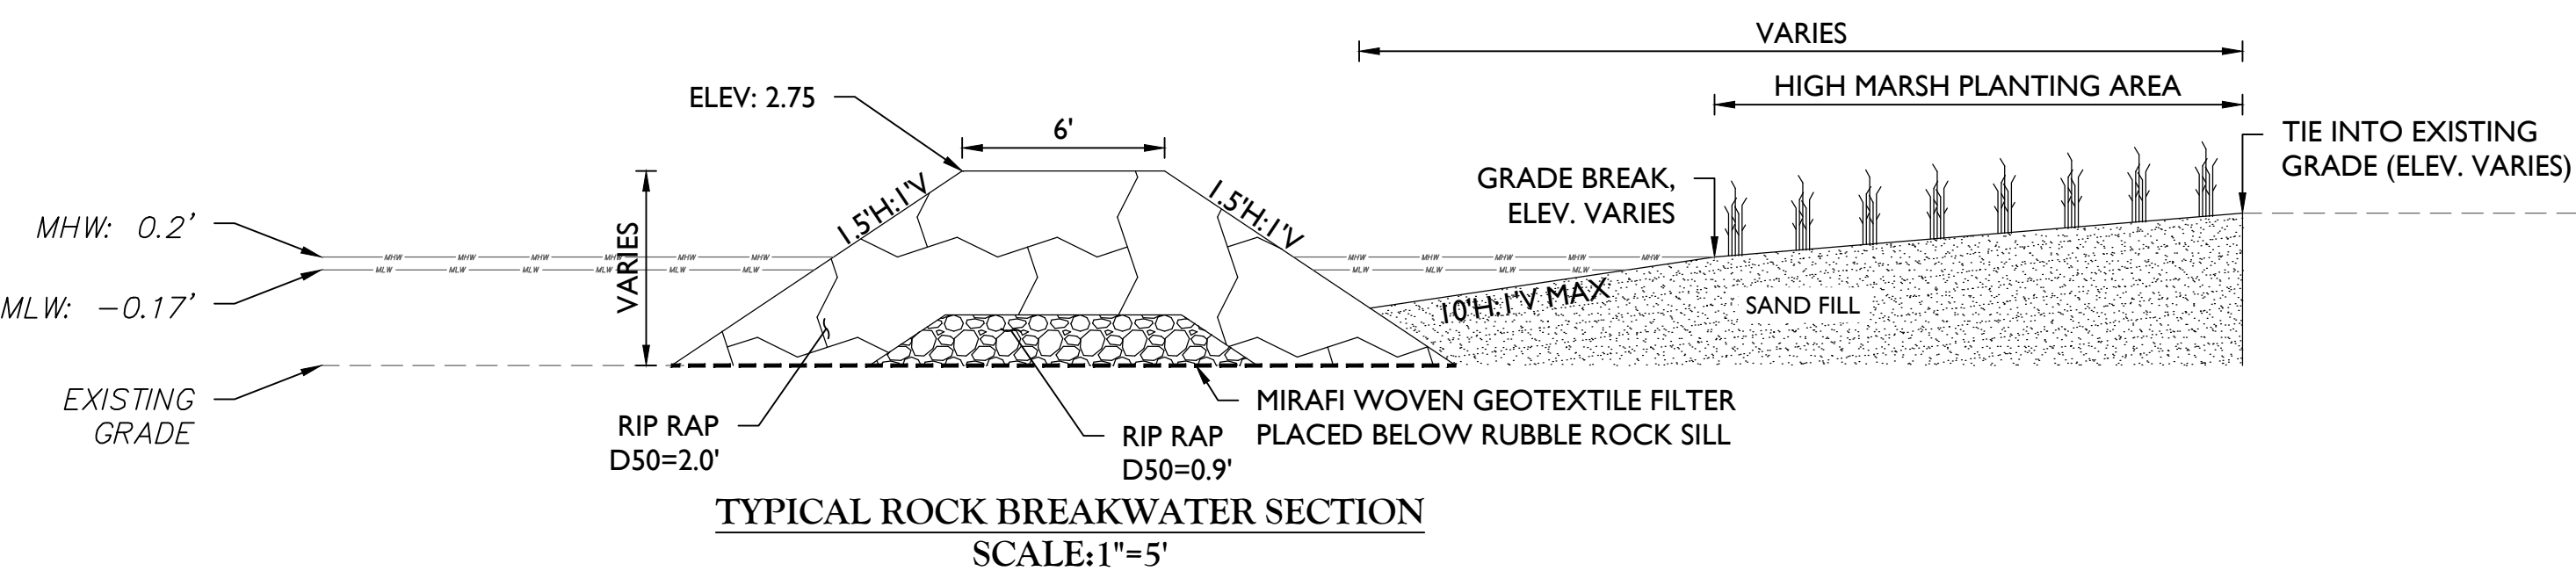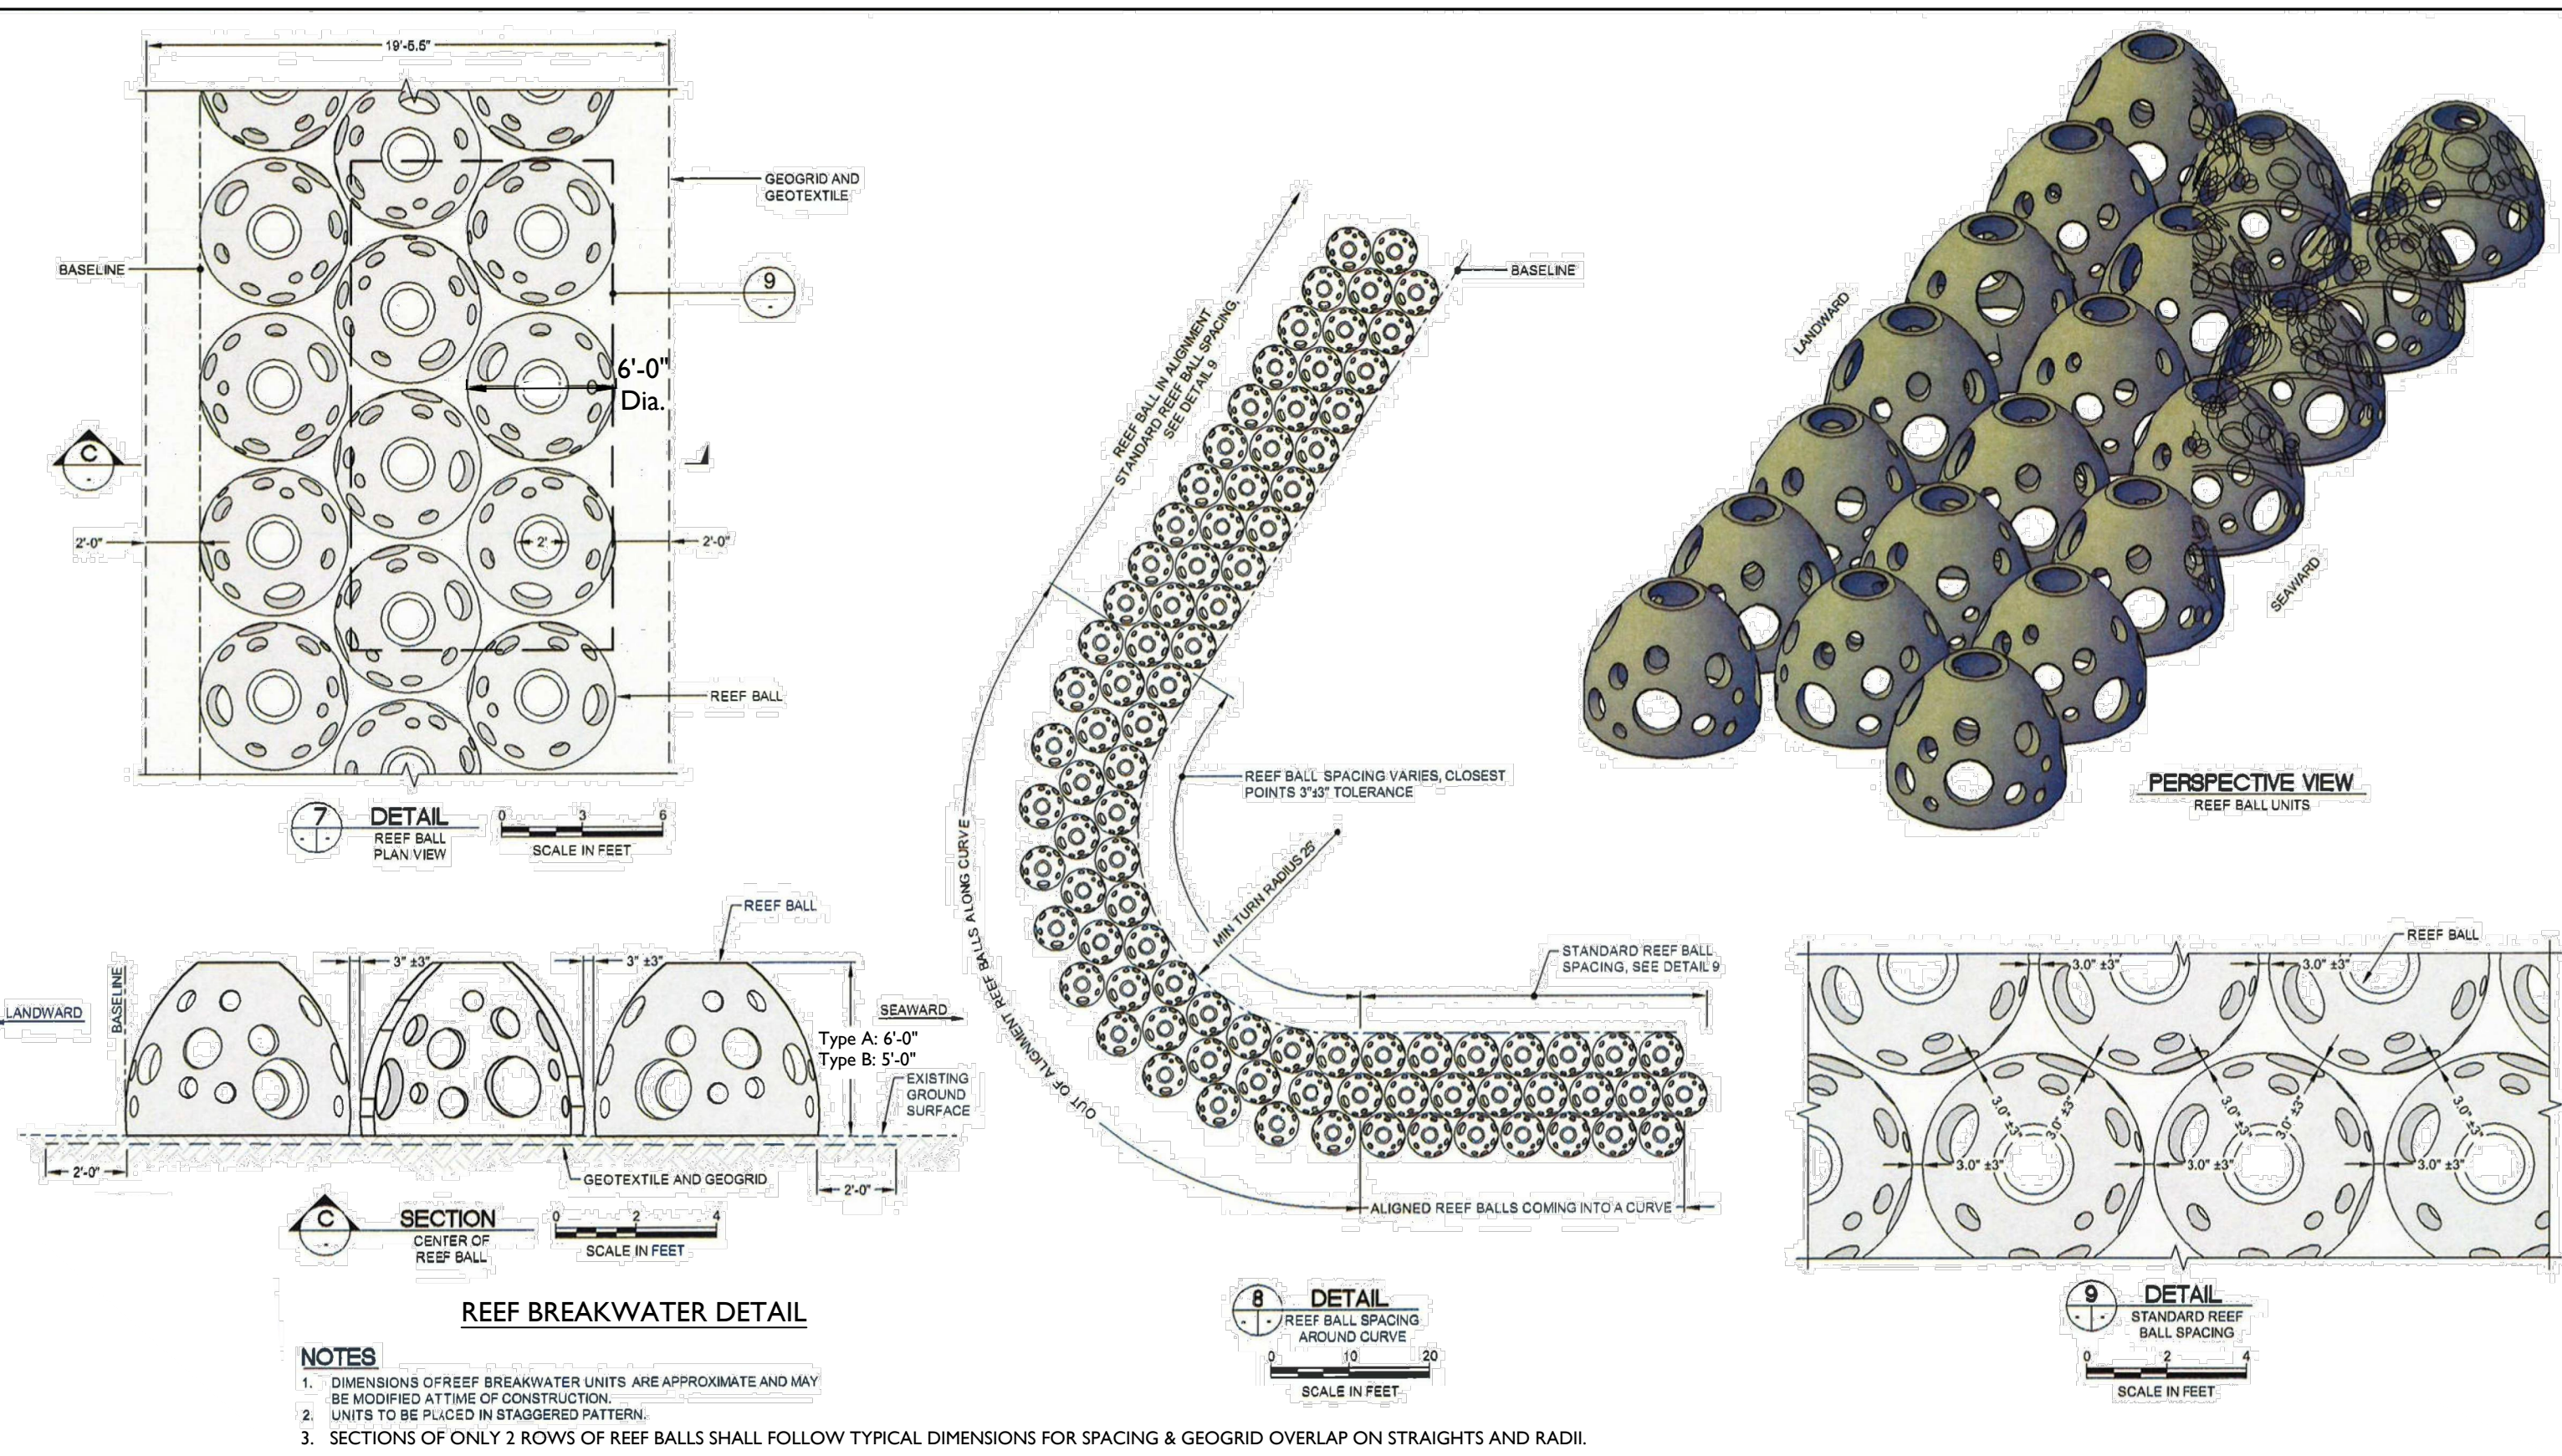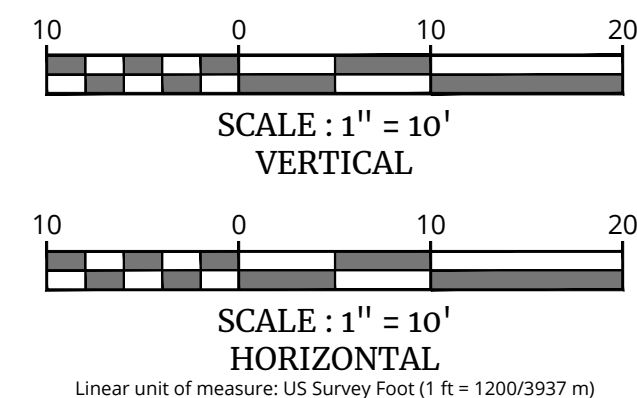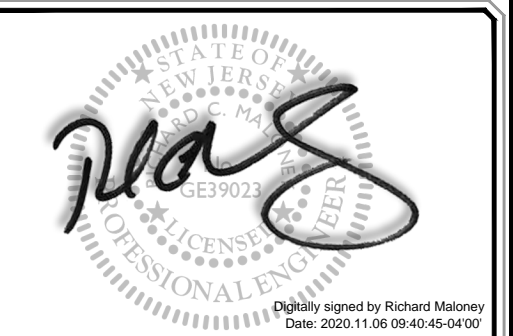


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VERTICAL : 1" = 10'

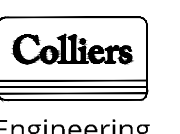


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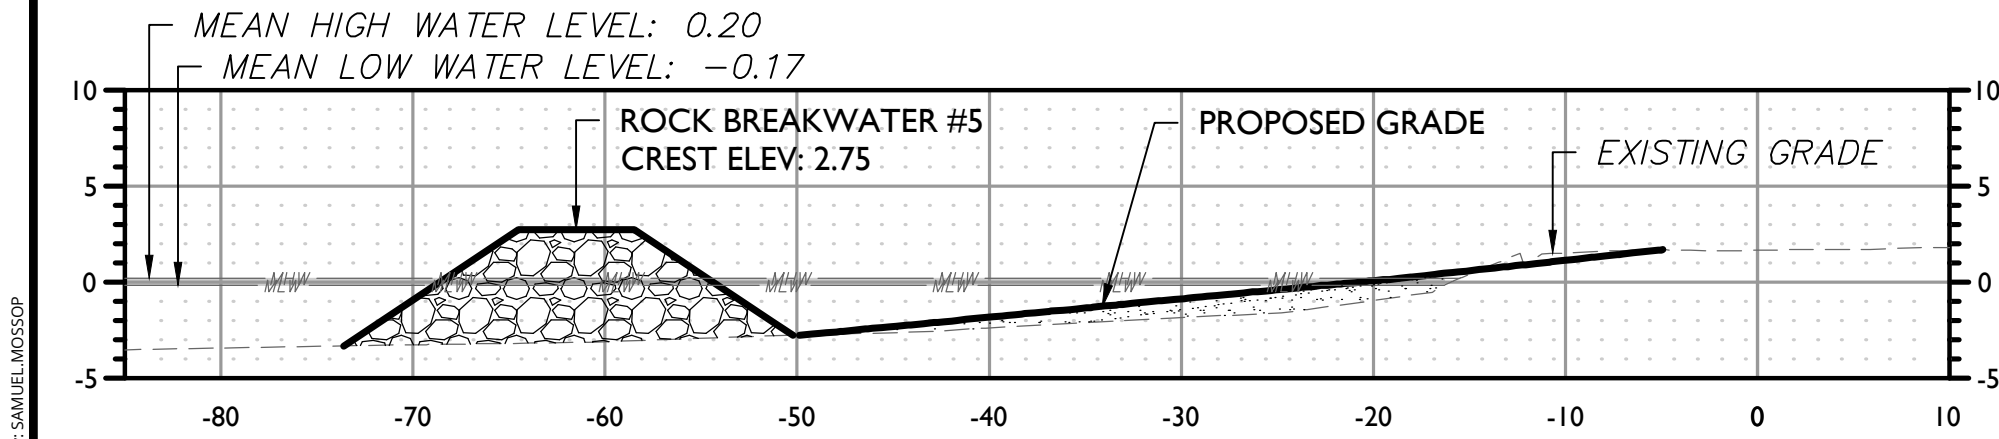
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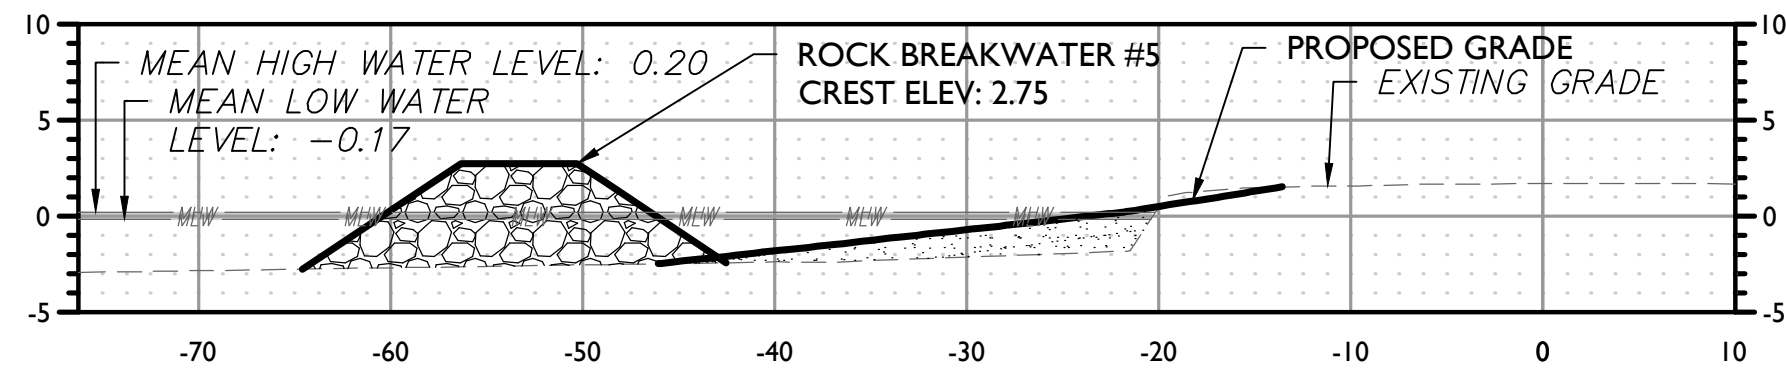
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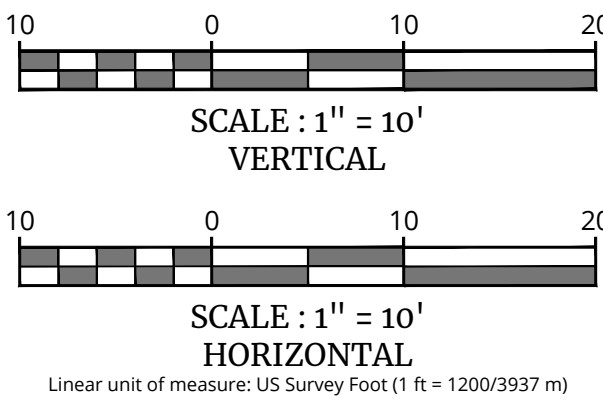
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HORIZONTAL : 1" = 10'
VERTICAL : 1" = 10'



CROSS SECTION OF CONSTRUCTION BASELINE
STATION: 6+00
HORIZONTAL : 1" = 10'
VERTICAL : 1" = 10'

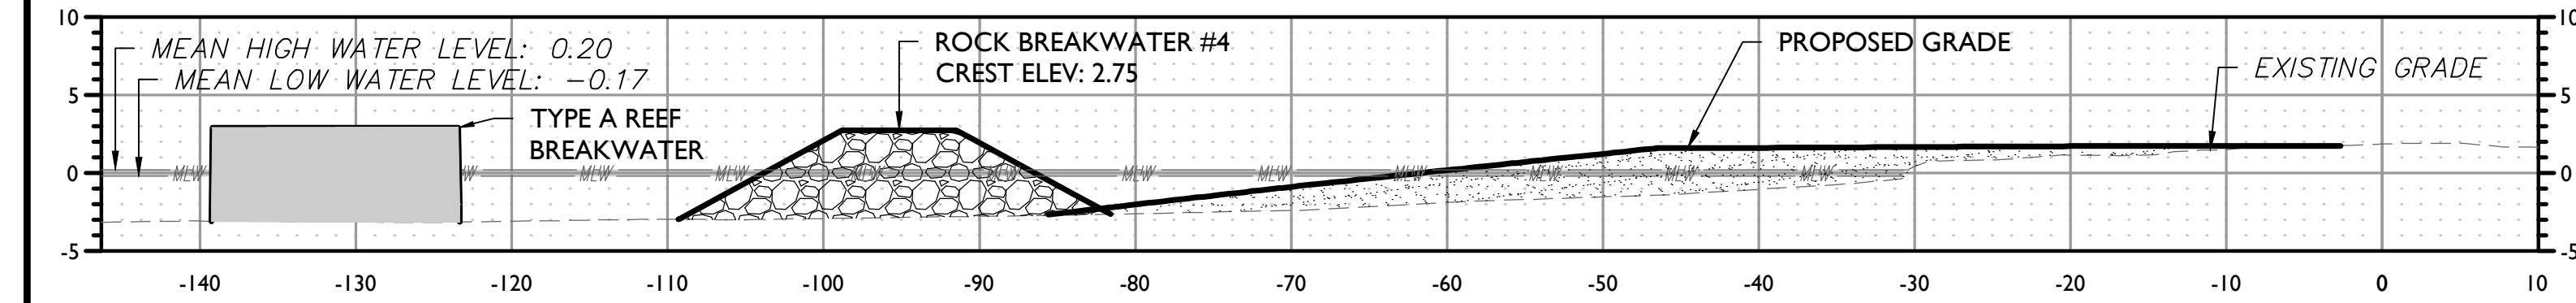

CROSS SECTION OF CONSTRUCTION BASELINE
STATION: 6+50
HORIZONTAL : 1" = 10'
VERTICAL : 1" = 10'

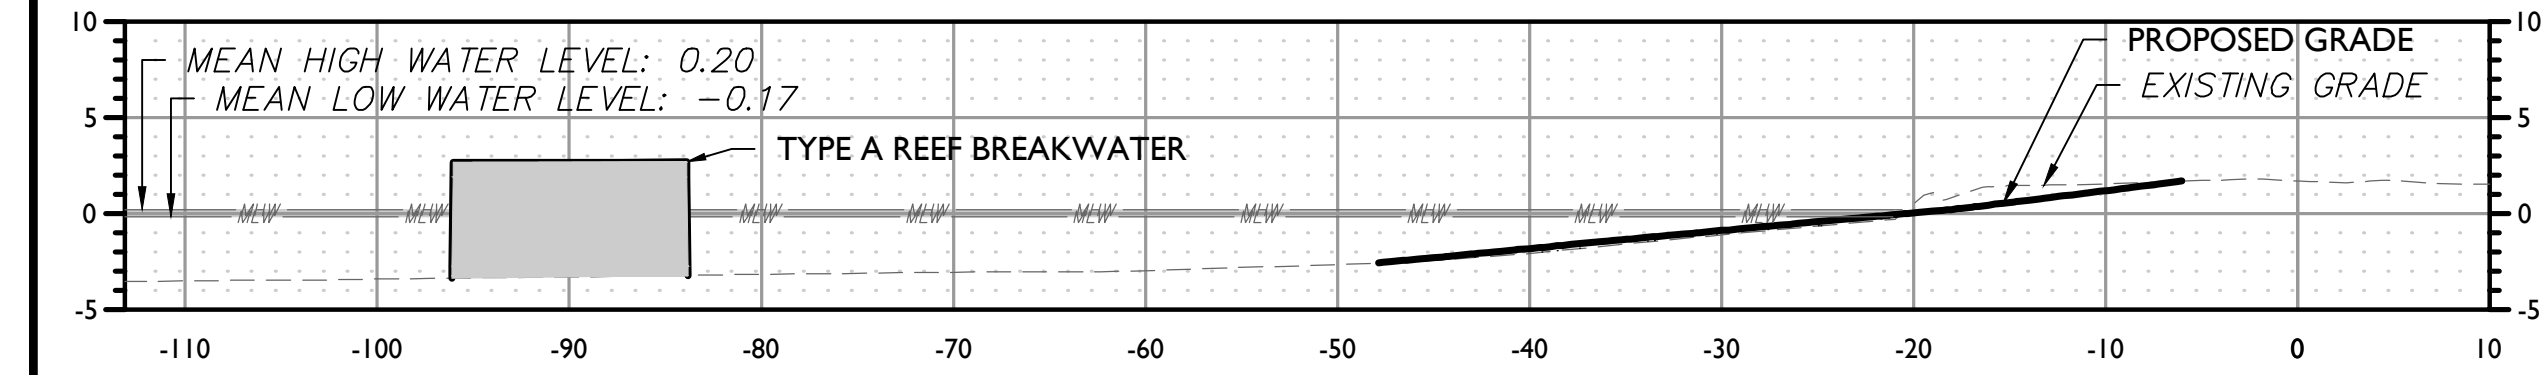

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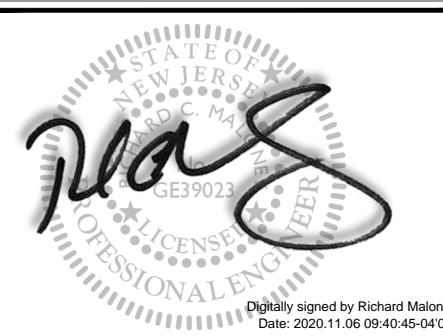
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DATE: 02/29/2024
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DRAWING NAME: C-XSEC

SHEET TITLE:
TYPICAL SECTIONS

SHEET NUMBER:
7 of 9

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714 LACEY ROAD, FORKED RIVER, NJ 08731, (609) 971-7002, FAX: (609) 971-3391,
EMAIL: INFO@SOILDISTRICT.ORG.
VERSION: FEBRUARY 19, 2019



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DTL DATE

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