

PUBLIC NOTICE

REQUEST FOR PERMISSION TO ALTER U.S. ARMY CORPS OF ENGINEERS PROJECTS UNDER SECTION 408

TITLE: Atlantic Shores Offshore Wind, LLC – Offshore Wind Turbine Energy Generation Project – Atlantic County and Monmouth County, New Jersey

PUBLIC NOTICE IDENTIFICATION NUMBER: NAP-2019-01069-84

PUBLIC NOTICE COMMENT PERIOD:

Begins: **30 January 2023**

Expires: **01 March 2023**

Interested parties are hereby notified that an application has been received for a Department of the Army Section 408 permission for certain work at or near a federal project of the United States, as described below and shown on attached figures. Written comments are being solicited from anyone having an interest in the requested alteration. Comments will become part of the U.S. Army Corps of Engineers' (USACE's) administrative record and will be considered in determining whether to approve the request. Comments supporting, opposing, or identifying concerns that should be considered by the USACE in its decision process are all welcome.

This public notice is not a paid advertisement and is for public information only. Issuance of this notice does not imply USACE endorsement of the project as described.

1. REQUESTOR: In compliance with 33 USC 408 (Section 14 of the Rivers and Harbors Act of 1899; hereinafter Section 408), Atlantic Shores Offshore Wind, LLC has requested permission to construct, operate, and maintain the Atlantic Shores Offshore Wind Energy Generation Project pursuant to Bureau of Ocean Energy Management (BOEM) requirements for the "Atlantic Shores Lease Area OCS-A 0499 (South)".

2. LOCATION: The proposed offshore wind turbine energy generation area is located in the Atlantic Ocean approximately 8.70-miles (7.56-nautical miles) from the Atlantic County, New Jersey shoreline. Electric utility cable routes from the offshore wind turbine area, as well as substations and grid connections, would be sited within Atlantic City, the City of Pleasantville, and Egg Harbor Township within Atlantic County, New Jersey; and the Boroughs of Sea Girt and Manasquan, and Wall and Howell Townships within Monmouth County, New Jersey. An Operations and Maintenance (O&M) facility located between North Maryland Avenue and Clam Creek in Atlantic City, New Jersey is also proposed.

The subject project would occupy/alter the following Federal Civil Works Projects sited along New Jersey's Atlantic Ocean coastline and back bay areas:

- A) Offshore Federal Civil Works Sand Resource/Borrow Areas.
- B) Absecon Island Coastal Storm Risk Management Federal Civil Works Project.
- C) Sea Bright to Manasquan, New Jersey Coastal Risk Management and Erosion Control Federal Civil Works Project.
- D) Inside Thorofare portion of the Intracoastal Waterway Federal Navigation Project.
- E) New Jersey Back Bays Coastal Storm Risk Management Federal Study Area.

The subject project would be sited proximate to the following Federal Civil Works Projects which are being evaluated by USACE for their potential to be occupied/alter by the subject project:

- A) Manasquan Inlet and River Federal Navigation Project.
- B) Clam Creek portion of the Absecon Inlet Federal Navigation Project.

3. LOCATION MAP(S)/DRAWING(S): Please see attached Project Plan Sheets 1 through 33.

4. REQUESTER'S PROPOSED ACTION: Construct, operate, and maintain the Atlantic Shores Offshore Wind Energy Generation Project pursuant to Bureau of Ocean Energy Management (BOEM) requirements for the "Atlantic Shores Lease Area OCS-A 0499 (South)". The subject project would occupy/alter the following Federal Civil Works Projects as follows:

- A) Offshore Federal Civil Works Sand Resource/Borrow Areas – Atlantic Export Cable Corridor (ECC) and Monmouth ECC crossing beneath existing offshore sand resource/borrow areas via hydro or jet plow installation. Please refer to Project Plan Sheets 1 through 7.
- B) Absecon Island Coastal Storm Risk Management Federal Civil Works Project - Atlantic ECC landfall crossing beneath Federal project via the Horizontal Directional Drilling (HDD) method. Please refer to Project Plan Sheets 8, 12, and 13.
- C) Sea Bright to Manasquan, New Jersey Coastal Risk Management and Erosion Control Federal Civil Works Project - Monmouth ECC landfall crossing beneath Federal project via the HDD method. Please refer to Project Plan Sheet 10.
- D) Inside Thorofare portion of the Intracoastal Waterway Federal Navigation Project. Atlantic ECC crossing beneath Federal Navigation Channel via the HDD method. Please refer to Project Plan Sheets 14, 15, and 16.

- E) New Jersey Back Bays Coastal Storm Risk Management Federal Study Area. Atlantic ECC crossing beneath Federal Study Area via the HDD method. Please refer to Project Plan Sheets 8 through 33.

The subject project would be sited outside of, but proximate to, the following Federal Civil Works Projects which are being evaluated by USACE for their potential to be occupied/alterated by the subject project:

- A) Manasquan Inlet and River Federal Navigation Project. Please refer to Project Plan Sheet 11.
- B) Clam Creek portion of the Absecon Inlet Federal Navigation Project. Proposed Operations and Maintenance (O&M) Facility and dredging. Please refer to Project Plan Sheet 9.

5. REGULATORY AUTHORITY: This request will be reviewed according to the provisions of Section 14 of the Rivers and Harbors Act of 1899 (33 U.S.C. 408). A requestor has the responsibility to acquire all other permissions or authorizations required by federal, state, and local laws or regulations, including any required permits from the USACE Regulatory Program under Section 10 of the Rivers and Harbors Act of 1899 (33 USC 403), Section 404 of the Clean Water Act (33 USC Section 1344) and/or Section 103 of the Marine Protection, Research and Sanctuaries Act of 1972 (33 USC 1413). Any Section 10/404/103 permit decision associated with the proposed alteration is separate from and will not be included in the Section 408 permission decision. An approval under Section 408 does not grant any property rights or exclusive privileges nor does it authorize any injury to the property or rights of others.

6. ENVIRONMENTAL COMPLIANCE: A decision on a Section 408 request is a federal action, and therefore subject to the National Environmental Policy Act (NEPA) and other environmental compliance requirements. While ensuring compliance is the responsibility of USACE, the requester is providing all information that the Philadelphia District identifies as necessary to satisfy all applicable federal laws, executive orders, regulations, policies, and ordinances. Based on information provided by the applicant to date, current Corps regulations governing NEPA implementation, and/or the contents of existing NEPA documentation if available, it is likely that the proposed action will be determined to be categorically excluded from the need to prepare an Environmental Assessment (EA) or Environmental Impact Statement (EIS). This determination will be finalized following completion of agency coordination and prior to issuance of the Section 408 Permission Decision.

7. EVALUATION: As part of its evaluation, USACE will first make a determination that the submittal from the requestor is complete. The Philadelphia District is working closely with the requestor to ensure that all required technical plans, maps, drawings, and specifications are provided and are complete. Once the package is complete, a District-led review will be conducted to determine, in accordance with Engineering Circular (EC) 1165-2-216, whether the proposed alteration will impair the usefulness of the USACE Project or be injurious to the public interest, as follows:

- A. *Impair the Usefulness of the Project Determination.* The Philadelphia District's Section 408 review team will determine if the proposed alteration will limit the ability of the federally authorized project to function as authorized, or will compromise or change any authorized project conditions, purposes or outputs.
- B. *Injurious to the Public Interest Determination.* Proposed alterations will be reviewed to determine the probable impacts, including cumulative impacts, on the public interest. Evaluation of the probable impacts that the proposed alteration to the USACE project may have on the public interest requires a careful weighing of all those factors that are relevant in each particular case. Factors that may be relevant to the public interest depend upon the type of USACE project being altered and may include, but are not limited to, such things as conservation, economic development, historic properties, cultural resources, environmental impacts, water supply, water quality, flood hazards, floodplains, residual risk, induced damages, navigation, shore erosion or accretion, and recreation. The decision whether to approve an alteration will be determined by the consideration of whether benefits are commensurate with risks. If the potential detriments are found to outweigh the potential benefits, then it may be determined that the proposed alteration is injurious to the public interest.

8. SOLICITATION OF COMMENTS: The USACE is soliciting comments from the public; federal, state, and local agencies and officials; Indian Tribes; and other interested parties in order to consider and evaluate the impacts of the proposed activity. Any comments received will be considered by USACE to determine whether to issue, modify, condition, or deny a permission for this proposal. To make this decision, comments are used to assess impacts on endangered species, historic properties, water quality, general environmental effects, and other public interest factors listed above. Comments are considered in making a final determination whether the proposed action will be categorically excluded from the need to prepare further NEPA documentation. Comments are also used to determine the need for a public hearing and to determine the overall public interest of the proposed activity.

- A. It should be noted that materials submitted as part of the Section 408 request become part of the public record and are thus available to the general public under the procedures of the Freedom of Information Act (FOIA). Individuals may submit a written request to the Philadelphia District Corps of Engineers, Office of Counsel to obtain copies of said materials under the FOIA.
- B. It is presumed that all parties viewing this notice will wish to respond to this public notice; therefore, a lack of response will be interpreted as meaning that there is no objection to the project as described.

9. COMMENT SUBMISSION AND ADDITIONAL INFORMATION: Written comments on the described work should reference the USACE Public Notice Identification Number found on the first page of this notice. Comments must reach this office no later than the stated expiration date of the Public Notice to become part of the record and be considered in the decision. Comments or requests for additional information should be mailed or emailed to the following address:

Email: JuanCarlos.Corona@usace.army.mil

Mailing Address:

U.S. Army Corps of Engineers

Philadelphia District


Attn: Juan Carlos Corona

100 South Independence Mall West, 2nd Floor

Philadelphia, PA 19106-3400

Project Plan Sheet 1

Figure 1. Atlantic Export Cable Corridor Offshore Project Overview

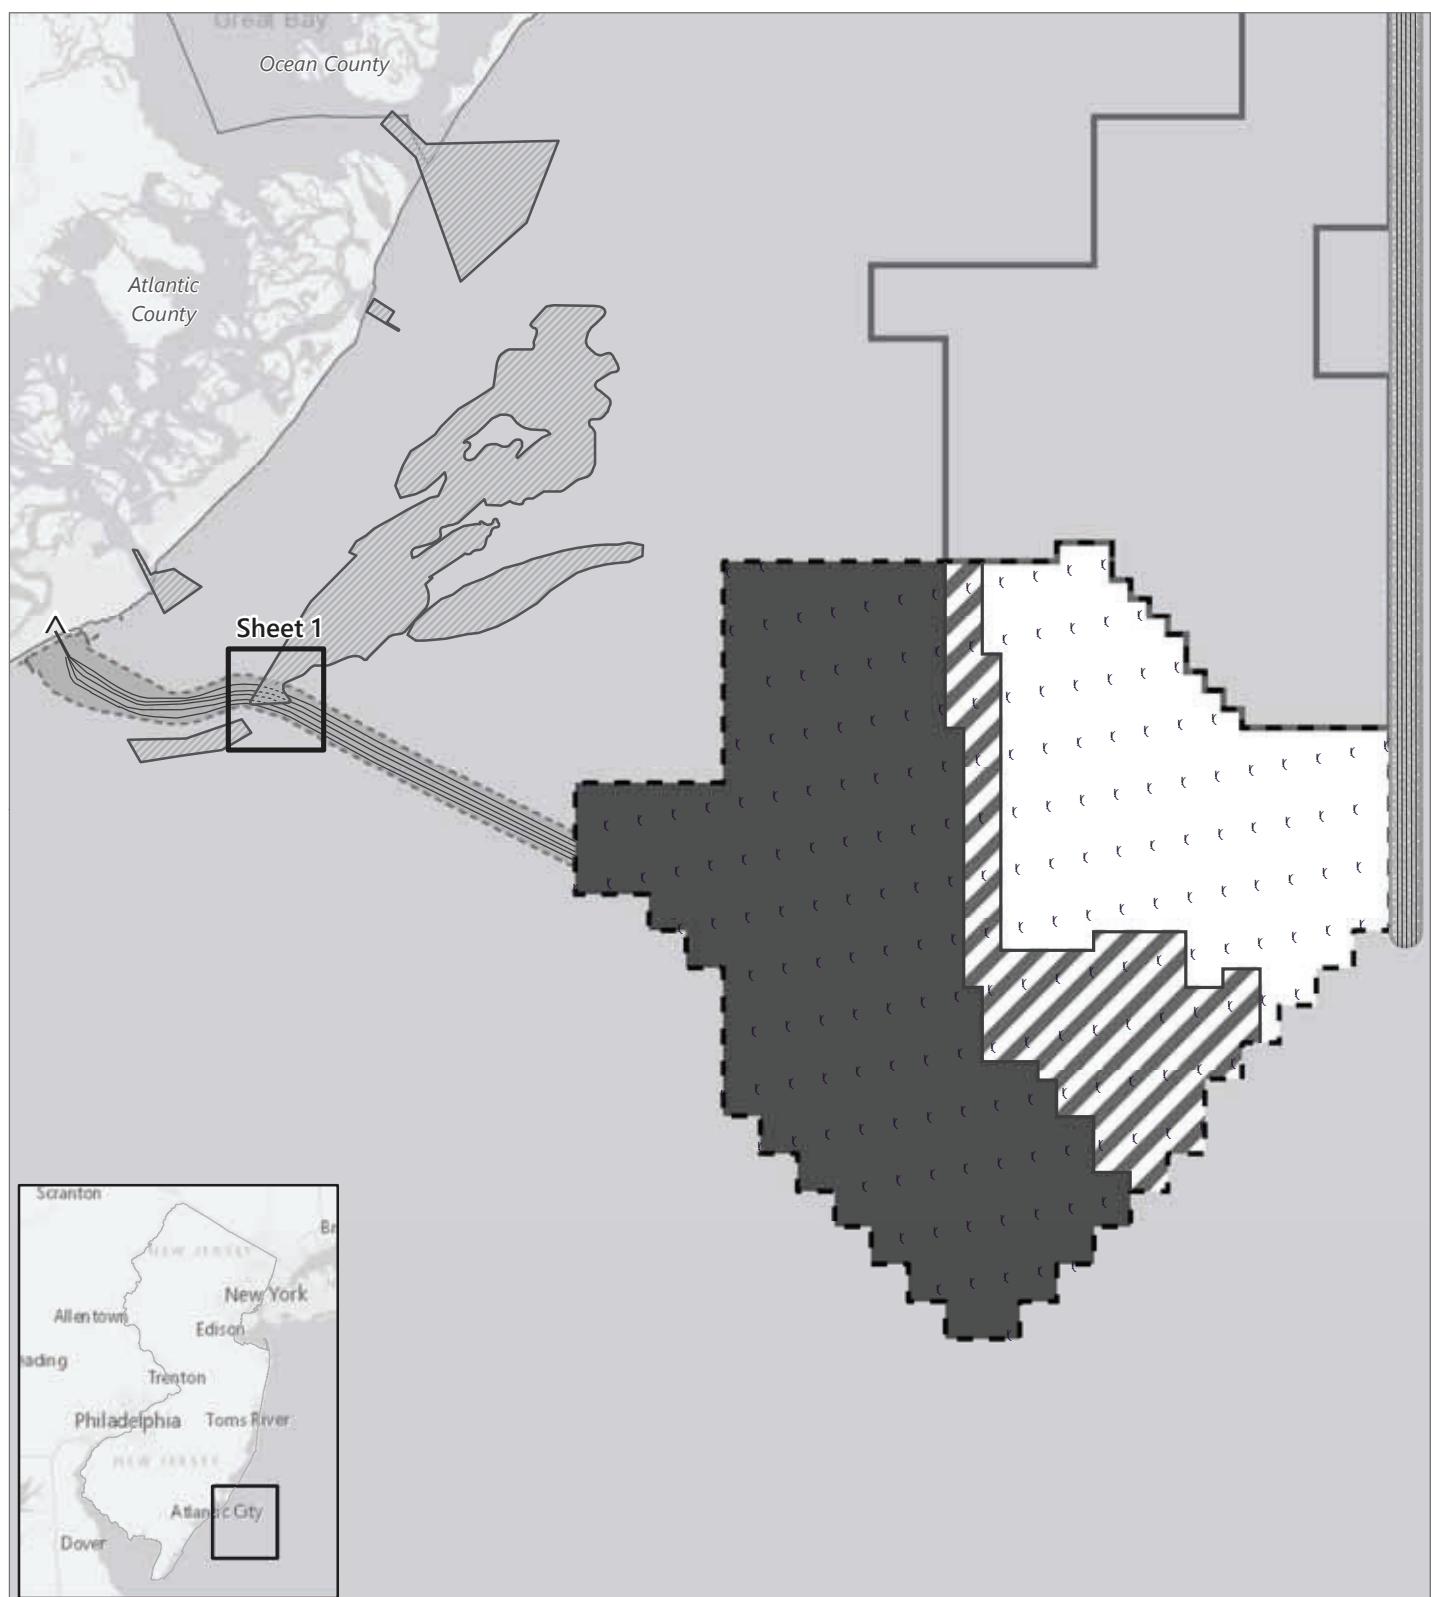

Atlantic Shores Offshore Wind

Philadelphia District

USACE Section 408 Permit

EDR

- ▲ Atlantic Landfall Site
- ✗ Wind Turbine Generators
- Submarine Export Cable
- Atlantic Export Cable Corridor
- Monmouth Export Cable Corridor
- ▨ Sand Resource Area

- Atlantic Shores Wind Turbine Area
- Atlantic Shores Lease Area OCS-A 0549
- Project 1 Area
- Project 2 Area
- ▨ Overlap Area (Project 1 or 2)

0 1 2 4
Miles


Prepared January 20, 2023

Note: For illustrative purposes only
Basemap: Esri "World Light Gray Canvas" map service

Project Plan Sheet 2

Figure 1. Atlantic Export Cable Corridor Offshore Project Overview

Sheet 1

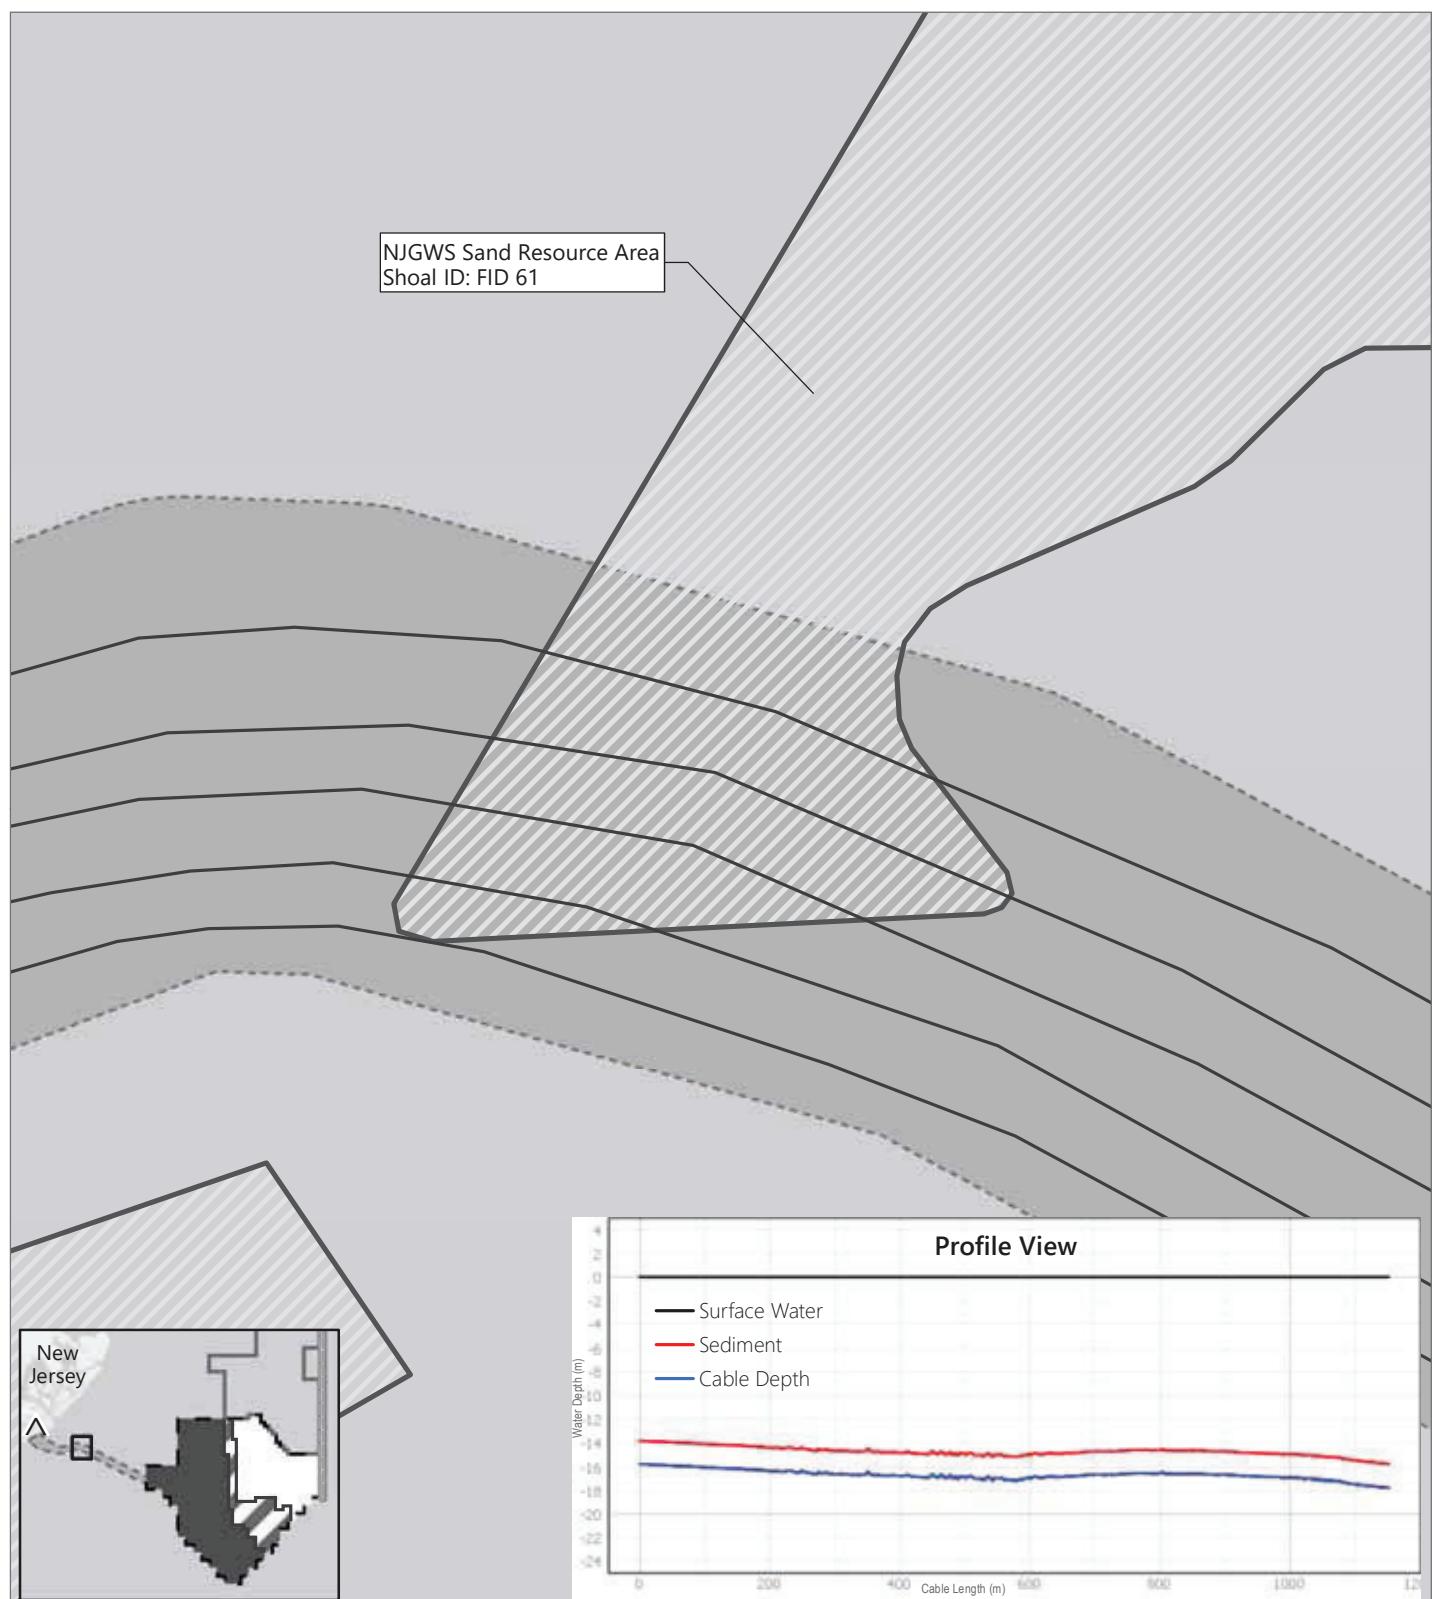

Atlantic Shores Offshore Wind


Philadelphia District

USACE Section 408 Permit

EDR

- ▲ Atlantic Landfall Site
- Submarine Export Cables
- Sand Resource Area
- Atlantic Export Cable Corridor

- Monmouth Export Cable Corridor
- Atlantic Shores Wind Turbine Area
- Project 1 Area
- Project 2 Area
- Overlap Area (Project 1 or 2)

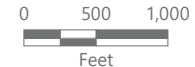


Prepared January 20, 2023

Note: For illustrative purposes only
Basemap: Esri "World Light Gray Canvas" map service

Project Plan Sheet 3

Figure 2. Monmouth Export Cable Corridor Offshore Project Overview

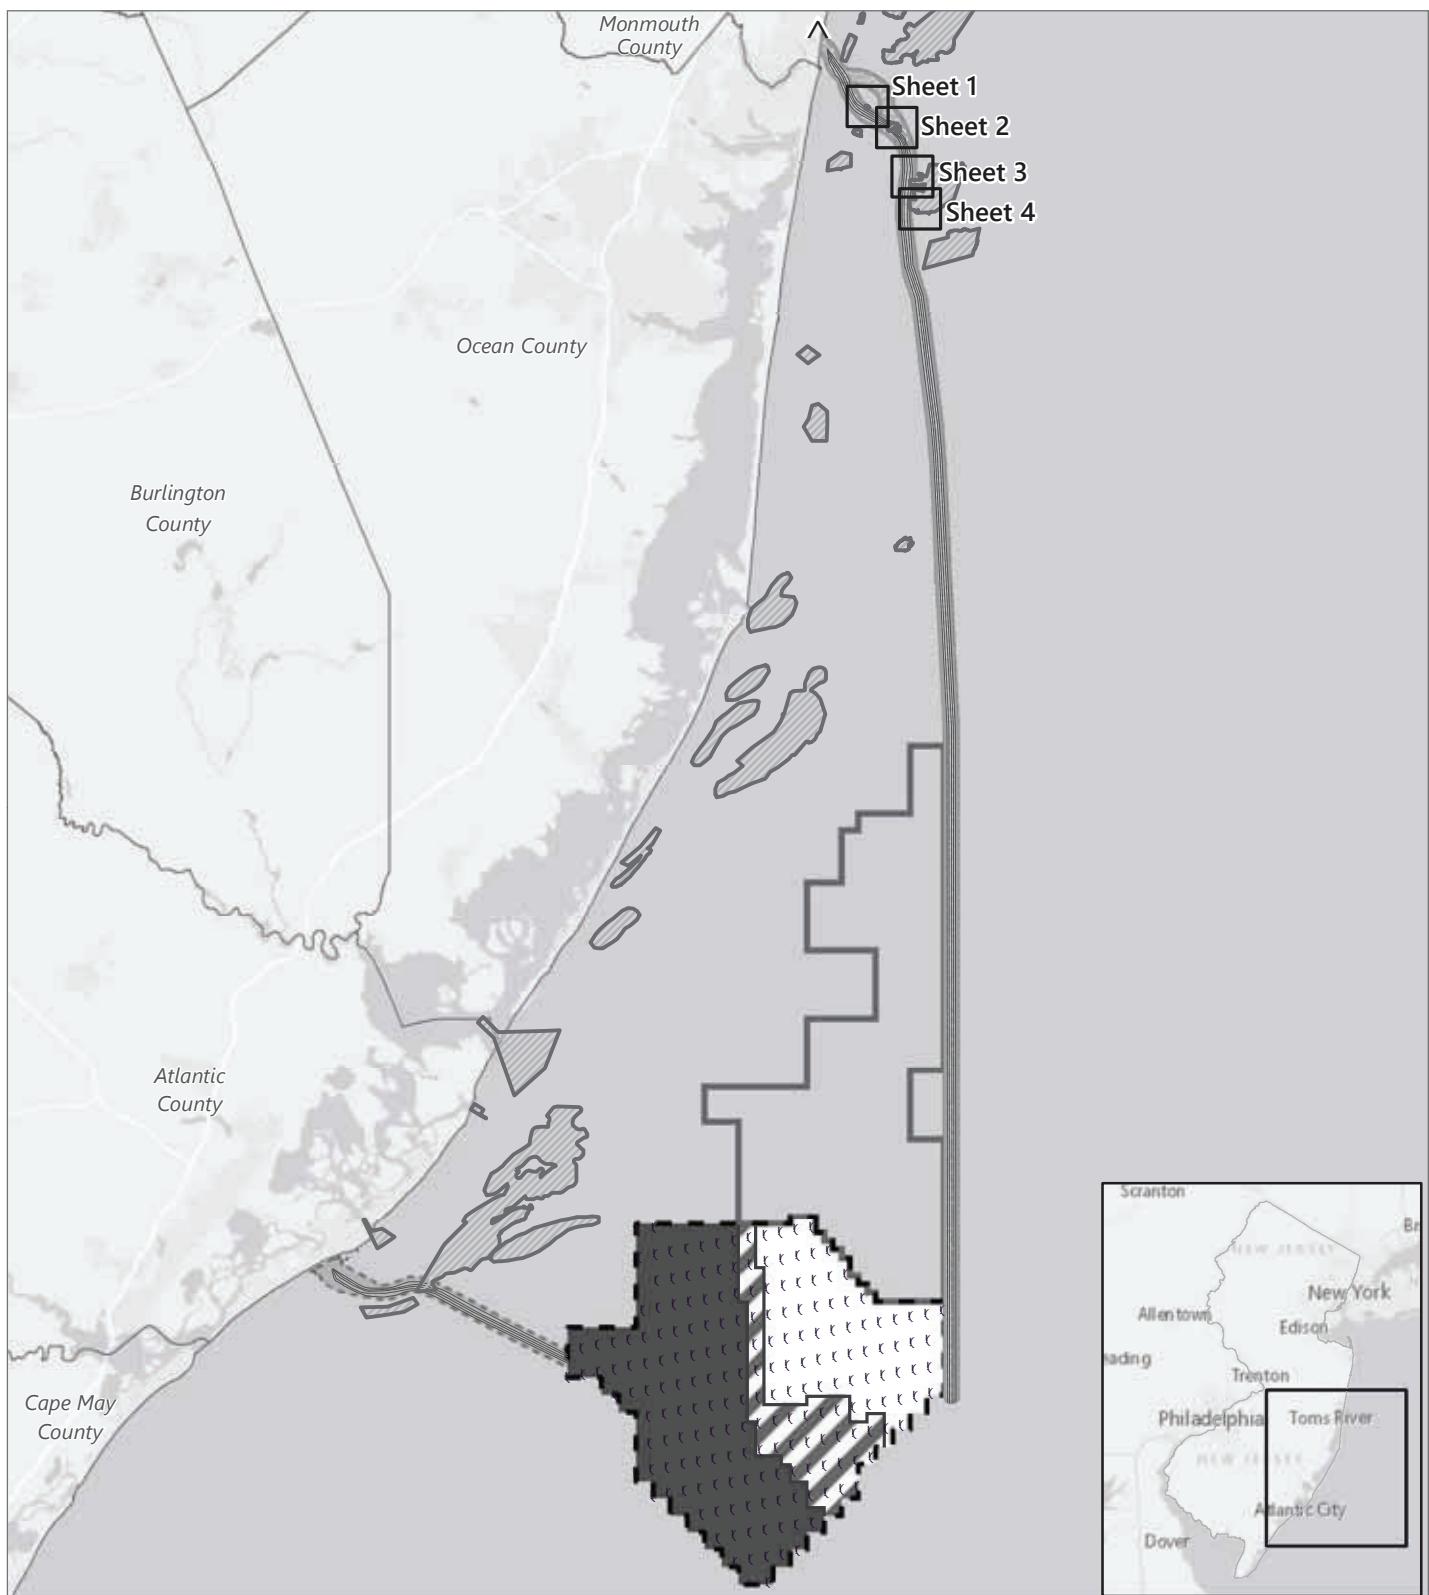

Atlantic Shores Offshore Wind

Philadelphia District

USACE Section 408 Permit

EDD

- ▲ Monmouth Landfall Site
 - Wind Turbine Generators
 - Submarine Export Cable
 - Atlantic Export Cable Corridor
 - Monmouth Export Cable Corridor
 - Sand Resource Area

-  Atlantic Shores Wind Turbine Area
 -  Atlantic Shores Lease Area OCS-A 0549
 -  Project 1 Area
 -  Overlap Area (Project 1 or 2)


A horizontal number line with tick marks at 0, 2, 4, and 8. The segment between 1 and 4 is shaded in gray.

Miles
Prepared January 20, 2023
Note: For illustrative purposes only.

Project Plan Sheet 4

Figure 2. Monmouth Export Cable Corridor Sand Resource Area

Sheet 1 of 4

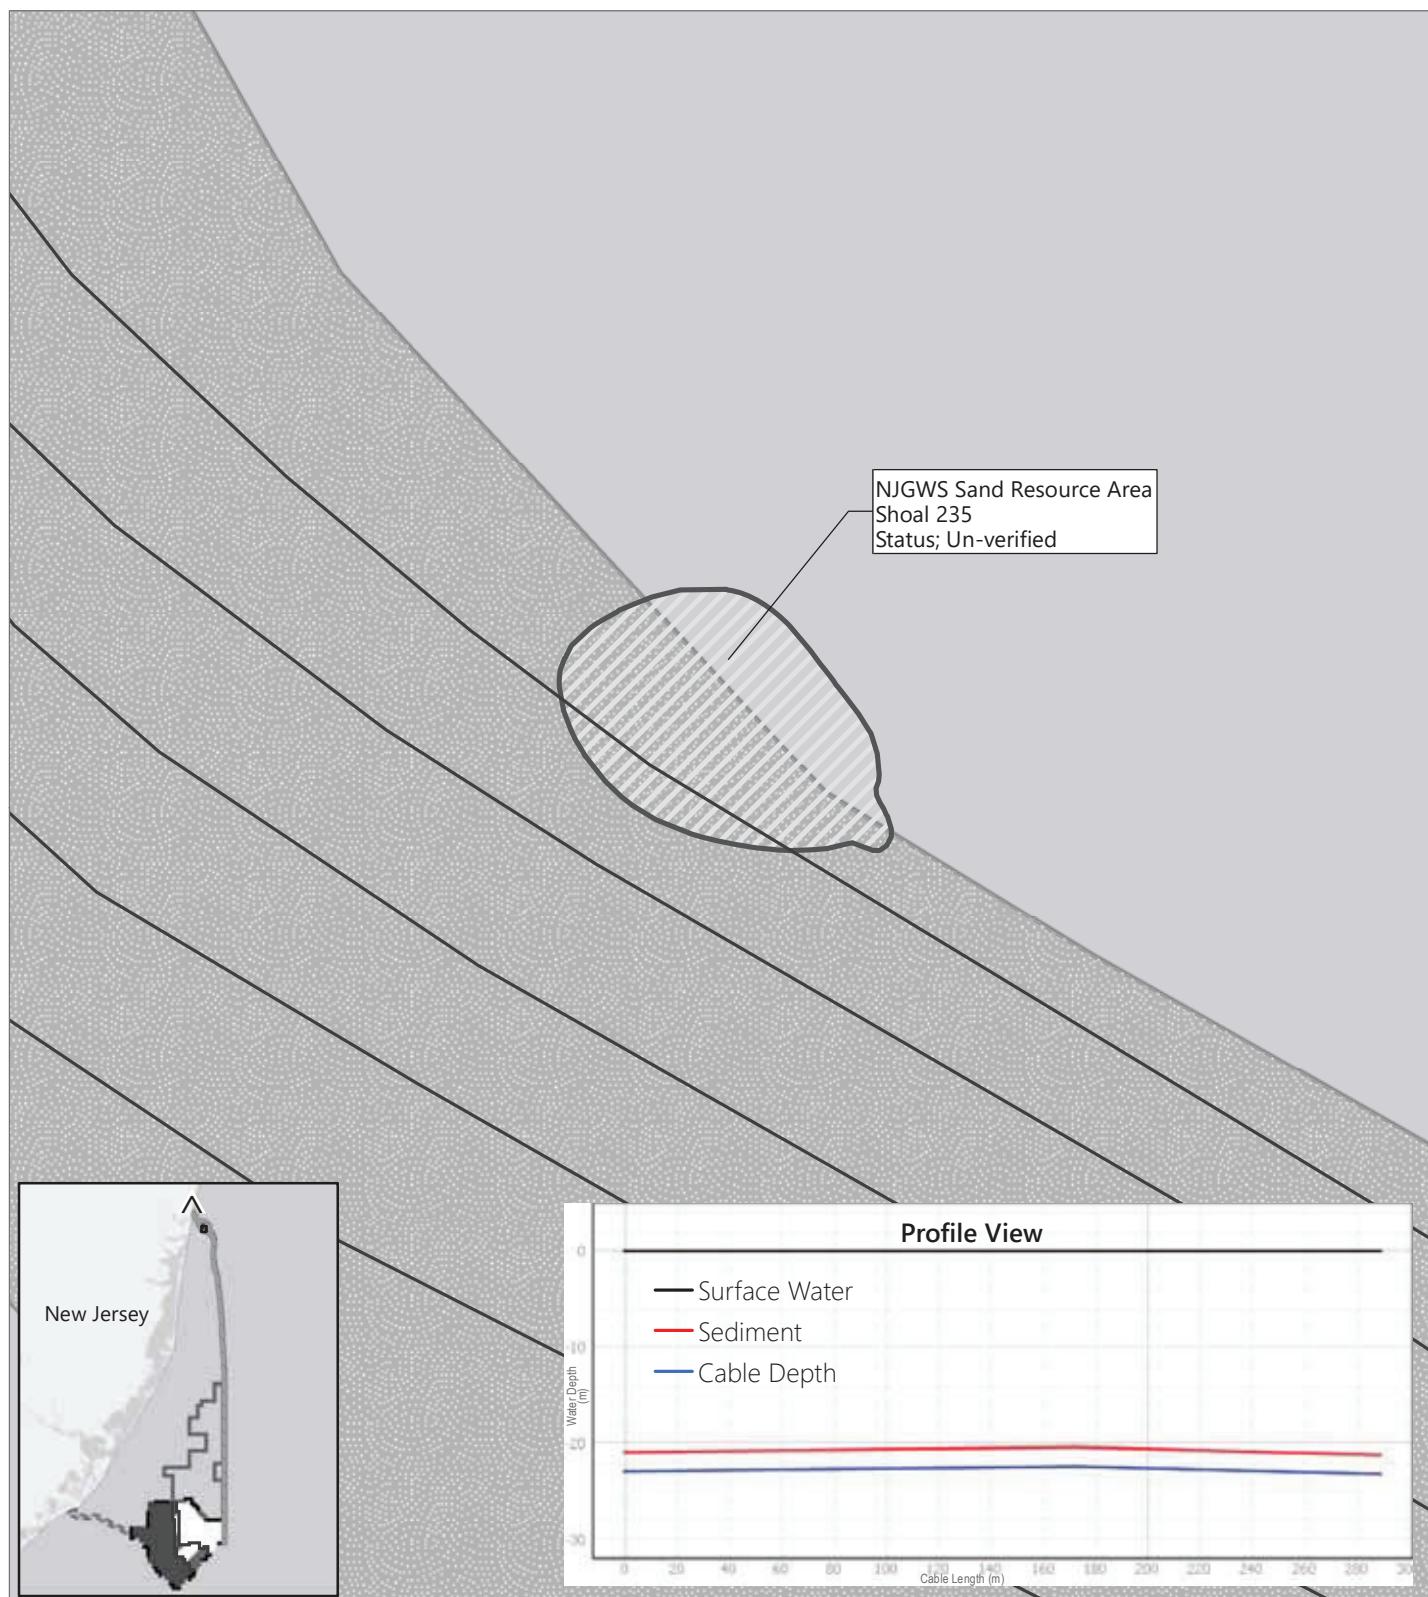

**Atlantic Shores
Offshore Wind**
Philadelphia District
USACE Section 408 Permit

- ▲ Monmouth Landfall Site
- Submarine Export Cable
- ▨ Sand Resource Area
- ▨ Monmouth Export Cable Corridor

- ▨ Atlantic Export Cable Corridor
- ▨ Atlantic Shores Wind Turbine Area
- ▨ Atlantic Shores Lease Area OCS-A 0549
- Project 1 Area
- Project 2 Area
- ▨ Overlap Area (Project 1 or 2)

0 250 500
Feet


Prepared January 20, 2023

Note: For illustrative purposes only
Basemap: Esri "World Light Gray Canvas" map service

Project Plan Sheet 5

Figure 2. Monmouth Export Cable Corridor Sand Resource Area

Sheet 2 of 4

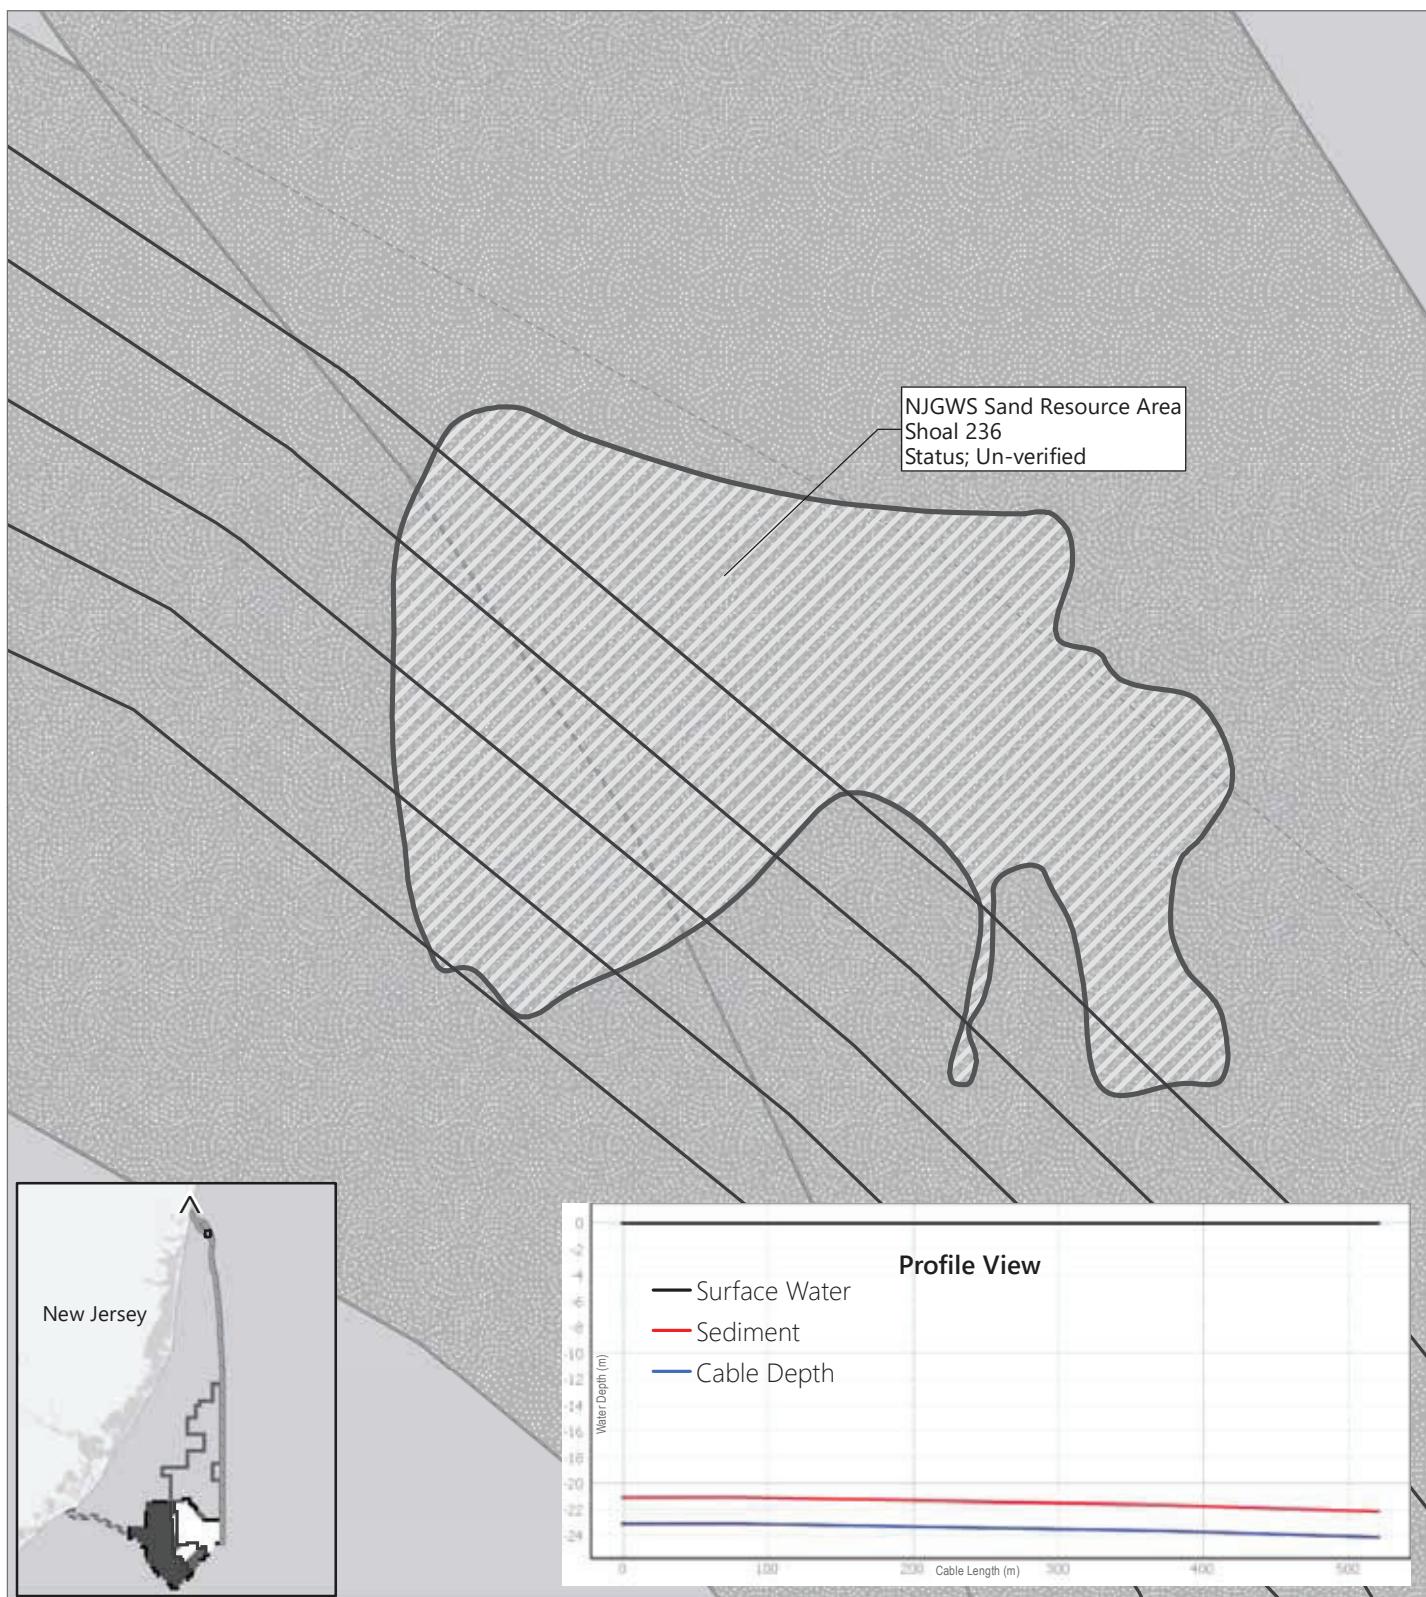

**Atlantic Shores
Offshore Wind**
Philadelphia District
USACE Section 408 Permit

EDR

- ↗ Monmouth Landfall Site
- Submarine Export Cable
- ▨ Sand Resource Area
- ▨ Monmouth Export Cable Corridor

- ▨ Atlantic Export Cable Corridor
- ▨ Atlantic Shores Wind Turbine Area
- ▨ Atlantic Shores Lease Area OCS-A 0549
- Project 1 Area
- Project 2 Area
- ▨ Overlap Area (Project 1 or 2)

0 250 500
Feet


Prepared January 20, 2023

Note: For illustrative purposes only
Basemap: Esri "World Light Gray Canvas" map service

Project Plan Sheet 6

Figure 2. Monmouth Export Cable Corridor Sand Resource Area

Sheet 3 of 4

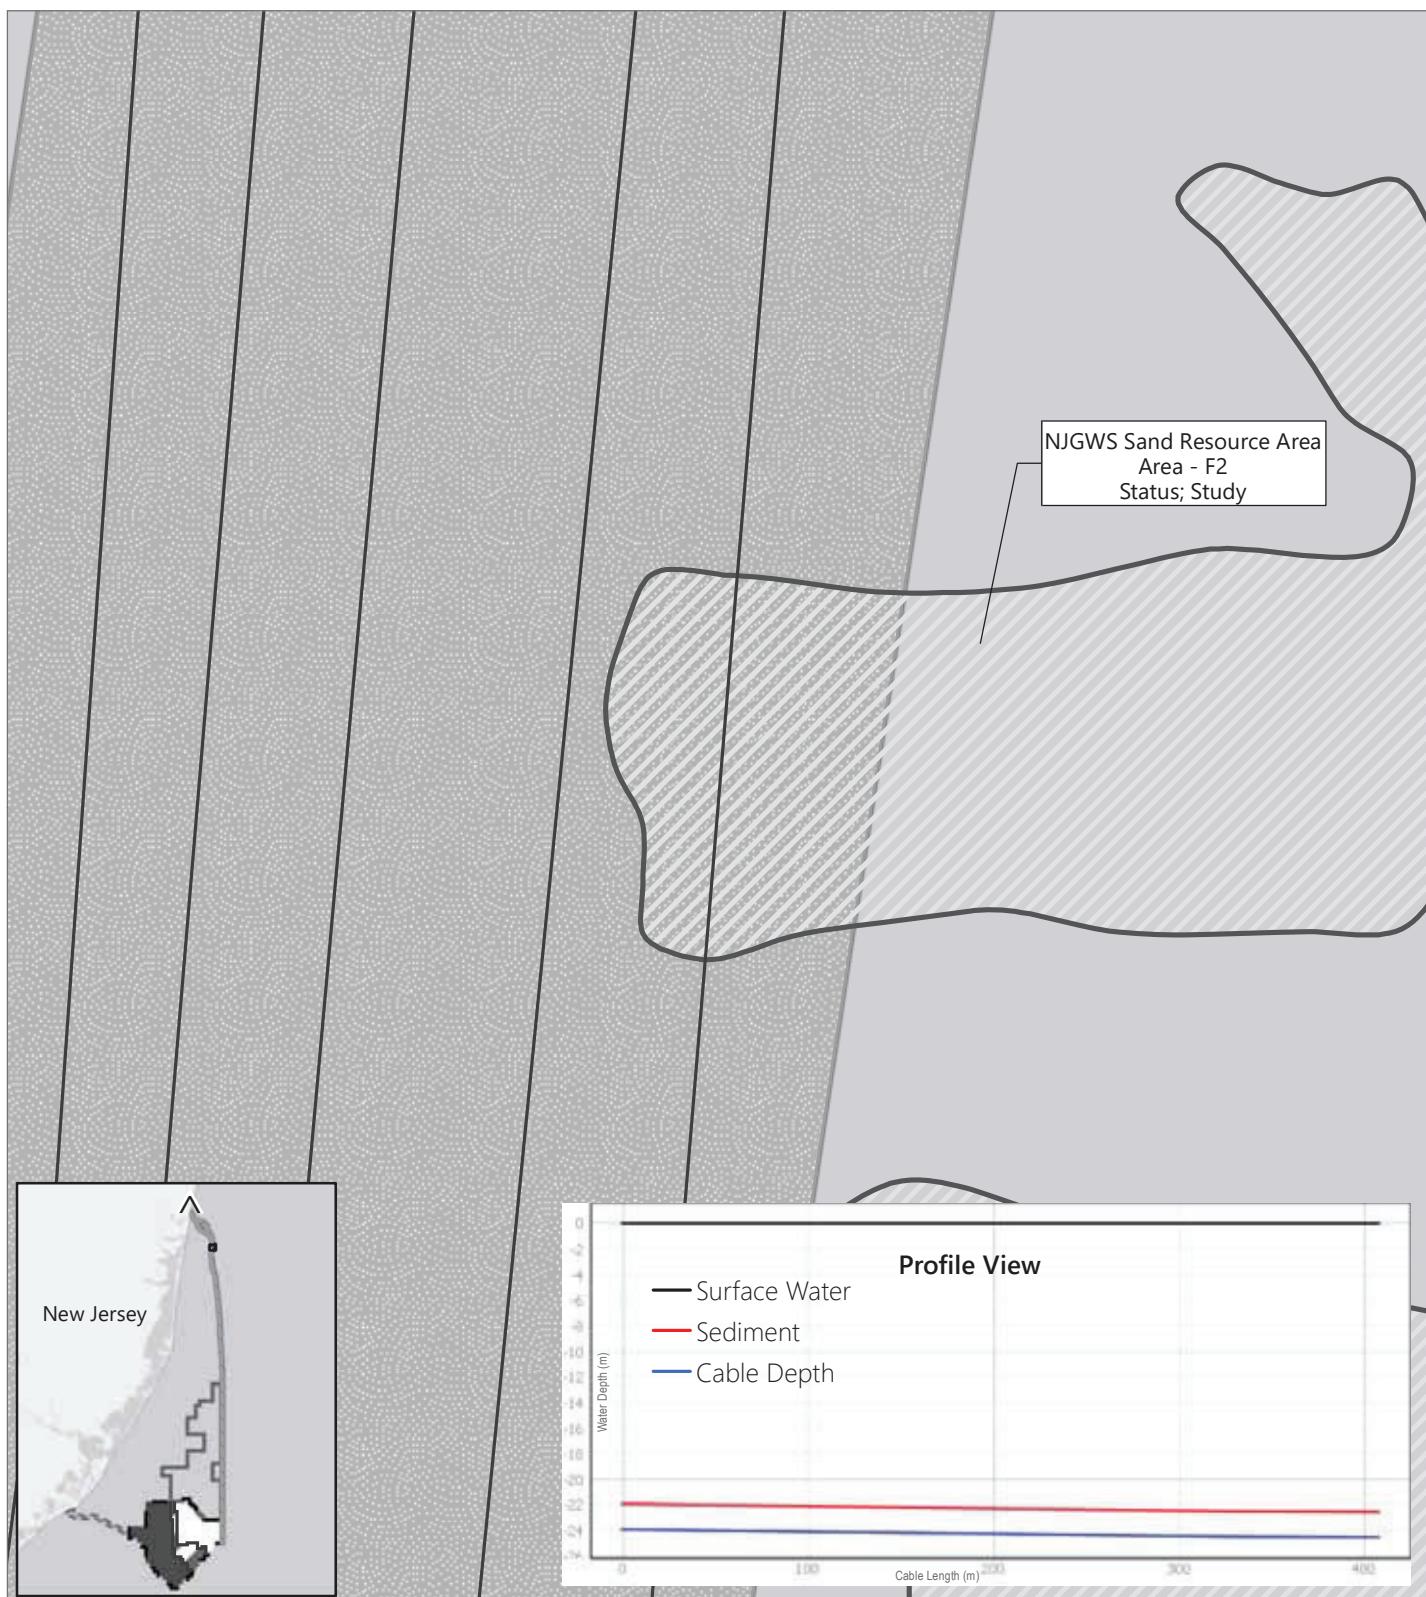

Atlantic Shores Offshore Wind

Philadelphia District

USACE Section 408 Permit

EDR

- Monmouth Landfall Site
- Submarine Export Cable
- Sand Resource Area
- Monmouth Export Cable Corridor

- Atlantic Export Cable Corridor
- Atlantic Shores Wind Turbine Area
- Atlantic Shores Lease Area OCS-A 0549
- Project 1 Area
- Project 2 Area
- Overlap Area (Project 1 or 2)

0 250 500
Feet


Prepared January 20, 2023

Note: For illustrative purposes only
Basemap: Esri "World Light Gray Canvas" map service

Project Plan Sheet 7

Figure 2. Monmouth Export Cable Corridor Sand Resource Area

Sheet 4 of 4

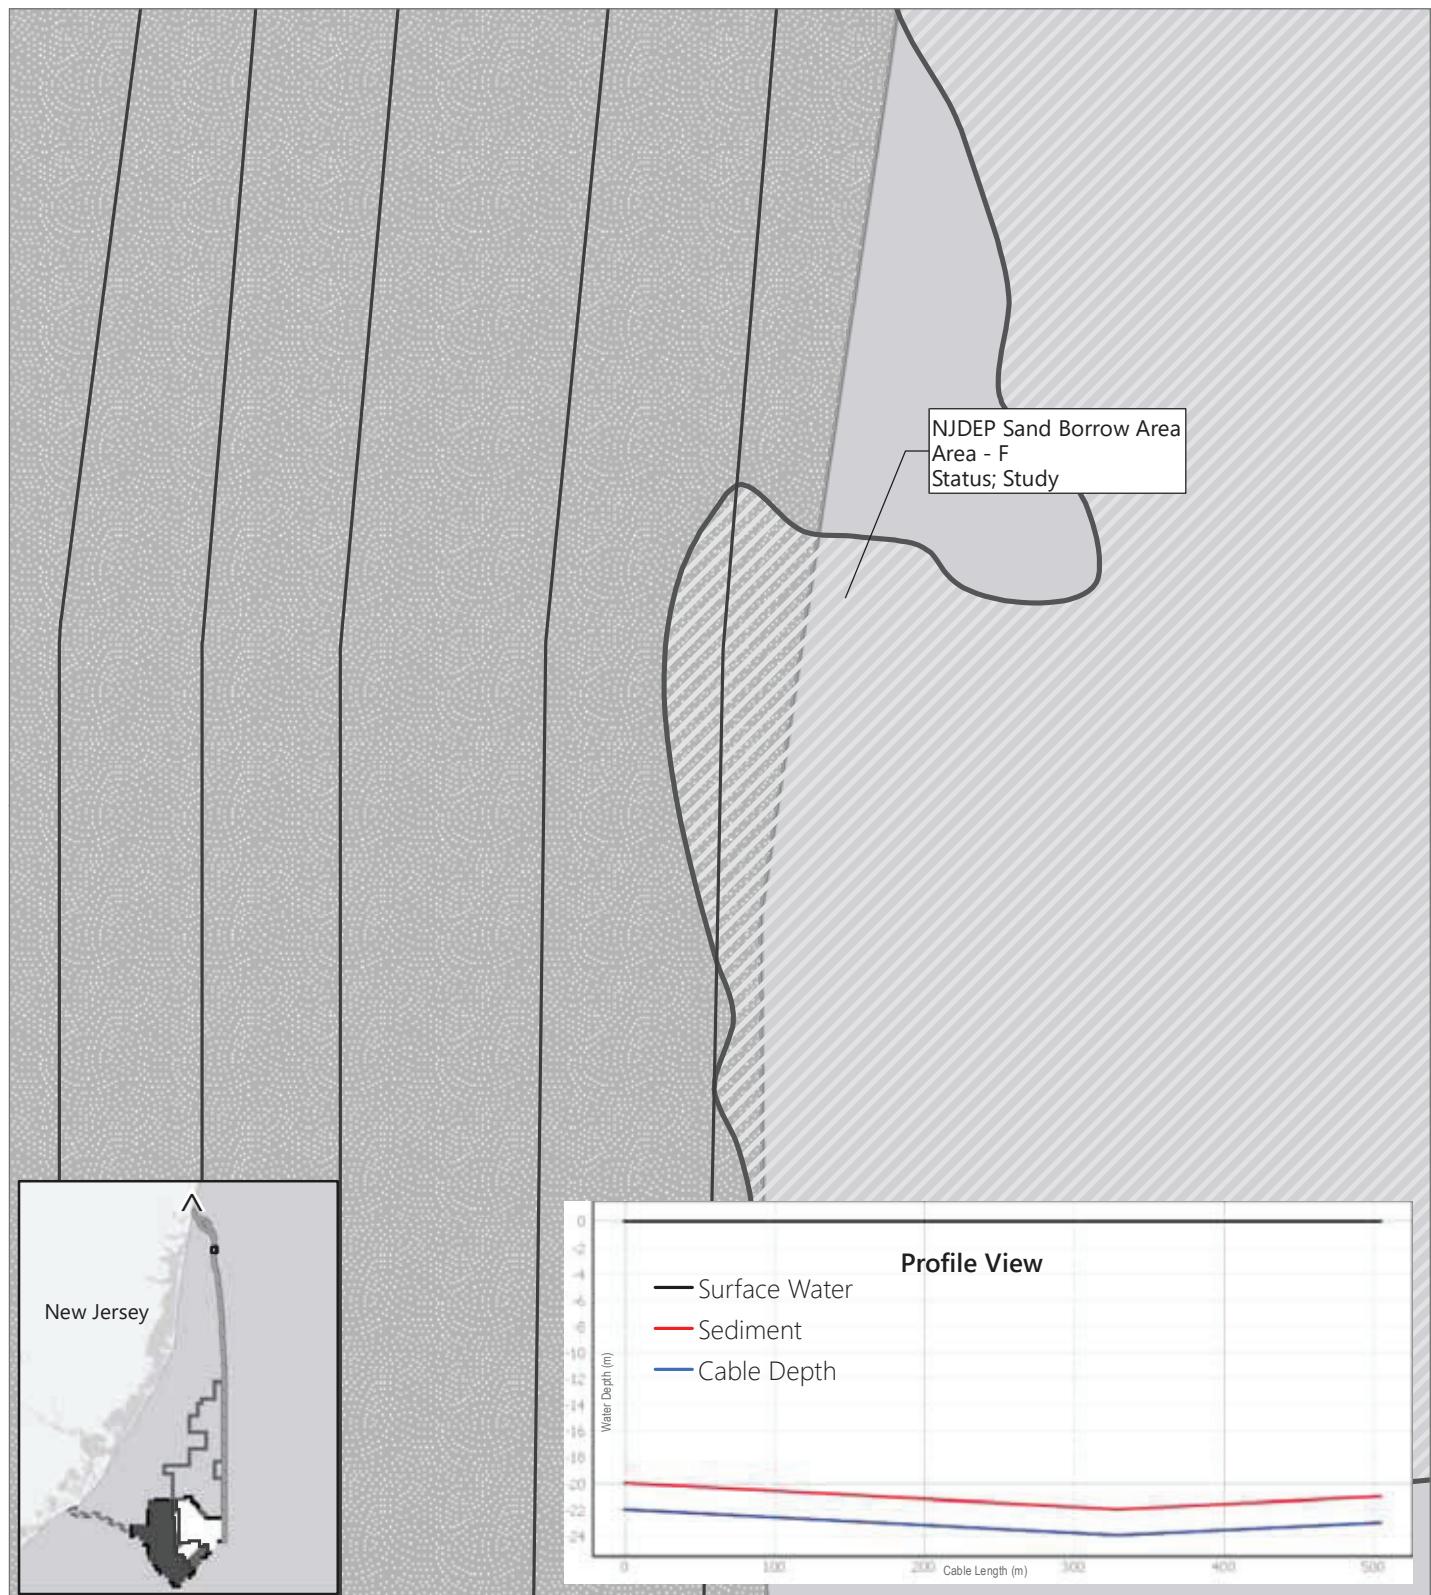

**Atlantic Shores
Offshore Wind**
Philadelphia District
USACE Section 408 Permit

- ▲ Monmouth Landfall Site
- Submarine Export Cable
- ▨ Sand Resource Area
- ▨ Monmouth Export Cable Corridor

- ▨ Atlantic Export Cable Corridor
- ▨ Atlantic Shores Wind Turbine Area
- ▨ Atlantic Shores Lease Area OCS-A 0549
- Project 1 Area
- Project 2 Area
- ▨ Overlap Area (Project 1 or 2)

0 250 500
Feet

Prepared January 20, 2023
Note: For illustrative purposes only
Basemap: Esri "World Light Gray Canvas" map service

EDR

Project Plan Sheet 8

Figure 3. Atlantic Landfall Site



Atlantic Shores Offshore Wind

Philadelphia District

USACE Section 408 Permit

EDR

- ▲ Atlantic Landfall Site
- Atlantic HDD Export Cable
- HDD Entry Point
- Atlantic Onshore Interconnection Cable Route
- HDD Exit Point
- Submarine Export Cable
- Transition Joint Vault
- Atlantic Export Cable Corridor


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Feet

Prepared January 20, 2023

Note: For illustrative purposes only
Basemap: Esri "World Light Gray Canvas" map service

Project Plan Sheet 9

Figure 4. O&M Facility Overview

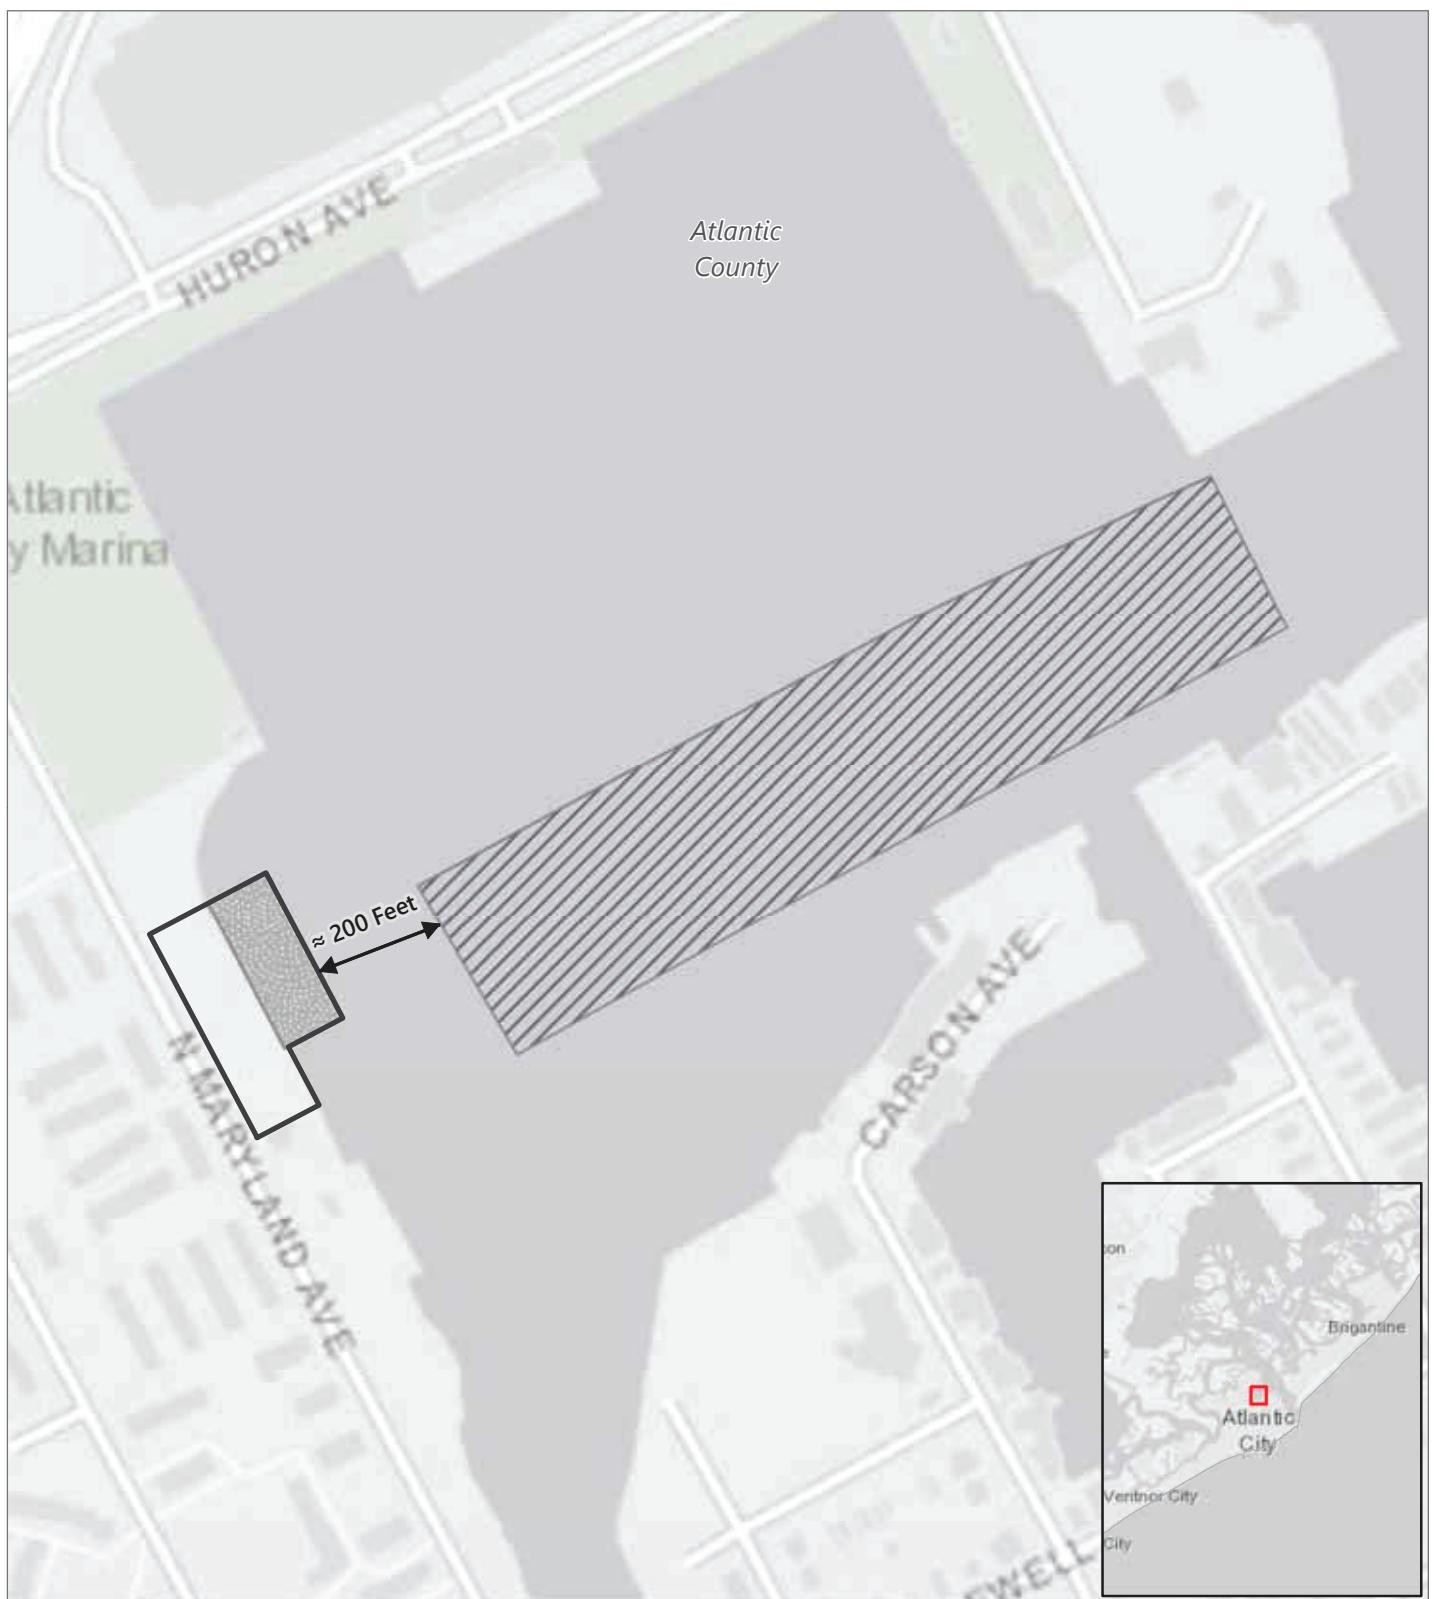

Atlantic Shores Offshore Wind

Philadelphia District

USACE Section 408 Permit

O&M Facility

Dredging Area

Approximate Clam Creek Area


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Feet

Prepared January 20, 2023

Note: For illustrative purposes only
Basemap: Esri "World Light Gray Canvas" map service

Project Plan Sheet 10

Figure 5. Monmouth Landfall Site

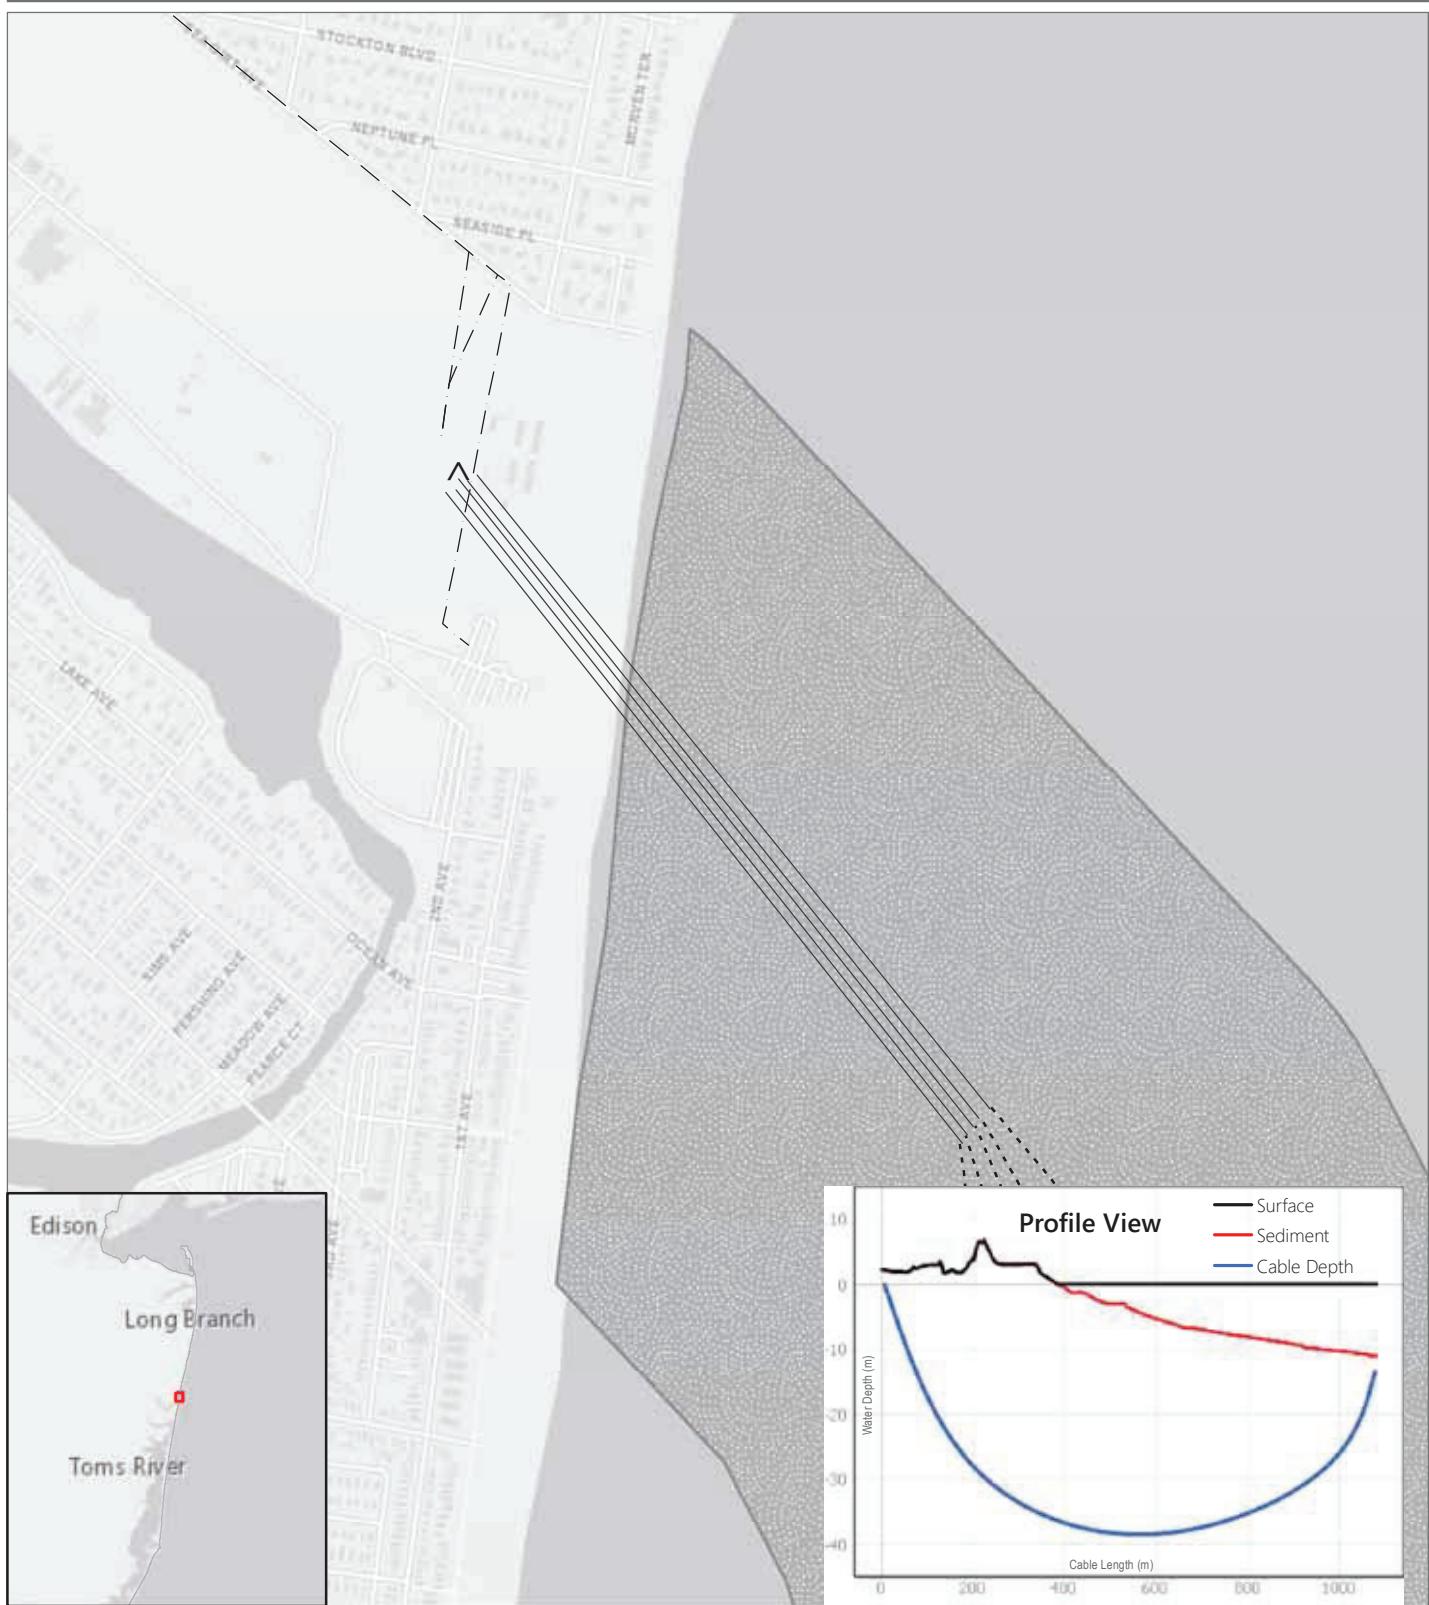

Atlantic Shores Offshore Wind

Philadelphia District

USACE Section 408 Permit

- ▲ Monmouth Landfall Site
 - Monmouth Landfall HDD Cable Route
 - Monmouth Onshore Interconnection Cable Route
 - - - Submarine Export Cable
 - [■] Monmouth Export Cable Corridor

Prepared January 20, 2023

Note: For illustrative purposes only

Basemap: Esri "World Light Gray Canvas" map service

EPR

Project Plan Sheet 11

Figure 6. Federal Navigation Channel for Manasquan



Atlantic Shores Offshore Wind

Philadelphia District

USACE Section 408 Permit

EDR

- ▲ Landfall Site
 - Monmouth HDD Cable Route
 - Monmouth Onshore Interconnection Cable Route
 - - - Submarine Export Cable
 - [Monmouth Export Cable Corridor]
 - [Federal Navigation Channel]
- 0 1,000 2,000 4,000 Feet
- Prepared January 20, 2023
Note: For illustrative purposes only
Basemap: Esri "World Light Gray Canvas" map service

Project Plan Sheet 12

FOR ILLUSTRATIVE PURPOSES ONLY


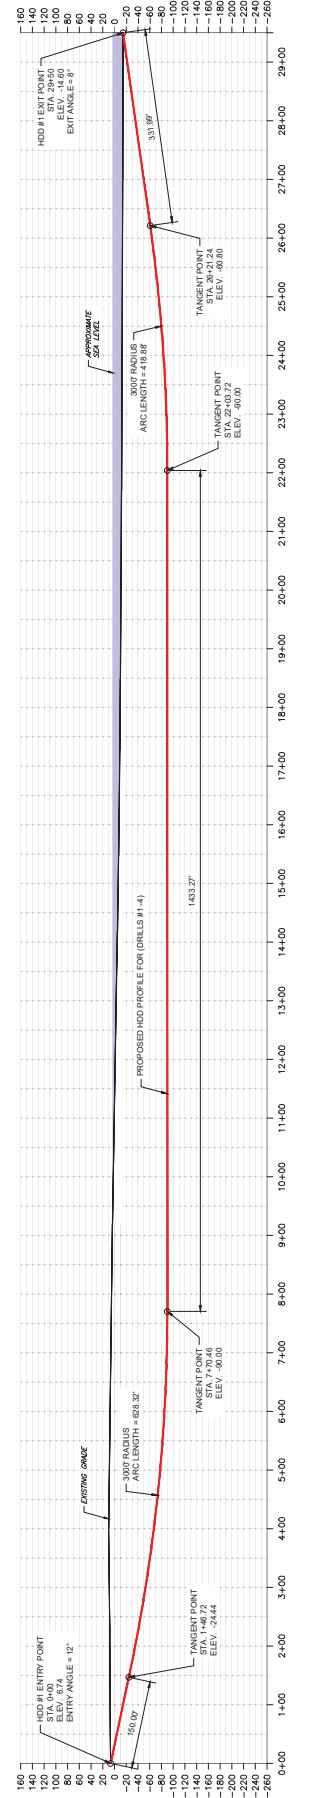


Figure 7. Atlantic Landfall HDD Plan & Profile

ISSUE FOR PERMIT

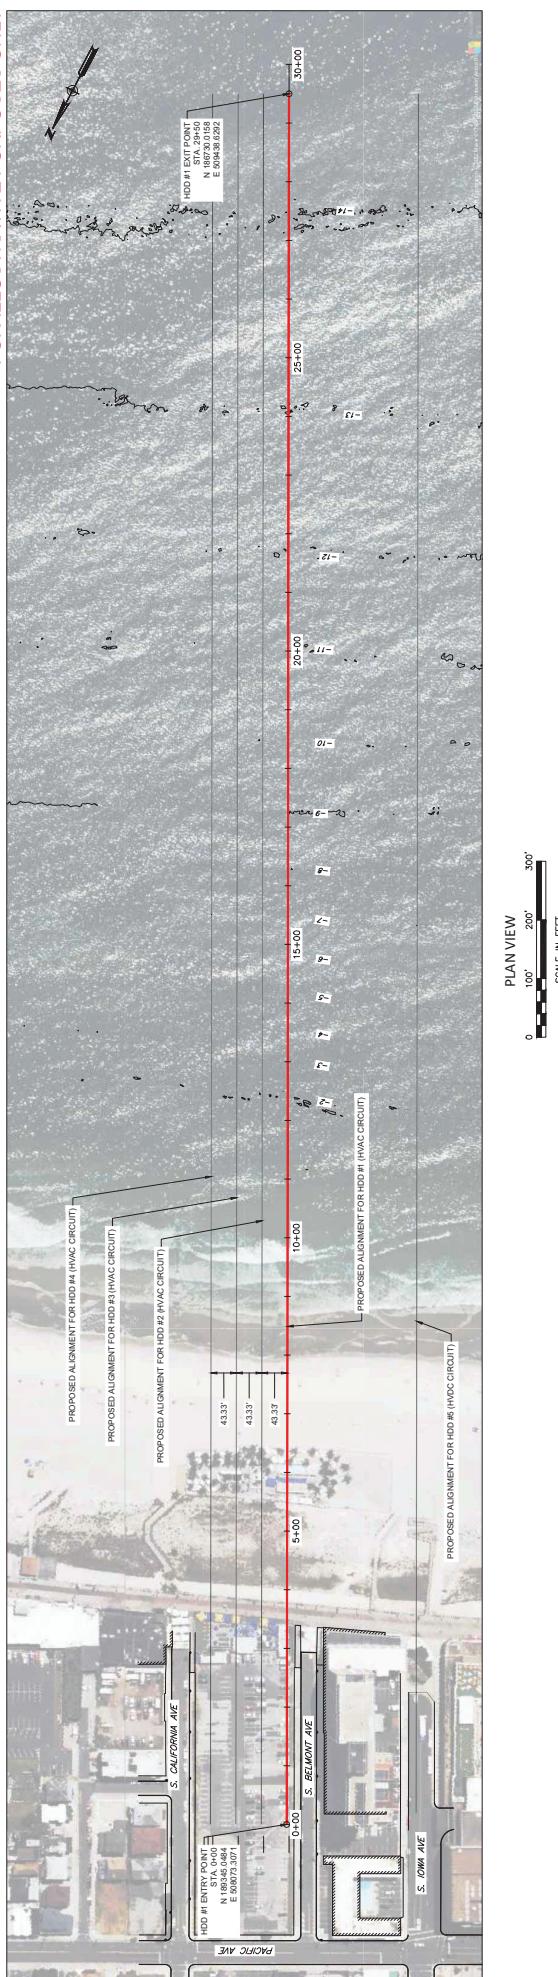

Project Plan Sheet 13

FOR ILLUSTRATIVE PURPOSES ONLY

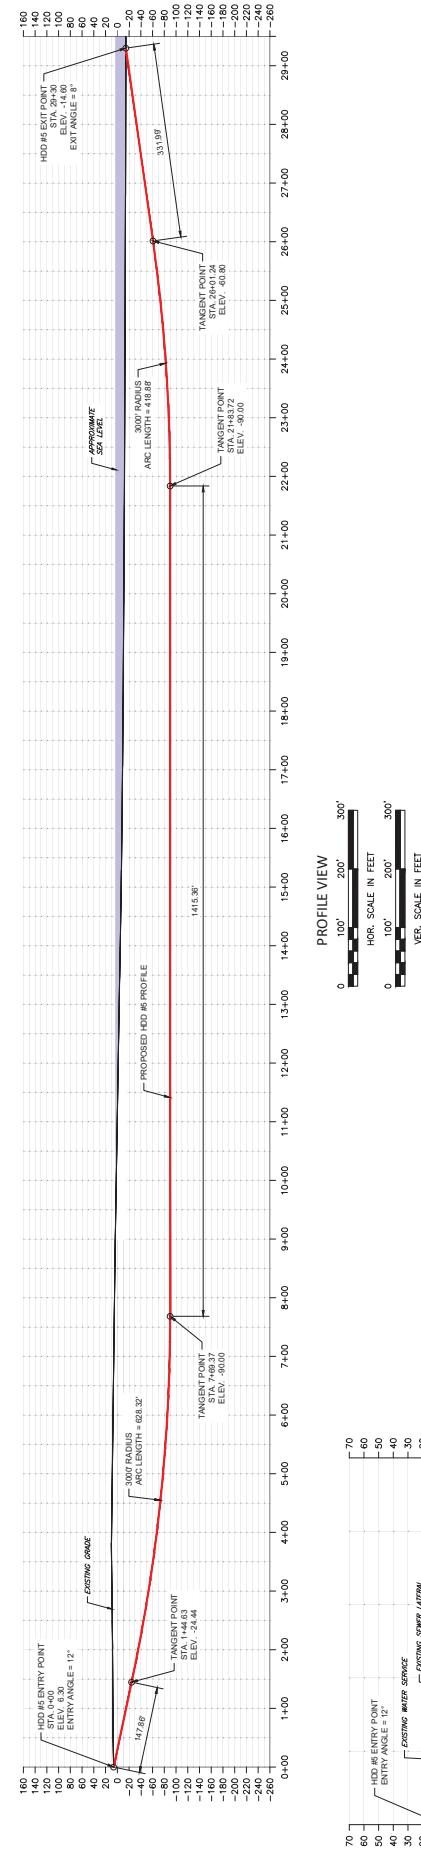
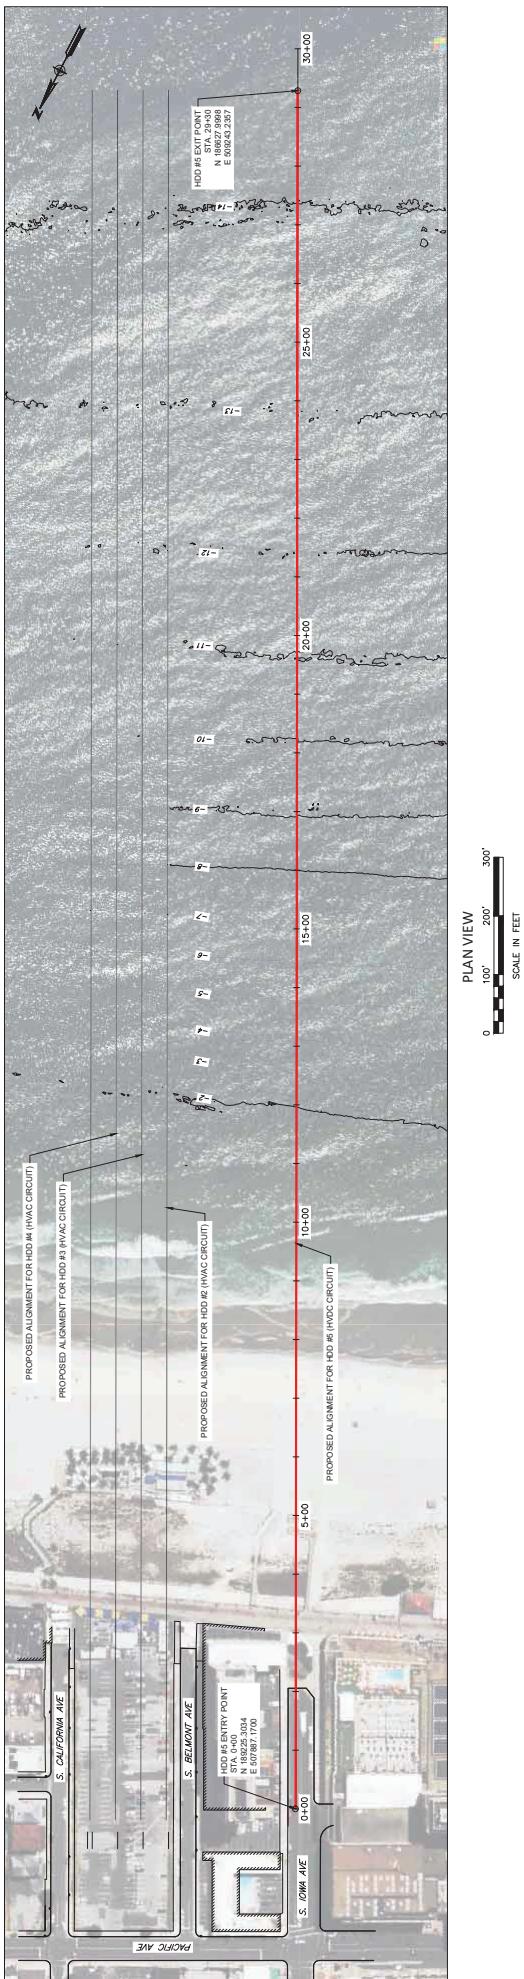


Figure 7. Atlantic Landfall HDD Plan & Profile **ISSUE FOR PERMIT**

 CARSON CONSTRUCTION <small>DIRECTIONAL DRILLING CIVIL CONSTRUCTION</small>		171 ROUTE 94 N LAWRENCE, IA 973-579-4100	
PROJECT #: 6217 CLIENT: ATLANTIC SHORES OFFSHORE WIND ADDRESS: ATLANTIC CITY LANDFILLS <small>ATLANTIC SHORES OFFSHORE WIND PROJECT - BID DOCUMENTS</small>		DRAWING #: 004 DRAWING TITLE: IOWA AVE HHD PLAN & PROFILE	
DRAWINGS, COORDINATES: HORIZONTAL SPAN: 100' 00" VERTICAL SPAN: 100' 00" SPANNING: 100' 00"		SCALE: 1" = 100' 00" VERTICAL SCALE: 1" = 100' 00" DRILLING SPECIFICATIONS: HHC: GRADE: 10' 00" DPP: 100'	

Project Plan Sheet 14

FOR ILLUSTRATIVE PURPOSES ONLY

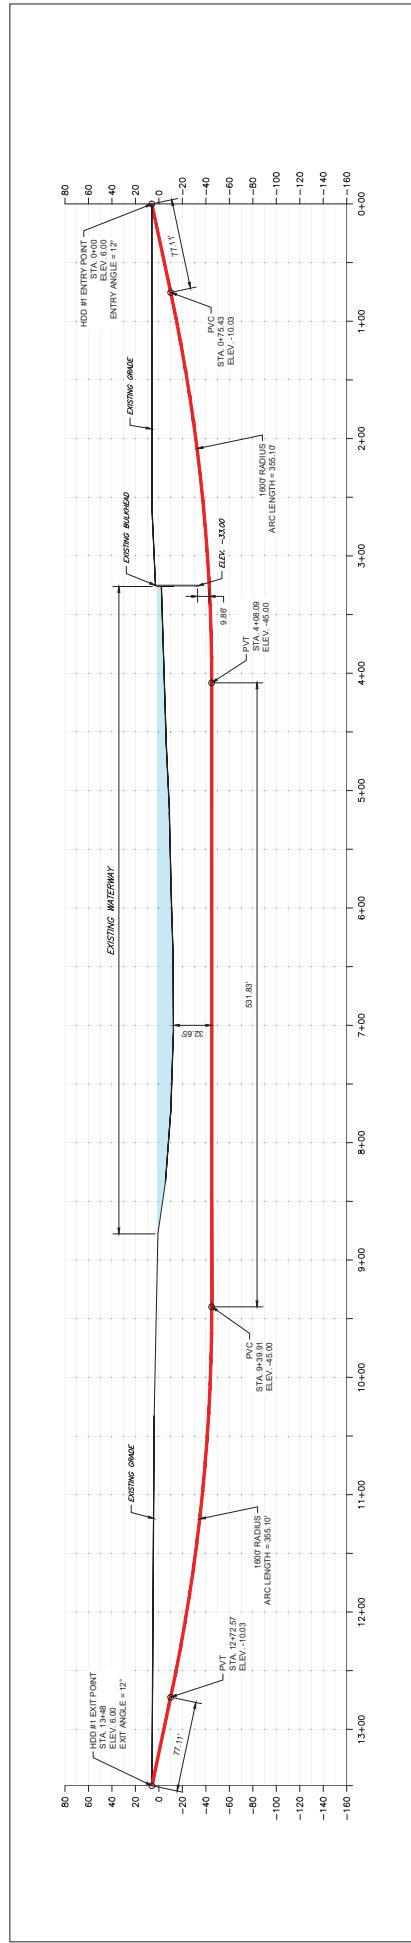
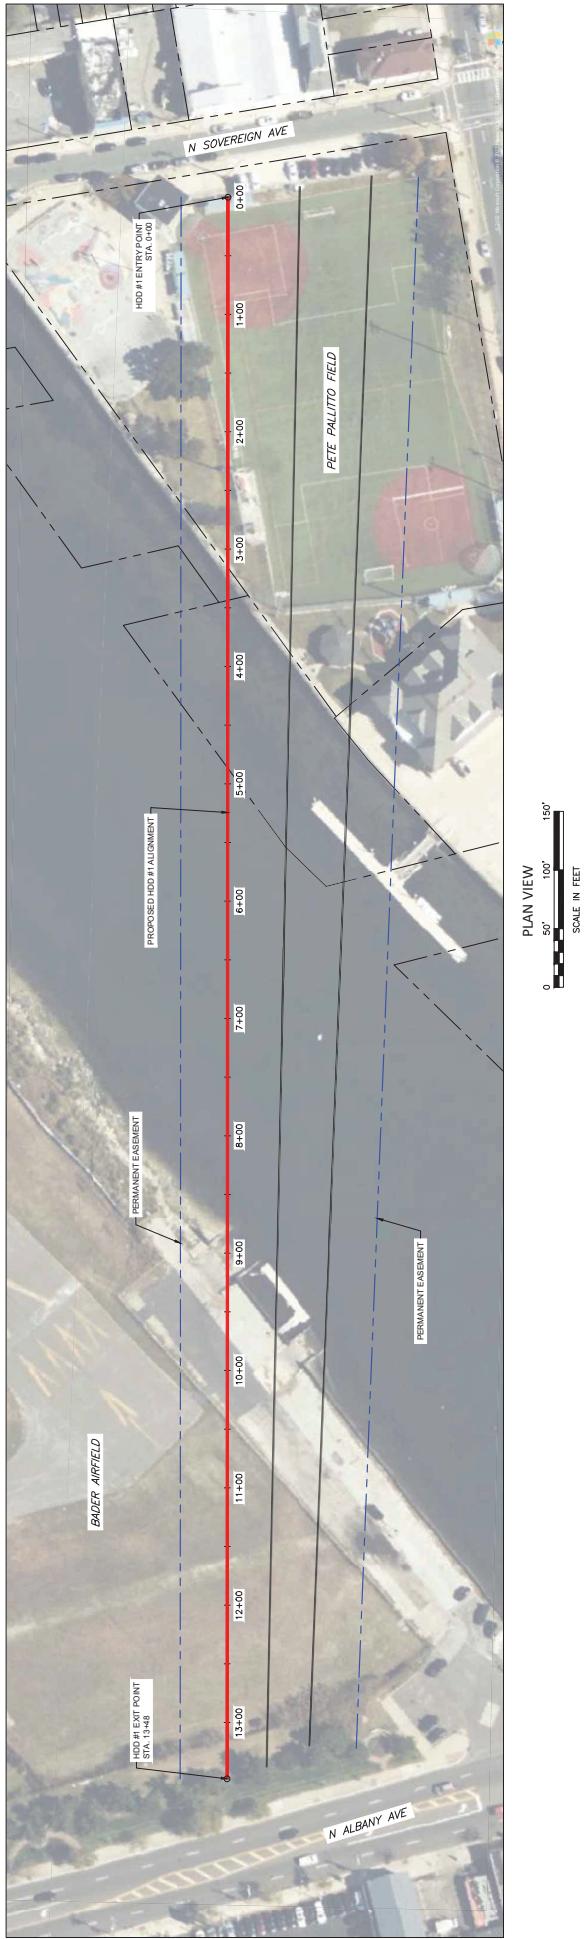


Figure 8. Inside Thorofare Crossing HDD Plan & Profile

ISSUE FOR PERMIT

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PROJECT #: 1		ATLANTIC SHORES OFFSHORE WIND COP SOUTH TERRESTRIAL	
SUBMISSION DATE:		10/10/2011	
SUBMISSION BY:		DRAFTS	
SUBMISSION TIME:		10:00 AM	
SUBMISSION ADDRESS:		CARSON CORPORATION 171 ROUTE 34 N LAPORTE, NJ 07729-4100	
DRAWING NUMBER:		1001	
DRAWING SCALE:		1:1000	
DRAWING DATE:		10/10/2011	
DRAWING NUMBER:		1001	
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SUBMISSION BY:		DRAFTS	
SUBMISSION TIME:		10:00 AM	
SUBMISSION ADDRESS:		CARSON CORPORATION 171 ROUTE 34 N LAPORTE, NJ 07729-4100	
DRAWING NUMBER:		1001	
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DRAWING NUMBER:		1001	

Project Plan Sheet 15

FOR ILLUSTRATIVE PURPOSES ONLY

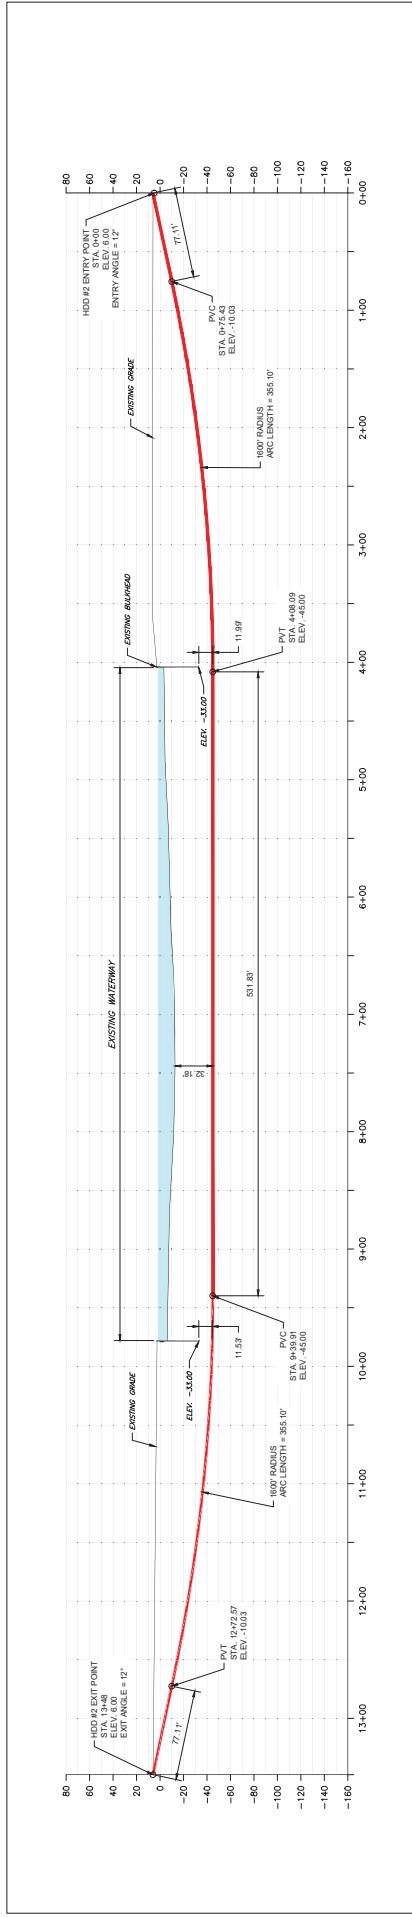
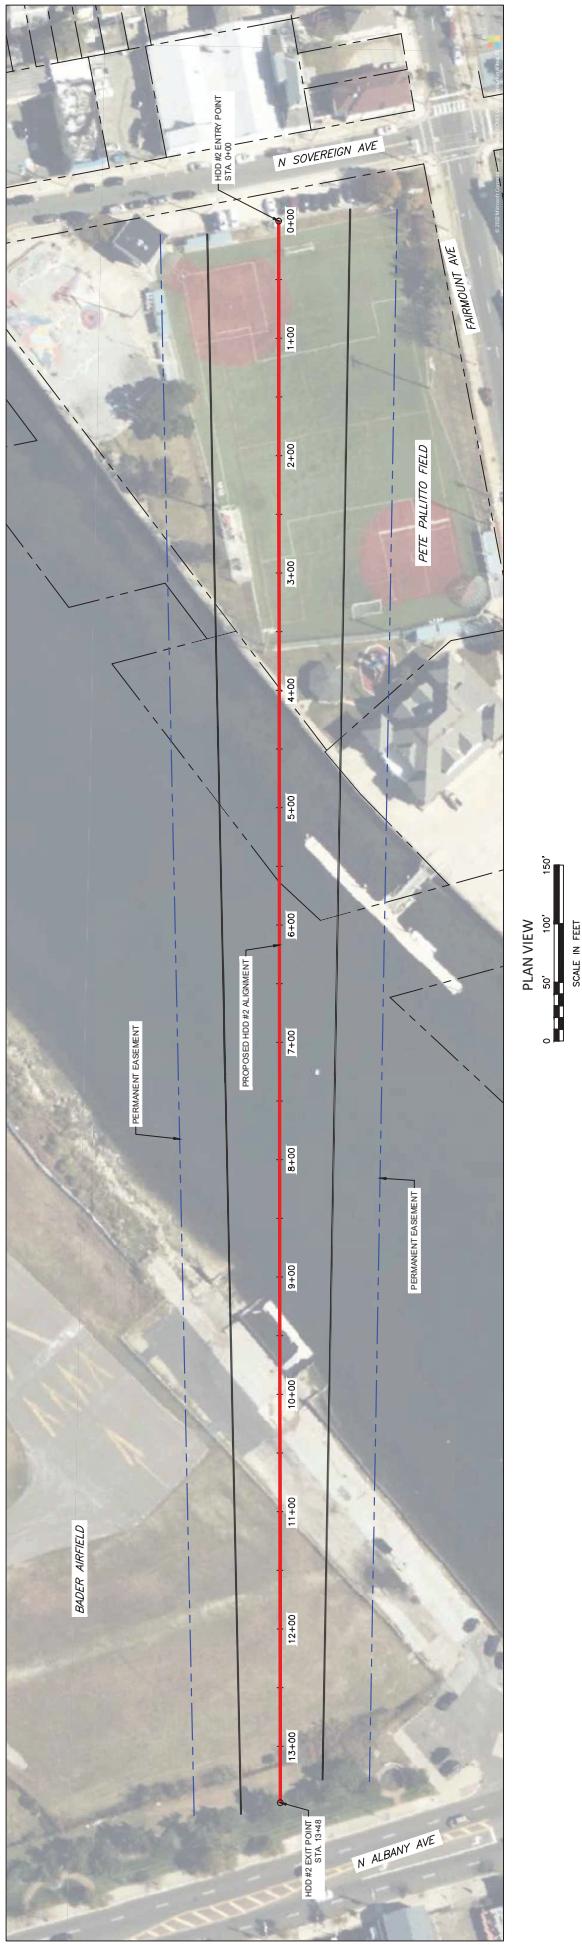


Figure 8. Inside Thorofare Crossing HDD Plan & Profile

ISSUE FOR PERMIT

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COP SOUTH TERRESTRIAL	
DRAWING # 002	
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DRAWINGS, COORDINATES, HORIZONTAL SCALE: 1"=40' VERTICAL SCALE: 1"=40' VERT. SPAN: 100' (100') 1000'	
DRAFTSMAN: DATE: 10/10/2010 CHECKED: APPROVED:	
JULIA S. GARCIA 10/10/2010 10/10/2010	
P.T. 1 = 4408.10 -45.00	
PC2 = 91+99.90 -45.00	
PT1-2 = 12+77.56 -10.04	
EXIT @ 12° = 13+48.00 FT -10.00	
HORIZONTAL DISTANCE = 348.00 FT DIRECTIONAL DRILL PIPE LENGTH = 1356.26 FT	
DIRECTIONAL DRILLING CIVIL CONSTRUCTION CARSON CORPORATION 111 ROUTE 9A N LAFAYETTE, NJ 07850-4100	

Project Plan Sheet 16

FOR ILLUSTRATIVE PURPOSES ONLY



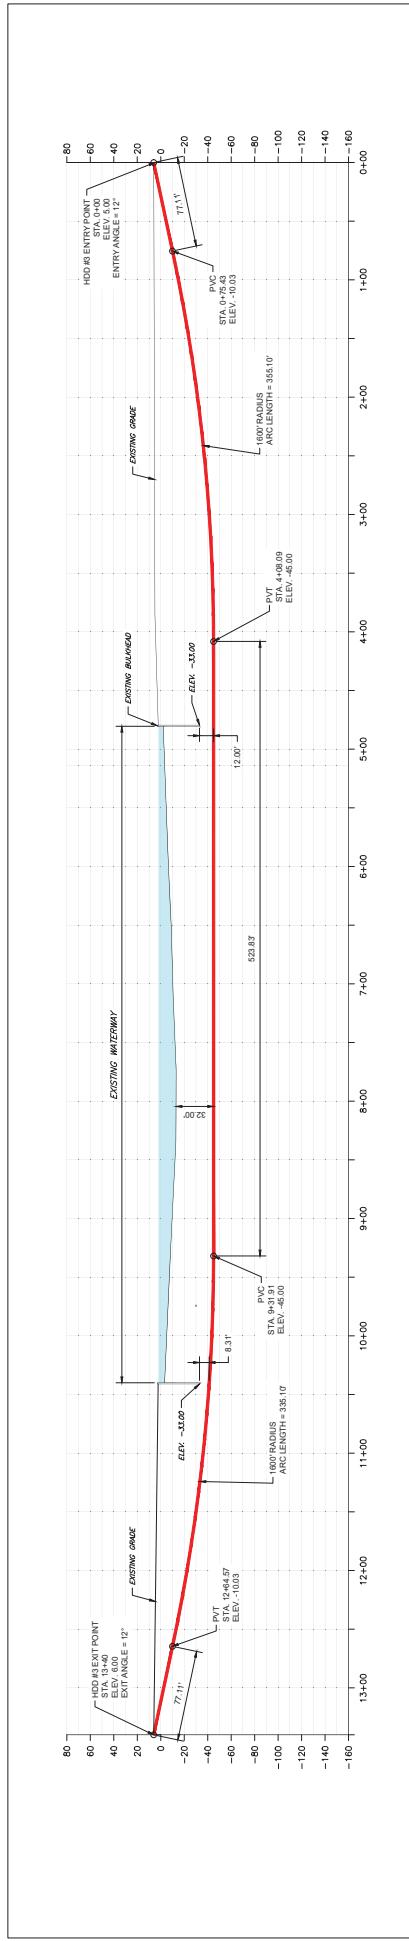


Figure 8. Inside Thorofare Crossing HDD Plan & Profile

ISSUE FOR PERMIT

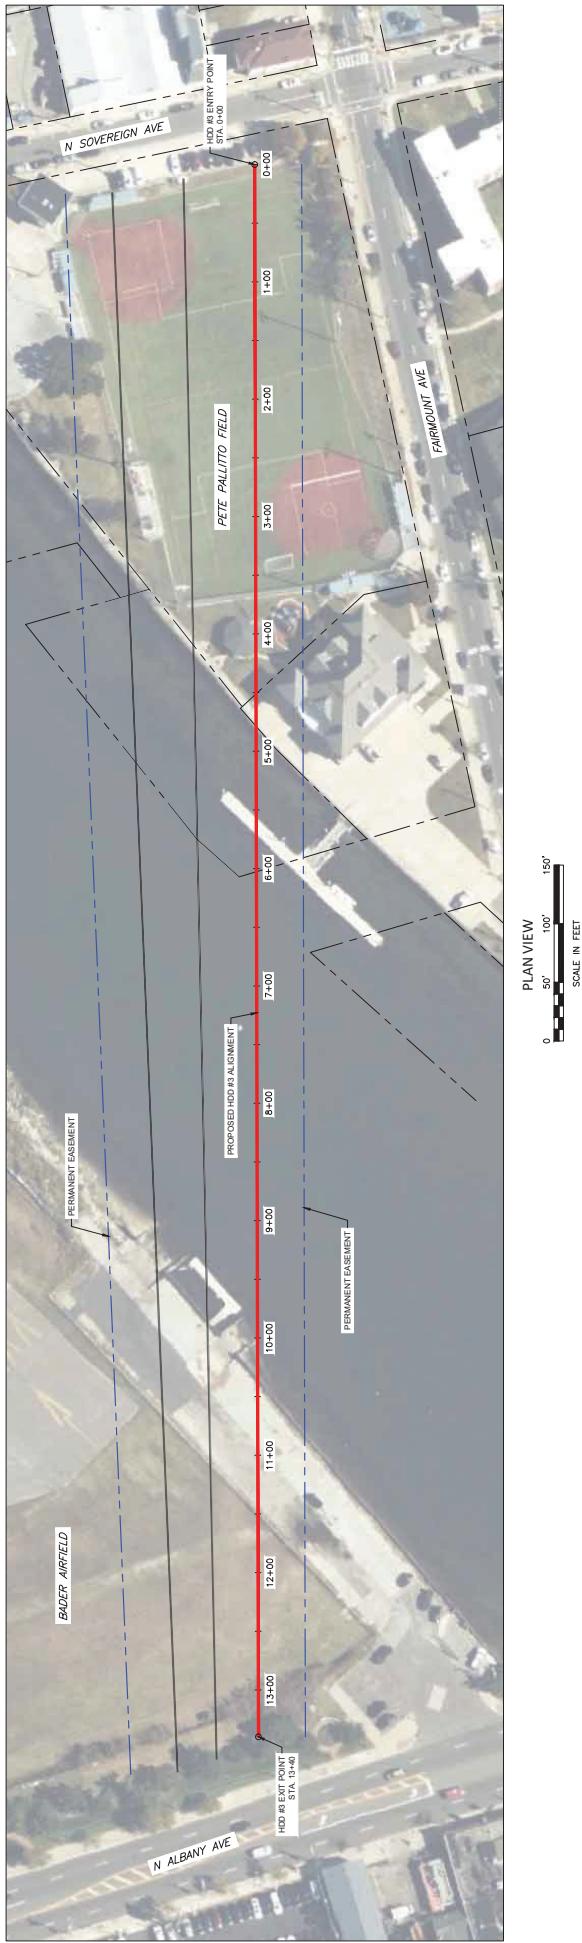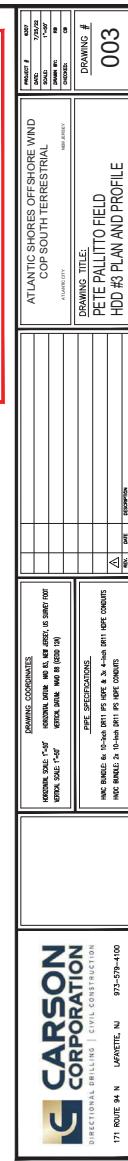

Project Plan Sheet 17

FOR ILLUSTRATIVE PURPOSES ONLY

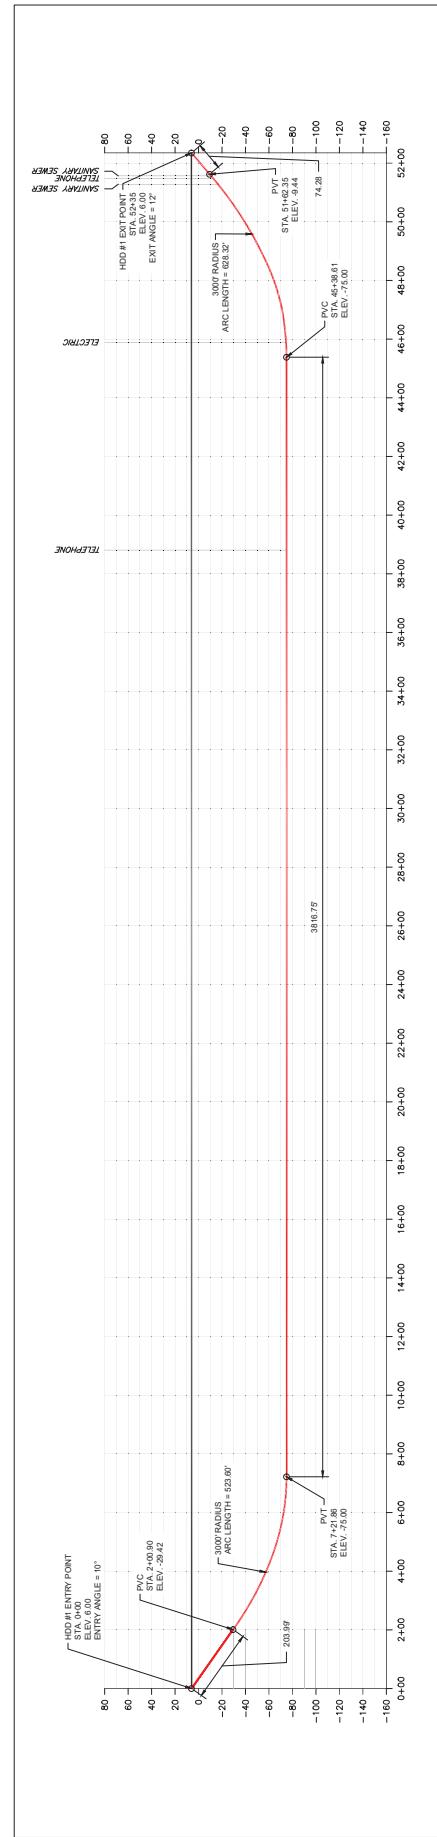
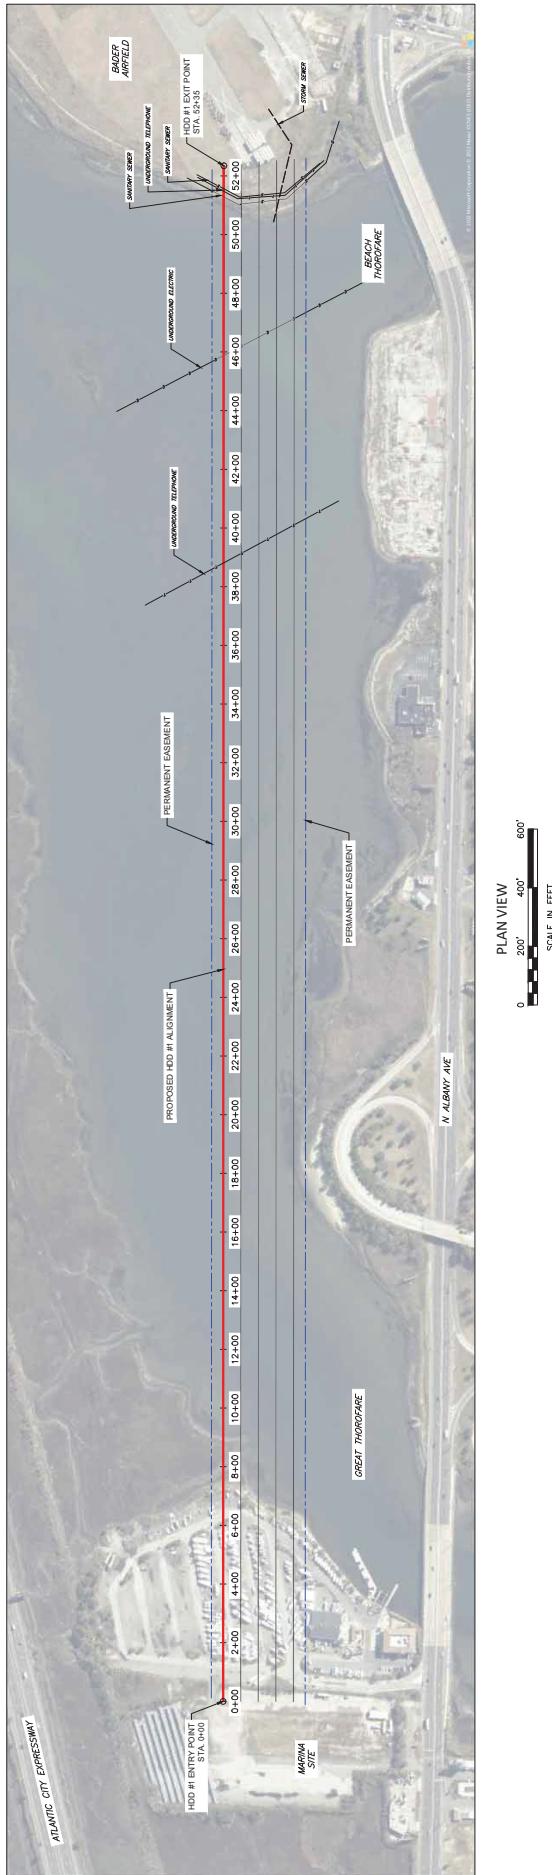


Figure 9. Great Thorofare Crossing #1 HDD Plan and Profile

ISSUE FOR PERMIT

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		DATE ISSUED: 10-10-2012
		DESIGNER: J. KELLY REVIEWER: J. KELLY APPROVED: J. KELLY OWNER: BADER FIELD TO MARINA CONTRACTOR: BADER FIELD TO MARINA
		DRAWING NUMBER: 004 SCALE: 1:1000 PAGES: 1 OF 1 DRAWN BY: J. KELLY CHECKED BY: J. KELLY APPROVED BY: J. KELLY
		PROJECT NUMBER: 004 DRAWING NUMBER: 004 DATE ISSUED: 10-10-2012 DESIGNER: J. KELLY REVIEWER: J. KELLY APPROVED: J. KELLY OWNER: BADER FIELD TO MARINA CONTRACTOR: BADER FIELD TO MARINA
		DRAWING NUMBER: 004 SCALE: 1:1000 PAGES: 1 OF 1 DRAWN BY: J. KELLY CHECKED BY: J. KELLY APPROVED BY: J. KELLY

Project Plan Sheet 18

FOR ILLUSTRATIVE PURPOSES ONLY

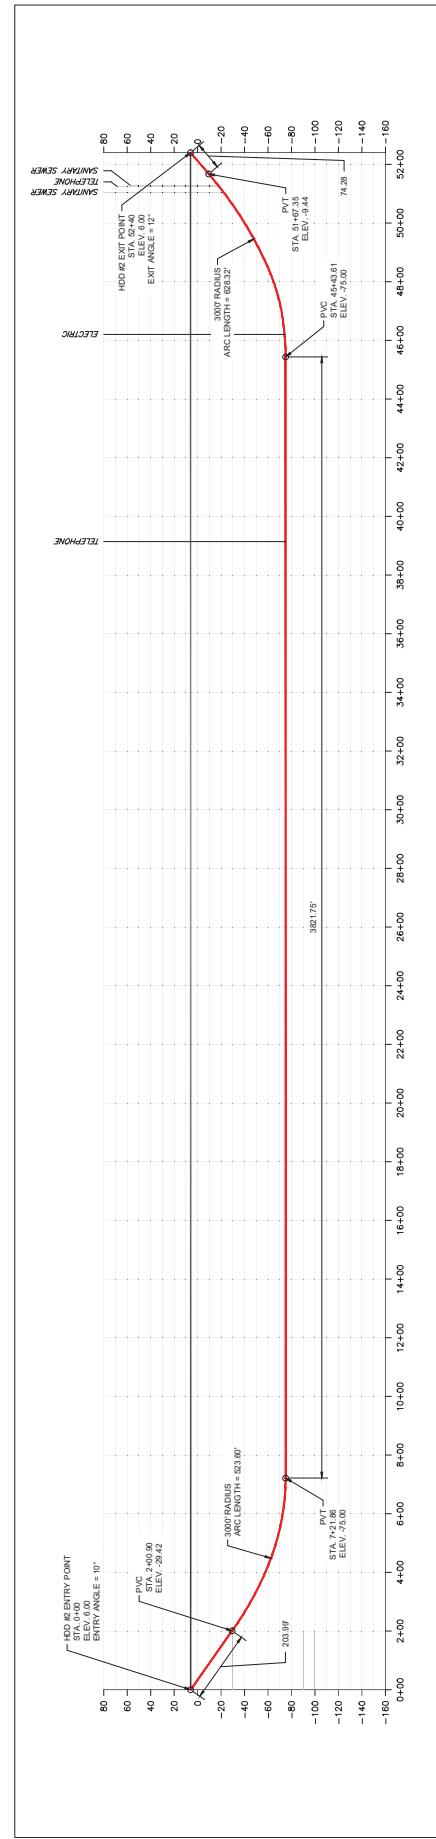
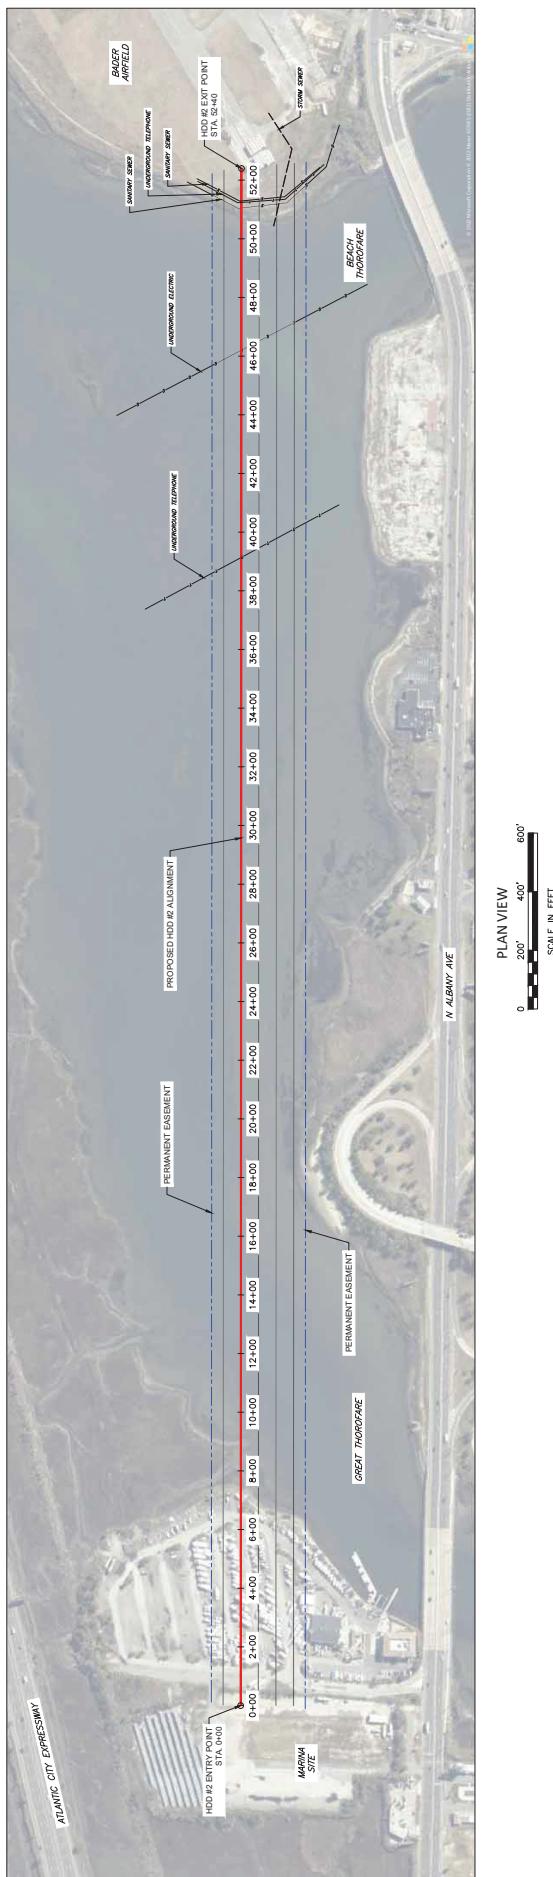


Figure 9 Great Thoroughfare Crossing #1 HDD Plan and Profile

ISSUE FOR PERMIT

ATLANTIC SHORES OFFSHORE WIND COP SOUTH TERRESTRIAL		DRAWING # 005
AVAILABILITY 000-0000-0000		DRAWING TITLE: BADER FIELD TO MARINA HDD #2 PLAN AND PROFILE
REVISIONS 00000000000000000000000000000000		REVISIONS 00000000000000000000000000000000
SHEET NUMBER 00000000000000000000000000000000		Sheet Number 00000000000000000000000000000000

<p>DIRECTIONAL DRILLING</p> <p>GENERAL CONTRACTORS</p> <p>KODIAK DRILL, INC., NEW YORK CITY, NY 100-16 VERA DRILL, INC., WOODBURY, NY 117-020</p>	<p>DRILLING EQUIPMENT</p> <p>GENERAL CONTRACTORS</p> <p>VERA DRILL, INC., 1-C-007 VERA DRILL, INC., 1-C-008</p>	<p>DRILLING SERVICES</p> <p>GENERAL CONTRACTORS</p> <p>VERA DRILL, INC., 1-C-007 VERA DRILL, INC., 1-C-008</p>
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Project Plan Sheet 19

FOR ILLUSTRATIVE PURPOSES ONLY

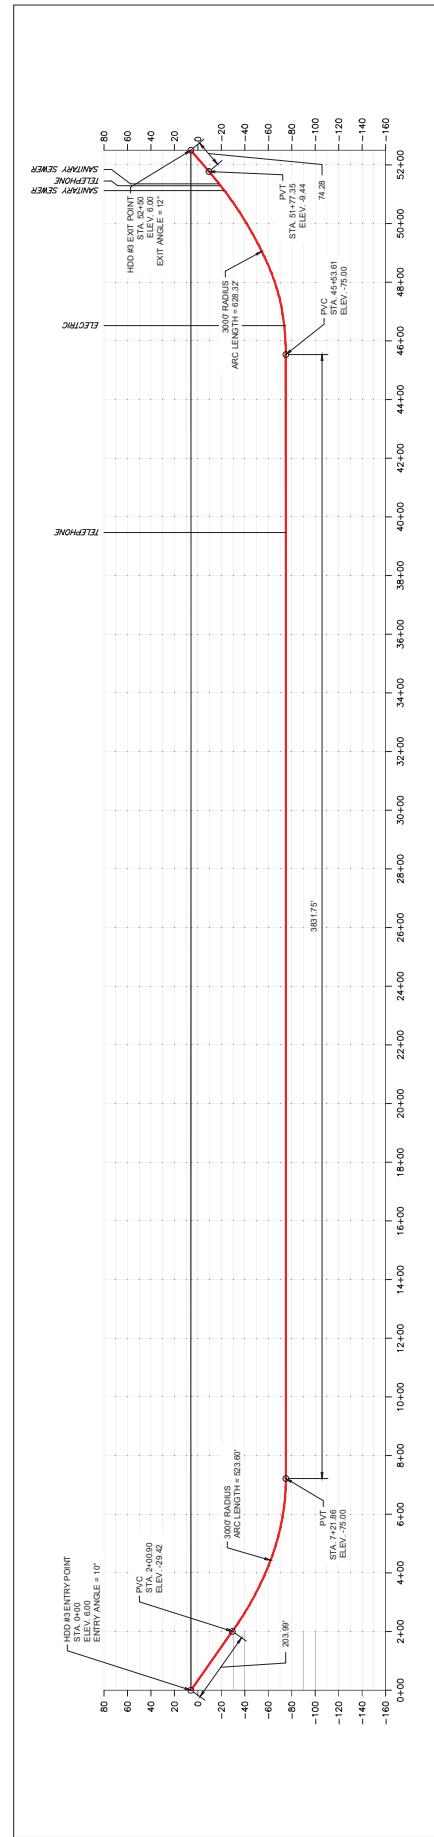
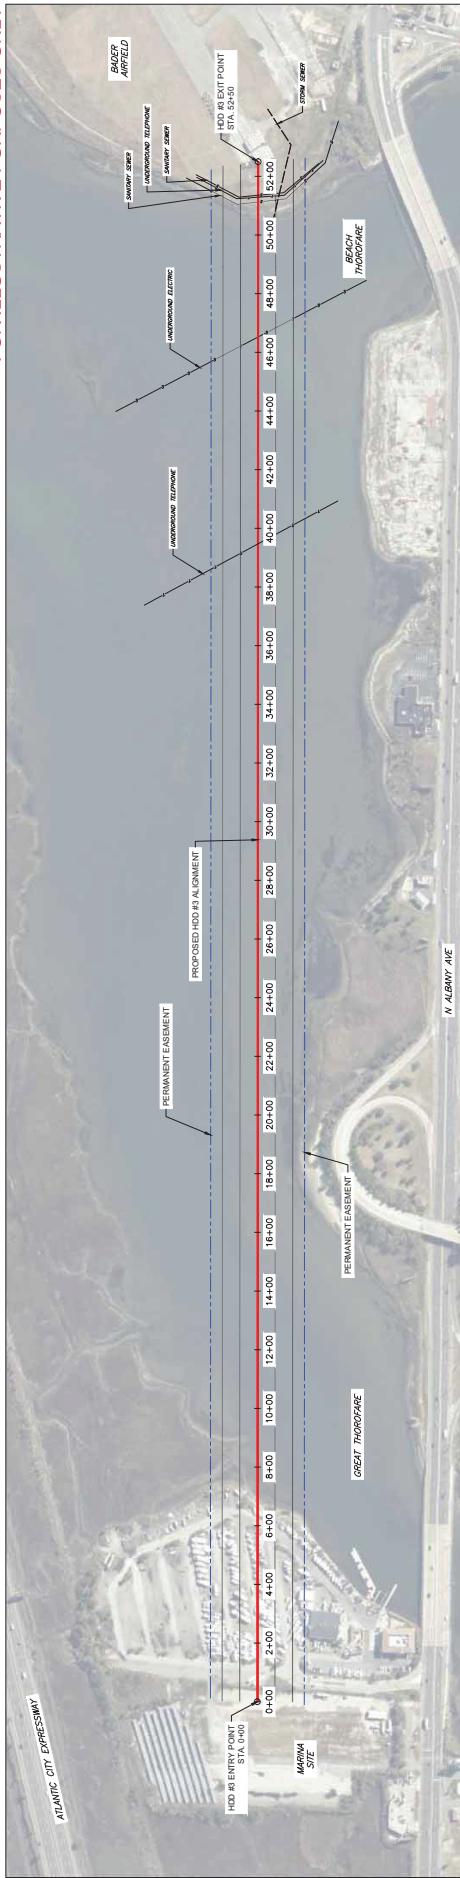


Figure 9. Great Thorofare Crossing #1 HDD Plan and Profile
ISSUE FOR PERMIT

PROJECT #	000	DATE	10/05/2023
DRAWING #	006	TYPE	PLAN & PROFILE
DESIGNER	CARSON CORPORATION	OWNER	ATLANTIC SHORES OFFSHORE WIND COP SOUTH TERRESTRIAL
CONTRACTOR		LOCATION	ROUTE 34 N, LBI, NJ
DATE ISSUED		DRAWING TITLE	BADER FIELD TO MARINA
DRAWING SPECIFICATIONS:			
HHD DIA 36" & 10-in. DTH 20-in. x 10-in. HDPE CONDUITS			
HHD DIA 36" & 10-in. DTH 20-in. x 10-in. HDPE CONDUITS			

Project Plan Sheet 20

FOR ILLUSTRATIVE PURPOSES ONLY

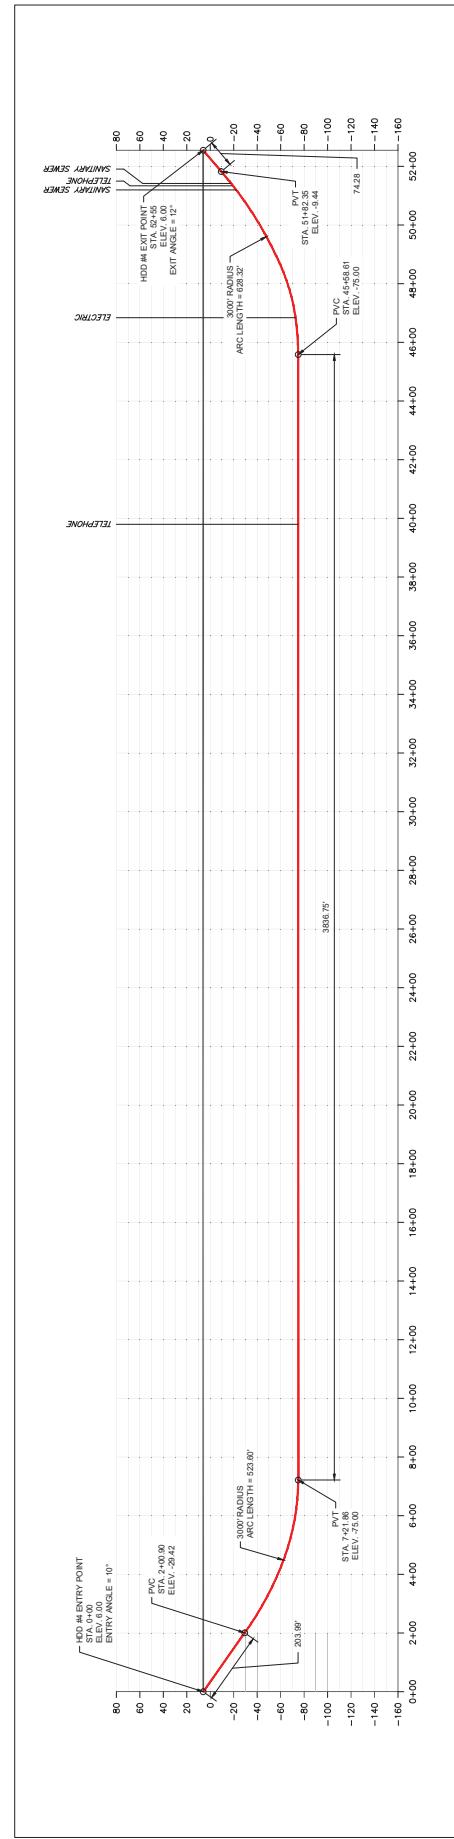
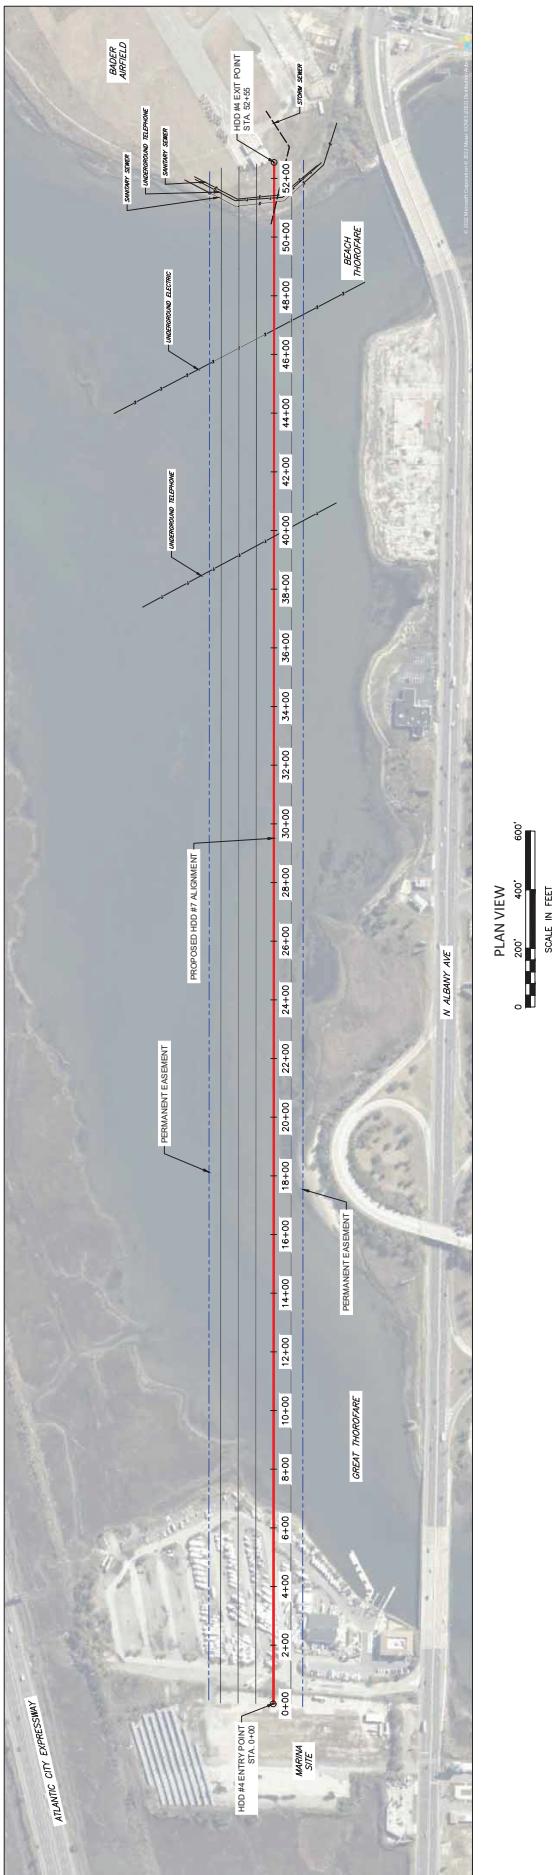


Figure 9 Great Thornton Crossing #1 HDD Plan and Profile

ISSUE FOR PERMIT

Project Plan Sheet 21

FOR ILLUSTRATIVE PURPOSES ONLY

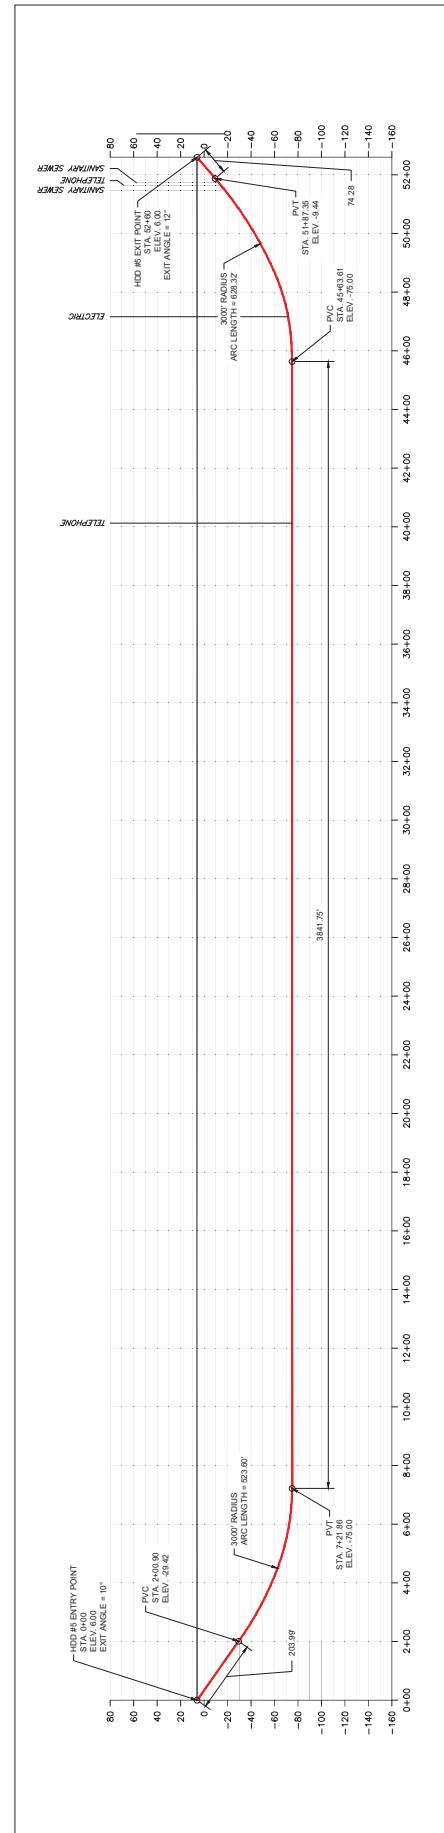
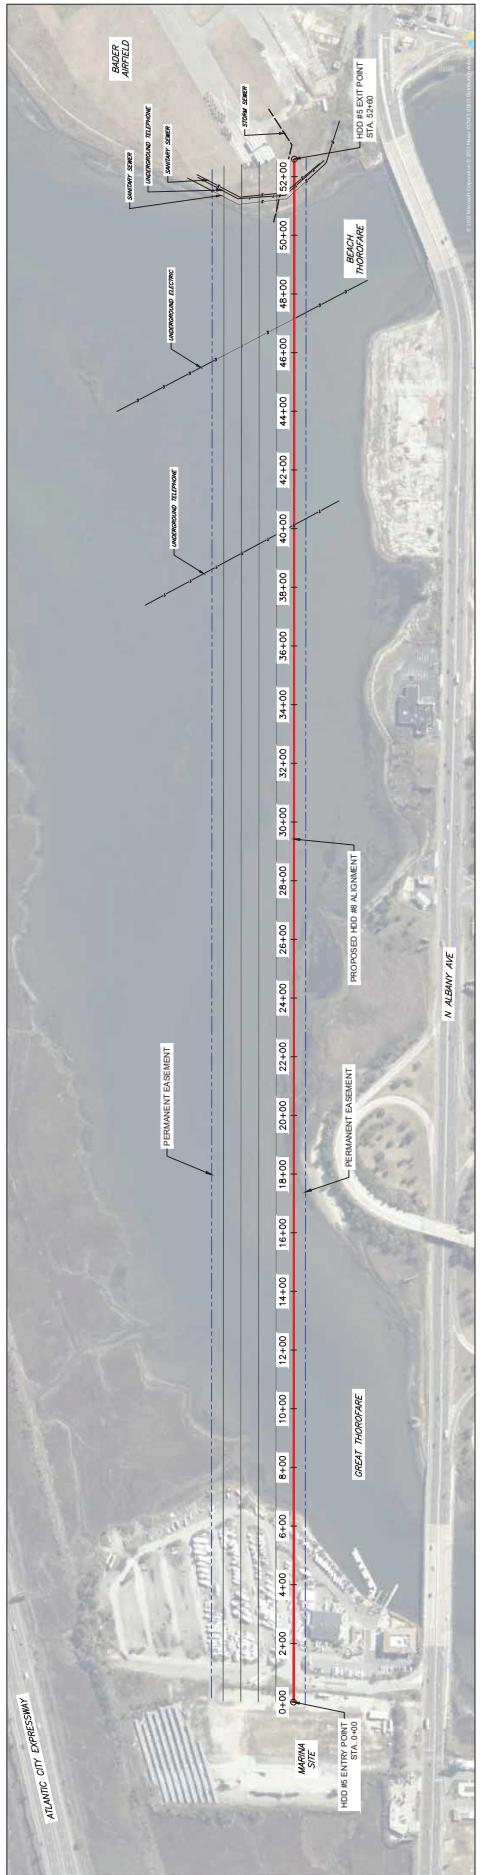


Figure 9 Great Thornton Crossing #1 HDD Plan and Profile

ISSUE FOR PERMIT

	DRAWING #	008
	SCALE #	1:500
	DATE:	7/20/07
	DRAWING BY:	P-JAW
	OWNER:	NEW JERSEY US NAVY YARD
	VERIFICATION:	WWD (2007)
	REVISIONS:	10
	APPROVALS:	10
	DRAWING TITLE:	ATLANTIC SHORES OFFSHORE WIND COP SOUTH TERRESTRIAL
	DIRECTIONAL DRILLING:	BADGER FIELD TO MARINA
	PIPE LAYING:	HDD #5 PLAN AND PROFILE
3000' RADIUS	Z-LEVEL	-2.2~2
PT1 =	7-21.84	-7-50
PC2 =	45+63.61	75.00
(3000' RADIUS)	51+487.35	9.44
PT2=	52+60.00	6.00
EXIT @ 12° =		
HORIZONTAL DISTANCE :	5260.00 FT	
DIRECTIONAL DRILL PIPE LENGTH :	527.96 FT	
171' TOWER 34' N	LAFAYETTE, NJ	973-57-4100
CARSON CORPORATION		DIRECTIONAL DRILLING CIVIL CONSTRUCTION
DRAWING COORDINATES:	WORLD COORDINATES:	
HORIZONTAL SCALE: 1"=60'	VERTICAL SCALE: 1"=60'	
VERTICAL SIZE: 1"=5'	VERTICAL SIZE: 1"=5'	
STATION DEIN: WWD (2007)	STATION DEIN: WWD (2007)	
ELEVATION:	ELEVATION:	
SPECIFICATIONS:	SPECIFICATIONS:	
SEE SHEET 1 FOR DIA OF PIPE & WALL THICKNESS CHARTS	SEE SHEET 1 FOR DIA OF PIPE & WALL THICKNESS CHARTS	
PIPE NAME: 10" HDPE 1000# WHICH SAT IN 1000# CONCRETE	PIPE NAME: 10" HDPE 1000# WHICH SAT IN 1000# CONCRETE	

Project Plan Sheet 22

FOR ILLUSTRATIVE PURPOSES ONLY

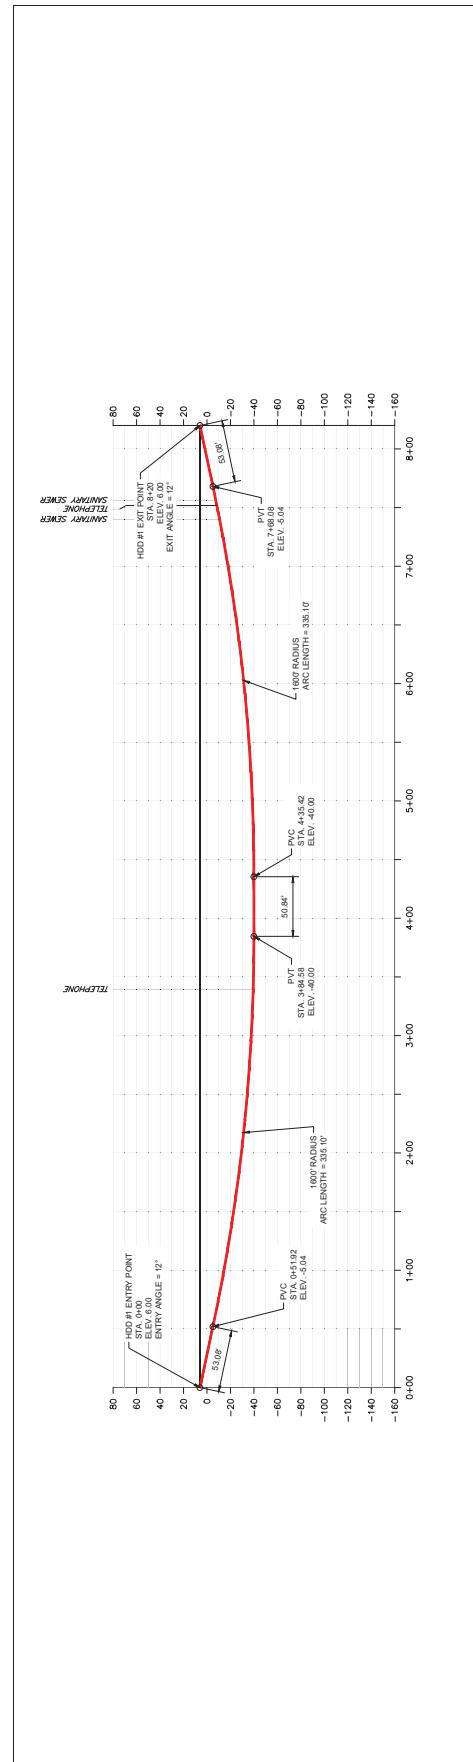
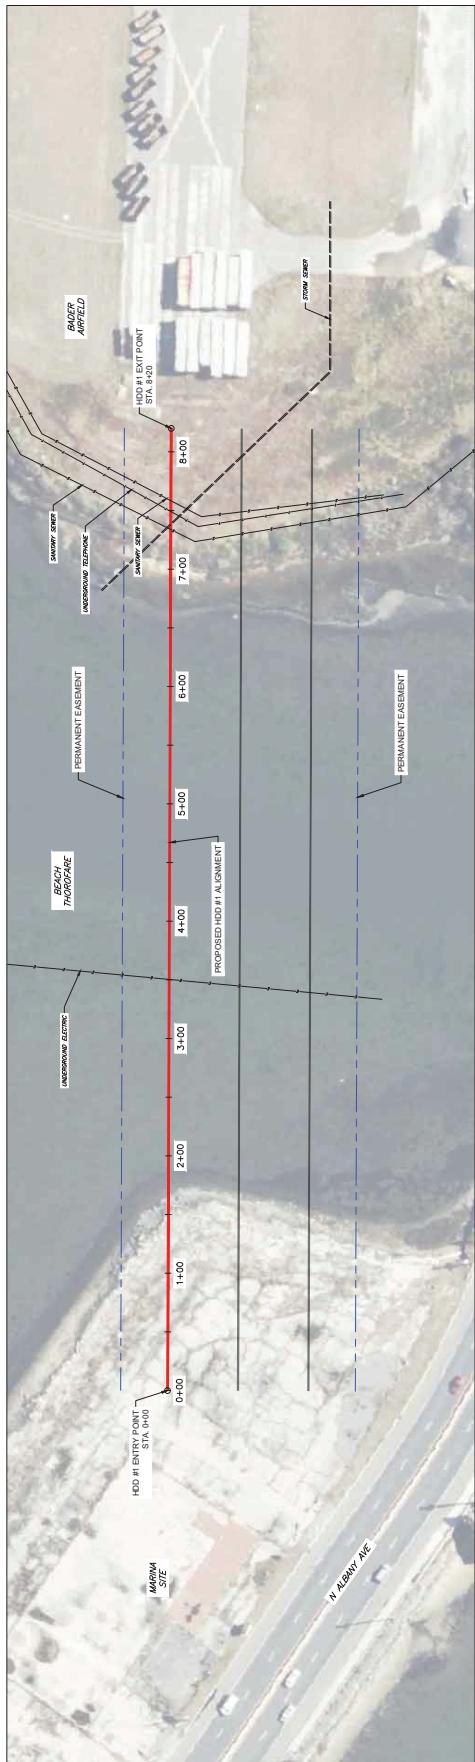


Figure 10: Great Thorofare Crossing #2 HDD Plan & Profile

ISSUE FOR PERMIT

PROJECT #		DRAWING #	
BADER FIELD TO EMPTY LOT HDD#1		009	
DESCRIPTION		ATLANTIC SHORES OFFSHORE WIND COP SOUTH TERRESTRIAL	
STATION (ft)		DRAWING DATE: 10/10/2018	
ELEVATION (ft)		DRAWN BY:	
PC1 =	0+51.92	5.04	SIGNATURE:
(180° RADUS)	3+84.58	-40.00	
PT1 =	4+35.42	-40.00	
(180° RADUS)	7+68.08	-5.04	
PT2=	8+20.00	6.00	
HORIZONTAL DISTANCE: 830.00 FT		DRAWN FOR:	
DIRECTIONAL DRILL PIPE LENGTH: 827.21 FT		CARSON CORPORATION	
171 ROUTE 34 N LAFAYETTE, NJ 07849		DIRECTIONAL DRILLING CIVIL CONSTRUCTION	

Project Plan Sheet 23

FOR ILLUSTRATIVE PURPOSES ONLY

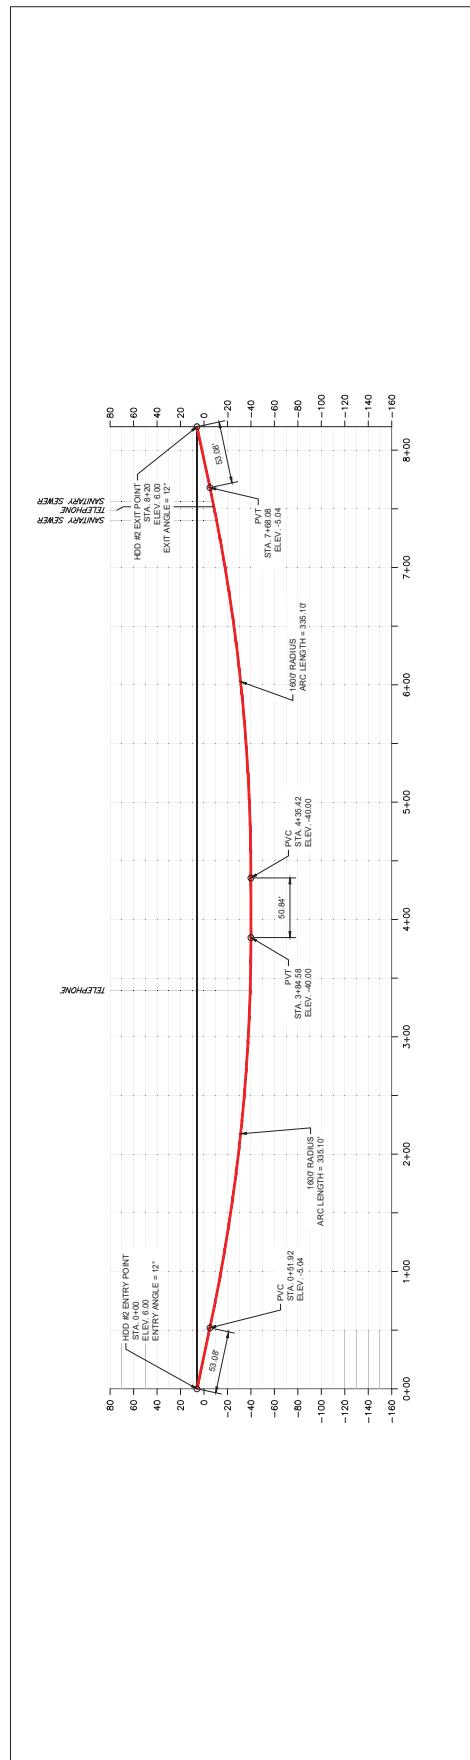
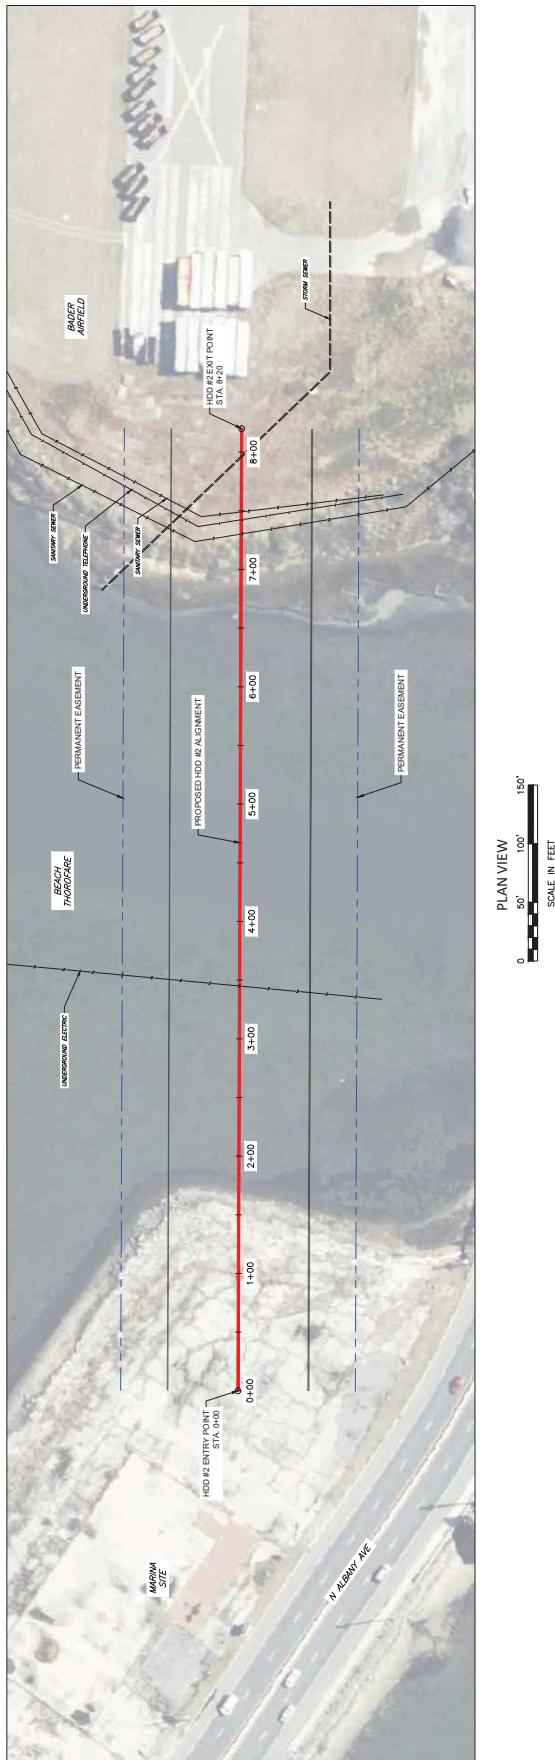


Figure 10 Great Thoroughfare Crossing #2 HDD Plan & Profile

ISSUE EOP DEBMIT

DRAWING #	010
SCALE #	1:500
SCALE	70' x 22'
DRAWING IN	IN
DRAWING OUT	IN
UNITS	FEET
DRAWING TITLE: BADER FIELD TO EMPTY LOT HDD #2 PLAN AND PROFILE	
	
	

Project Plan Sheet 24

FOR ILLUSTRATIVE PURPOSES ONLY

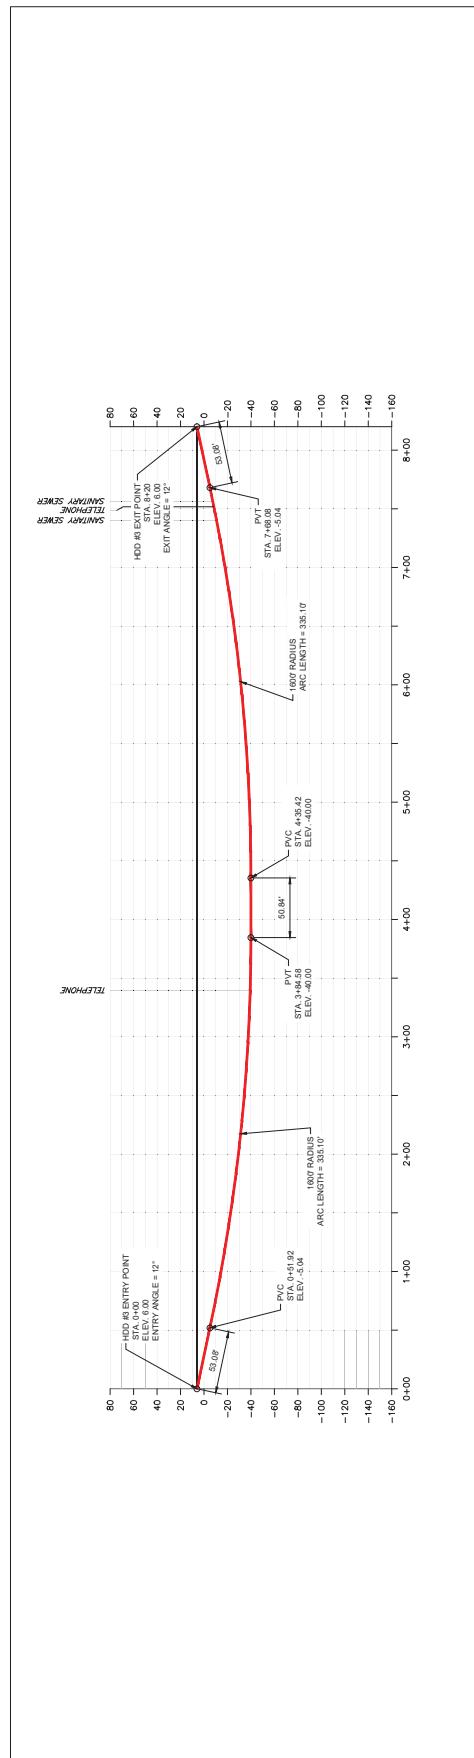
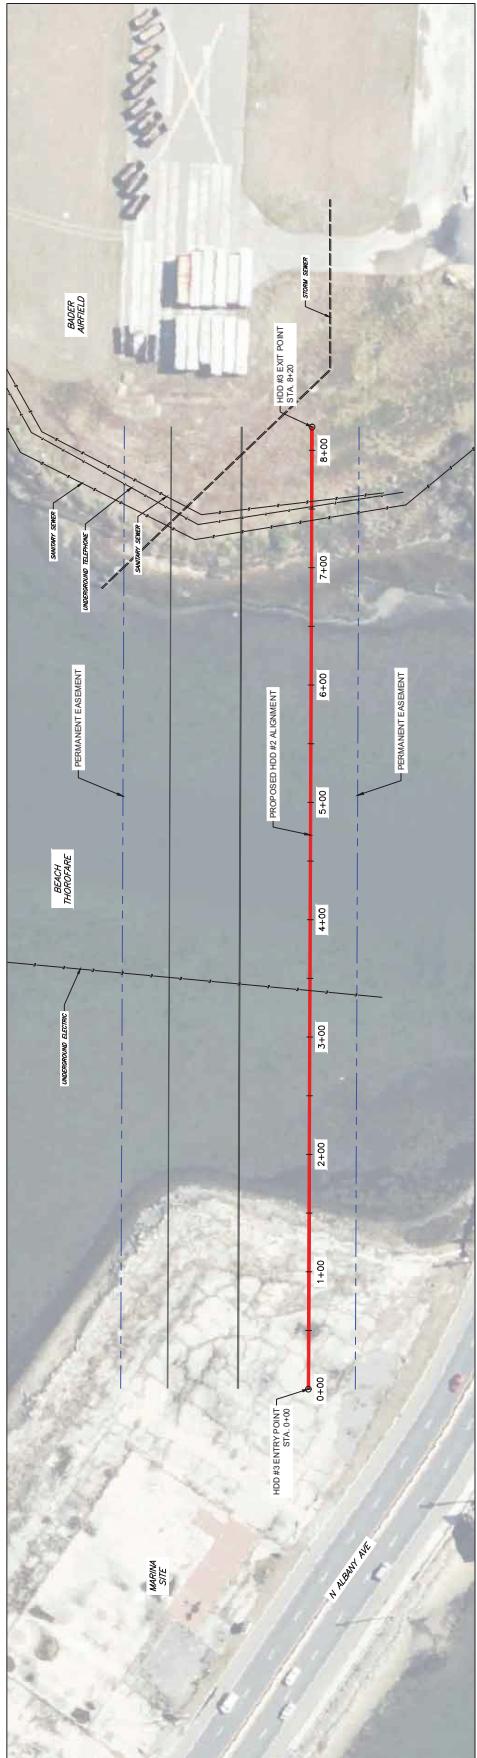


Figure 10: Great Thorofare Crossing #2 HDD Plan & Profile

Project Plan Sheet 25

FOR ILLUSTRATIVE PURPOSES ONLY

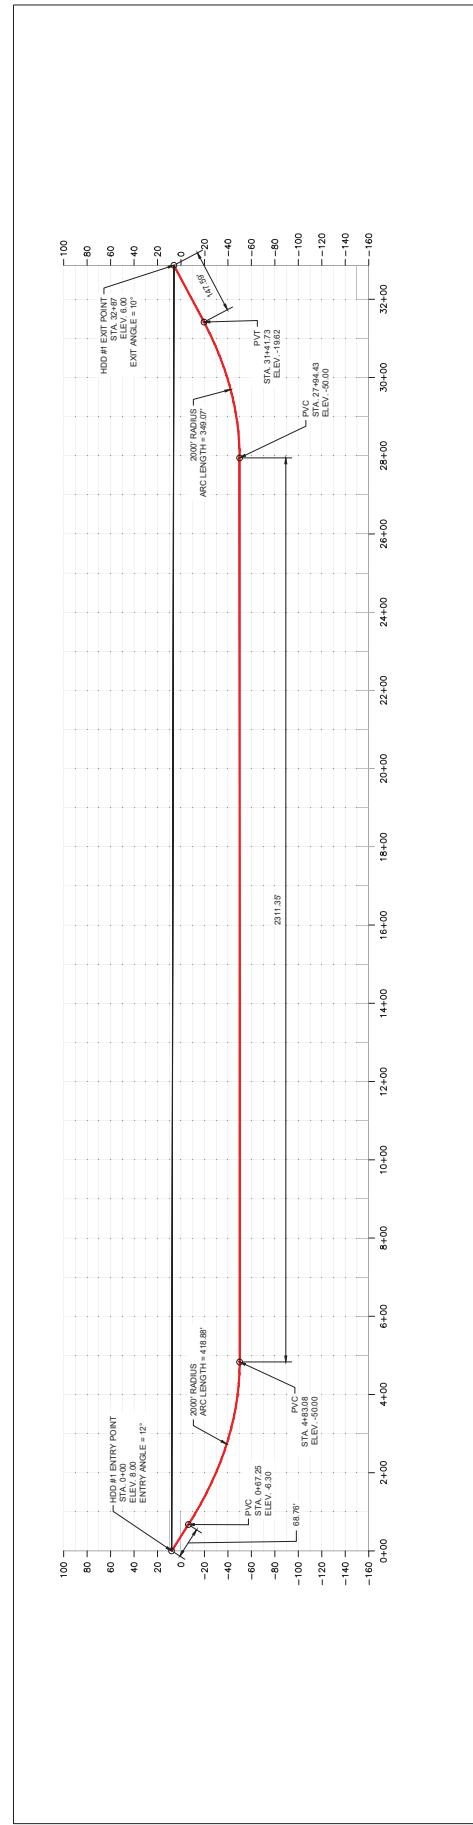
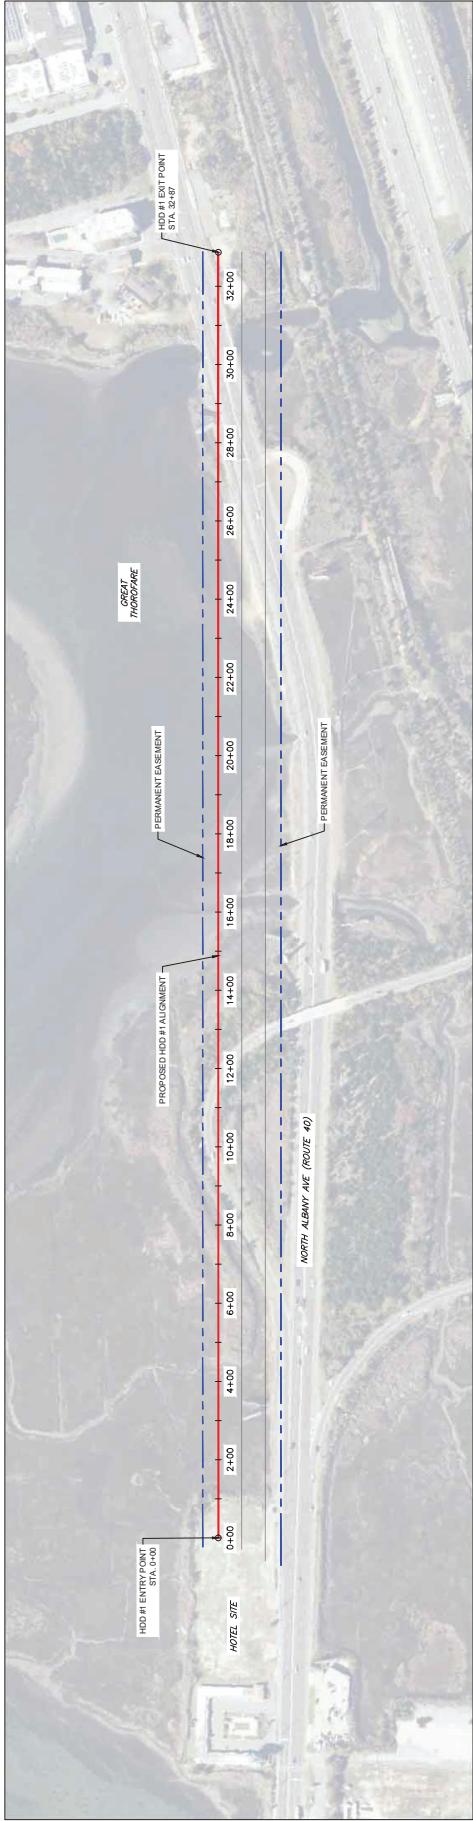


Figure 11. Great Thorofare Crossing #3 HDD Plan & Profile
ISSUE FOR PERMIT

PROJECT #	0000	OWNER #	0000
ROUTE #	1-COFF	HOZ. DIREC:	N-S
DESCRIPTION	ATLANTIC SHORES OFFSHORE WIND COP SOUTH TERRESTRIAL	VERT. DIREC:	W-E
DATE ISSUED	12/10/2015	PERMIT NO:	0000
DRAWING TITLE:		DRAWING #:	
HDD #1 CROSSING		015	
HDD #1 PLAN AND PROFILE			
HDC DRAWING: 24-10-inch 2015 PS DPC CONSETS			
HDC DRAWING: 24-10-inch 2015 PS DPC CONSETS			

Project Plan Sheet 26

FOR ILLUSTRATIVE PURPOSES ONLY

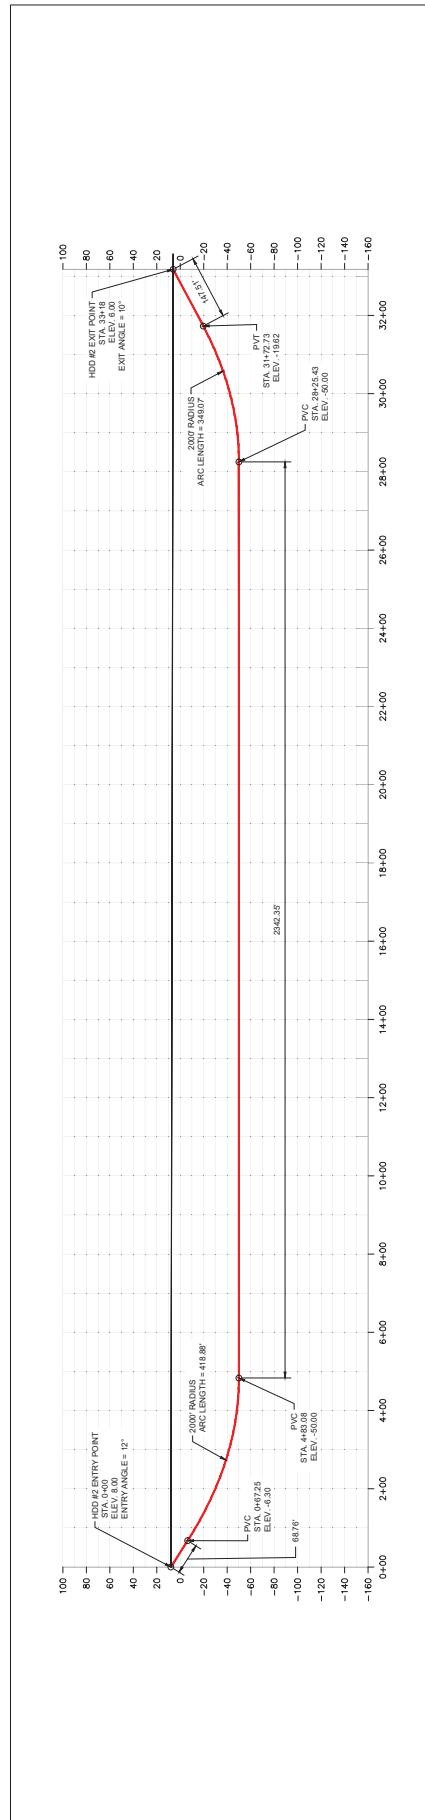
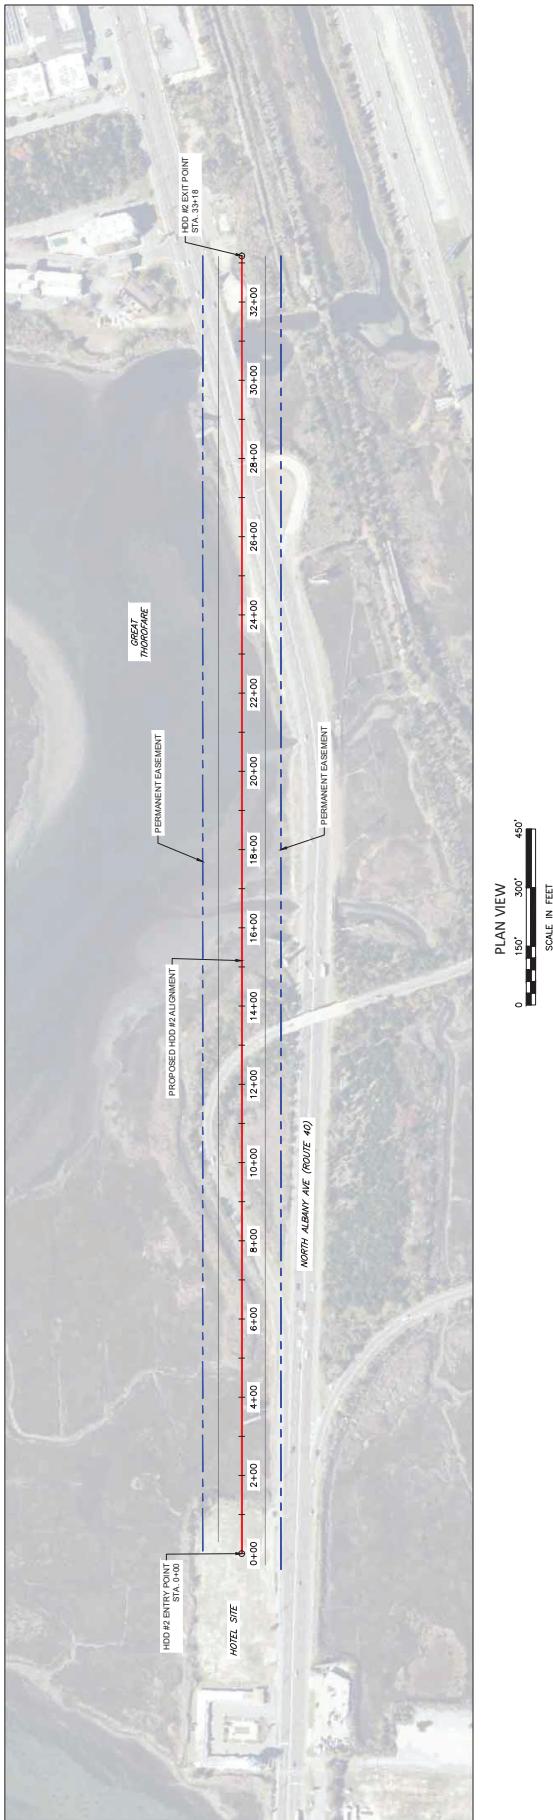


Figure 11 Great Thoroughfare Crossing #3 HDD Plan & Profile

ISSUE FOR PERMIT

CARSON CORPORATION  DIRECTIONAL DRILLING CIVIL CONSTRUCTION 171 ROUTE 94 N APRINETTE, IN 475-574-4100	
DRAFTER: S. CARBON DRILLER: J. HARRIS DATE: 10/20/2015	
PT1 =	4+43.08
PC2 =	-50.00
(2000' RADIUS)	28+25.43
PT2 =	-50.00
EXT. B. 10° =	33.48.00
HORIZONTAL DISTANCE =	331.8.00 FT
DIRECTIONAL DRILL PIPE LENGTH =	3316.57 FT
ATLANTIC SHORES OFF-SHORE WIND COP SOUTH TERRESTRIAL <small>ATLANTIC CITY, NJ</small>	
DRAWING COORDINATES: HORIZONTAL SCALE: 1"=20' VERTICAL SCALE: 1'=5"	
HORIZONTAL DRILL LINE: N 88° 45' 00" E VERT. DRILL LINE: W 080° 19' 00"	
DRAFTER: S. CARBON DRILLER: J. HARRIS DATE: 10/20/2015	
DRAWING TITLE: ROUTE #2 CROSSING DRAWING #: HDD #2 PLAN AND PROFILE	
DRAWING #: 016	

Project Plan Sheet 27

FOR ILLUSTRATIVE PURPOSES ONLY

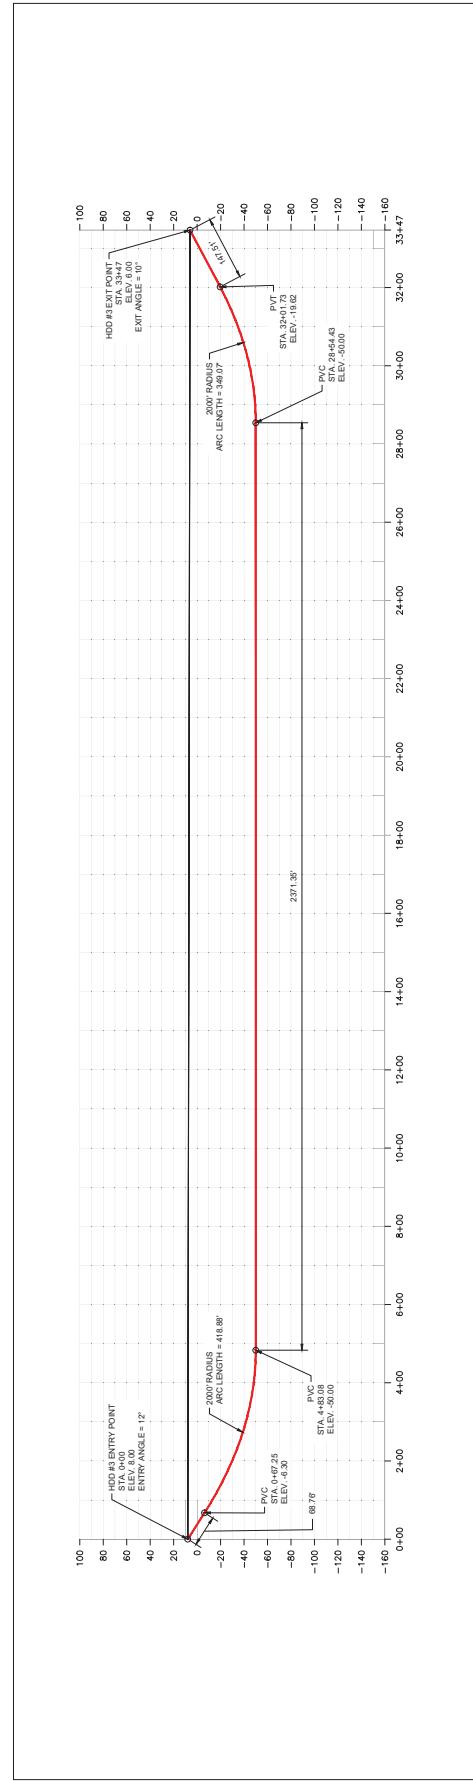
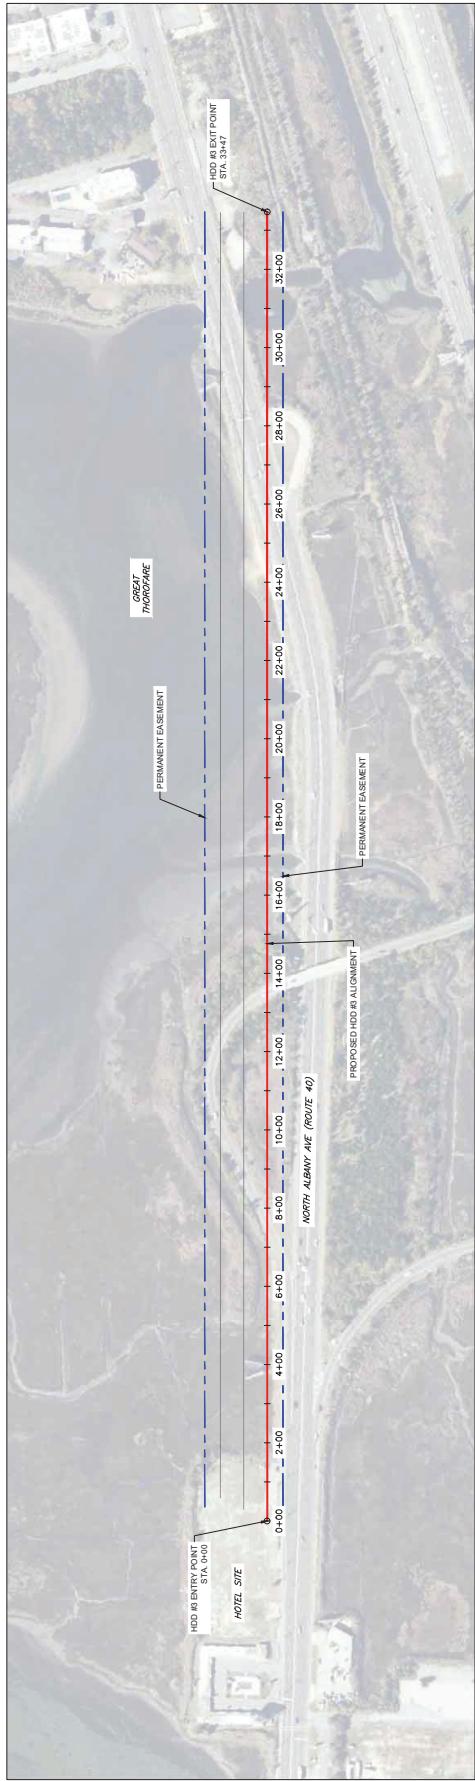



Figure 11. Great Thorofare Crossing #3 HDD Plan & Profile

ISSUE FOR PERMIT


PROJECT #		0002
ROUTE #		ROUTE 40
DESCRIPTION		HORIZONTAL DRILLING
STATION (ft)		8.00
ELEVATION (ft)		8.00
ENTRY @ 12° =		
PC1 =		0+67.25 -6.30
(200' RADIUS)		
PT1 =		4+83.08 -50.00
PC2 =		28+54.43 -50.00
PT2 =		32+01.73 -19.32
EXIT @ 10° =		334.70 FT 6.00
HORIZONTAL DISTANCE =		334.70 FT
DIRECTIONAL DRILL PIPE LENGTH =		335.57 FT
DIRECTIONAL DRILL PIPE LENGTH =		335.57 FT
DRAFTER:		LAPONTINE, NJ
DRAWING DATE:		9/21/2019
DRAWING TITLE:		HDD #3 CROSSING
DRAWING #:		017

Project Plan Sheet 28

FOR ILLUSTRATIVE PURPOSES ONLY

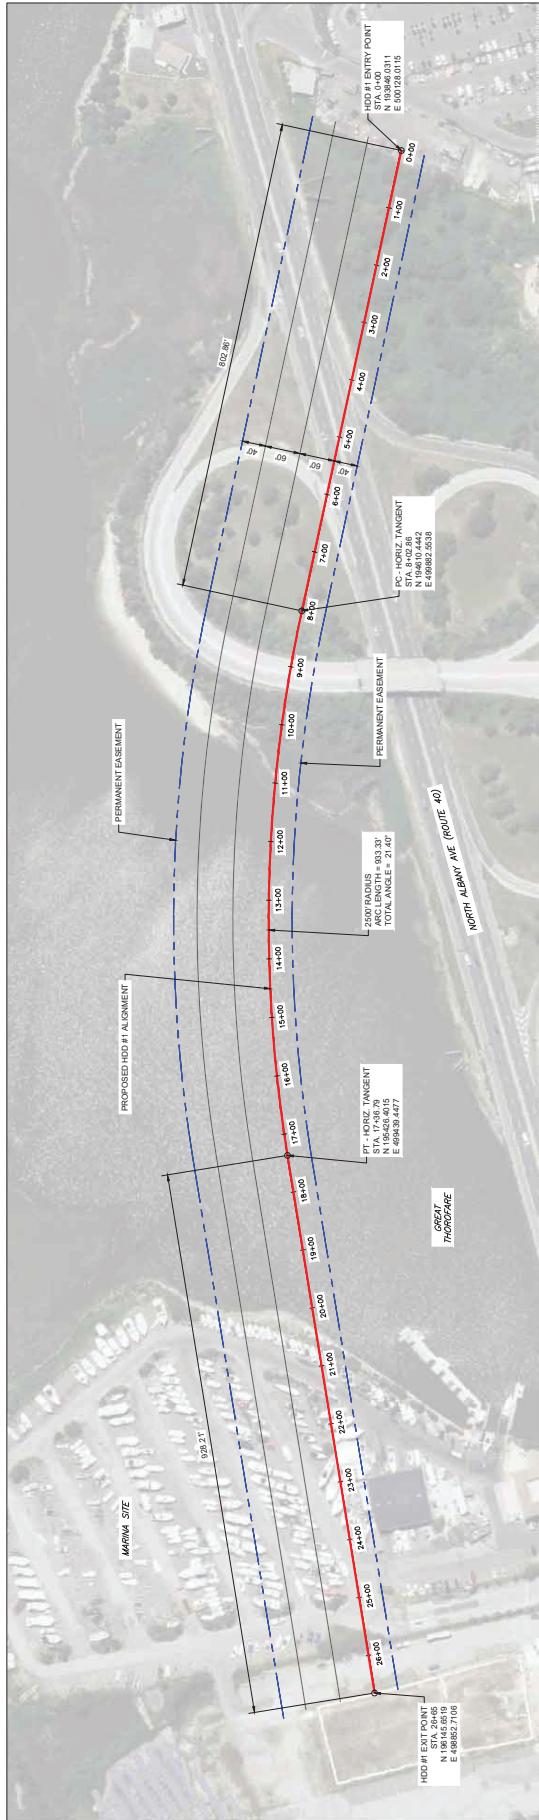

PLAN VIEW
0 100' 200' 300'
SCALE IN FEET

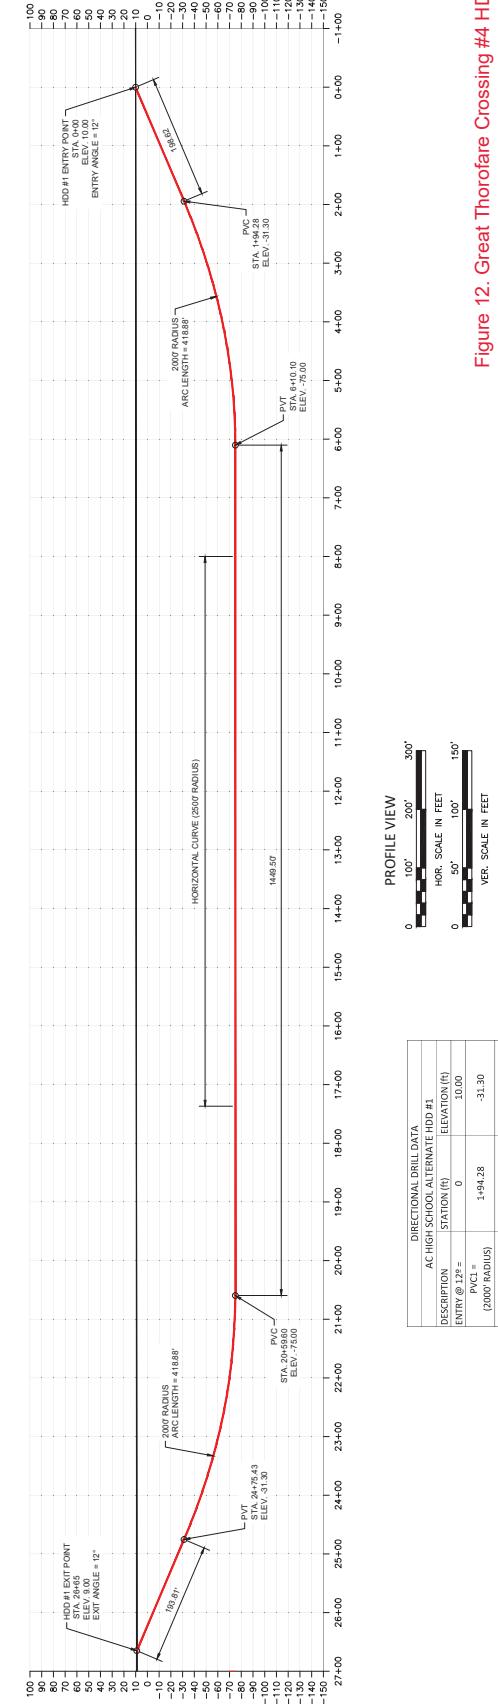



ISSUE FOR PERMIT

Figure 12. Great Throfare Crossing #4 HDD Plan & Profile

DRAWING #		018	
ATLANTIC SHORES OFFSHORE WIND COP SOUTH TERRESTRIAL			
DRAWING TITLE: AC ELECTRIC ALTERNATE			
DRAWING # PLAN AND PROFILE			
HORIZONTAL COORDINATES:		VERTICAL DATA: NO H. EASE, S. SURF FST	
HORIZONTAL DATA: NO H. EASE, S. SURF FST		VERTICAL DATA: NO H. EASE, S. SURF FST	
ELEVATION SPECIFICATIONS:			
HHC ENCL. & 10-in. DTH 20-ft. X 4-in. RFL HOLE COUNTERS			
HHC ENCL. & 10-in. DTH 20-ft. X 4-in. RFL HOLE COUNTERS			



Project Plan Sheet 29

FOR ILLUSTRATIVE PURPOSES ONLY

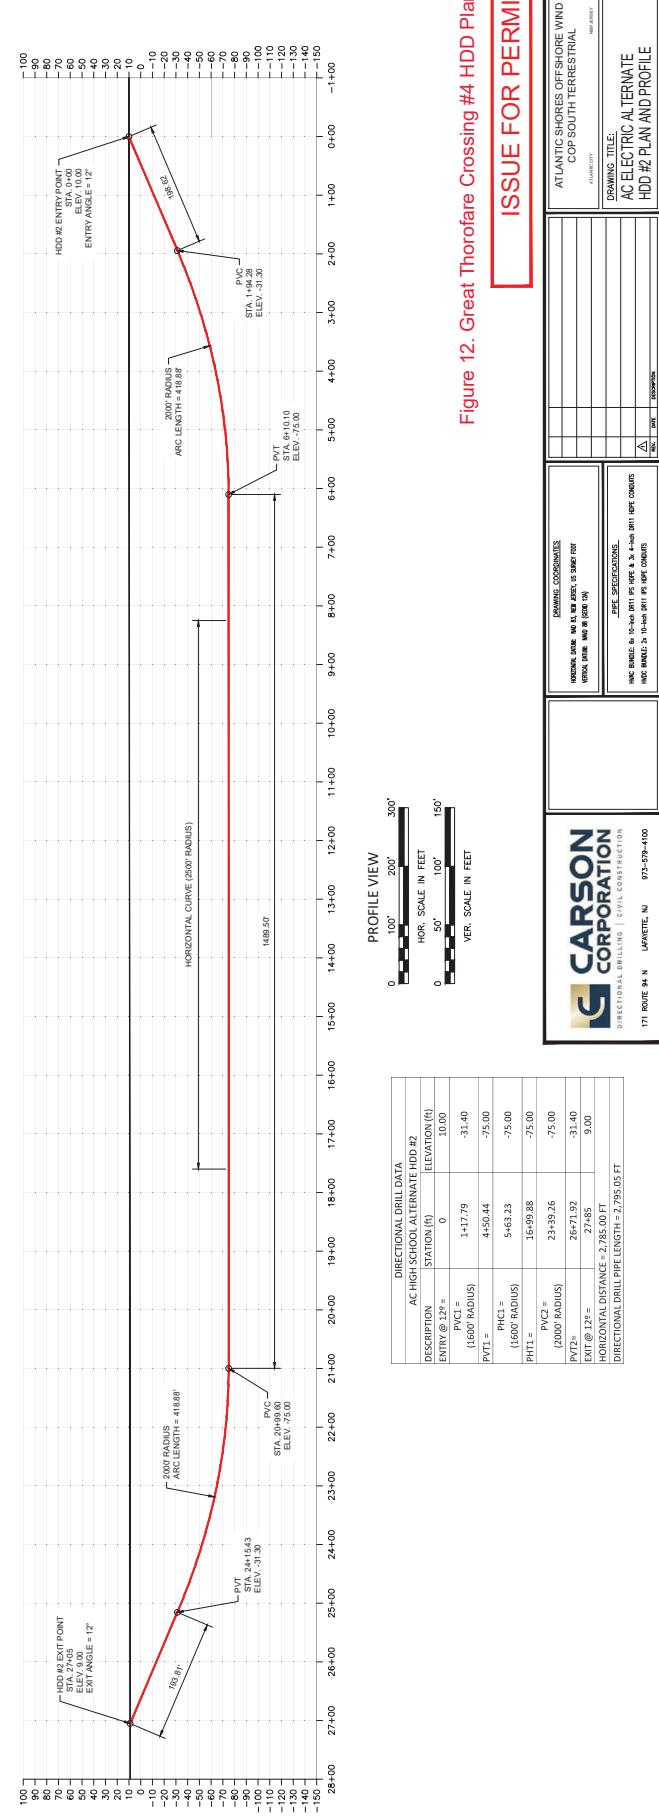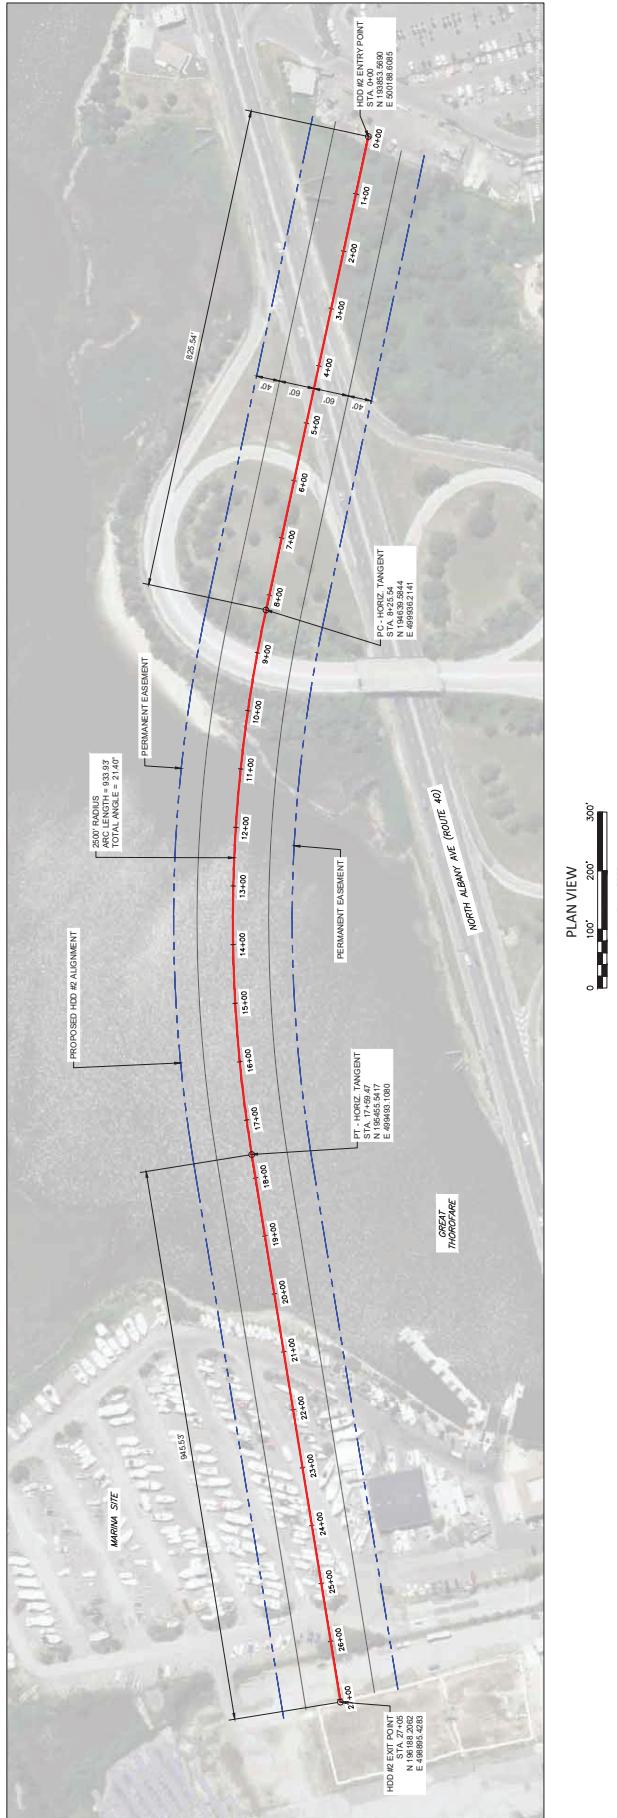

Project Plan Sheet 30

FOR ILLUSTRATIVE PURPOSES ONLY

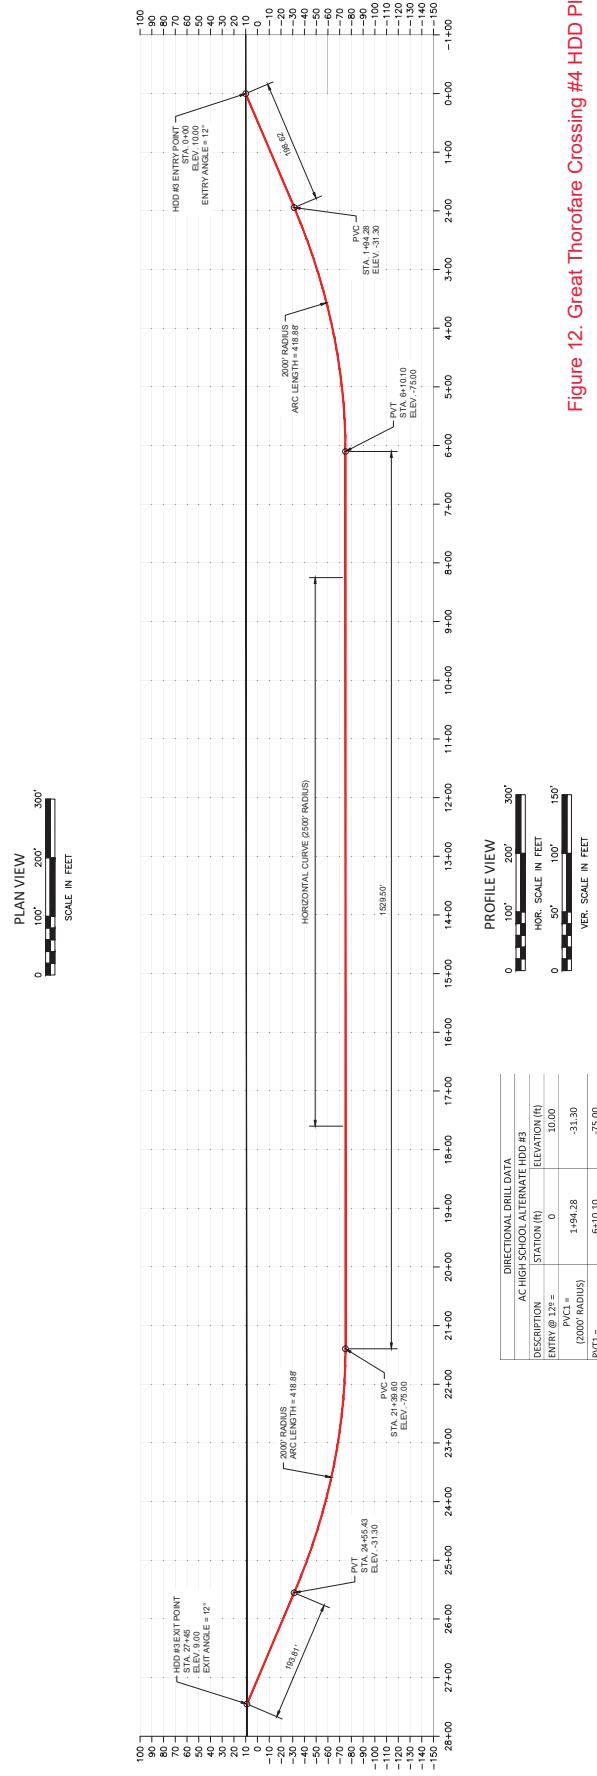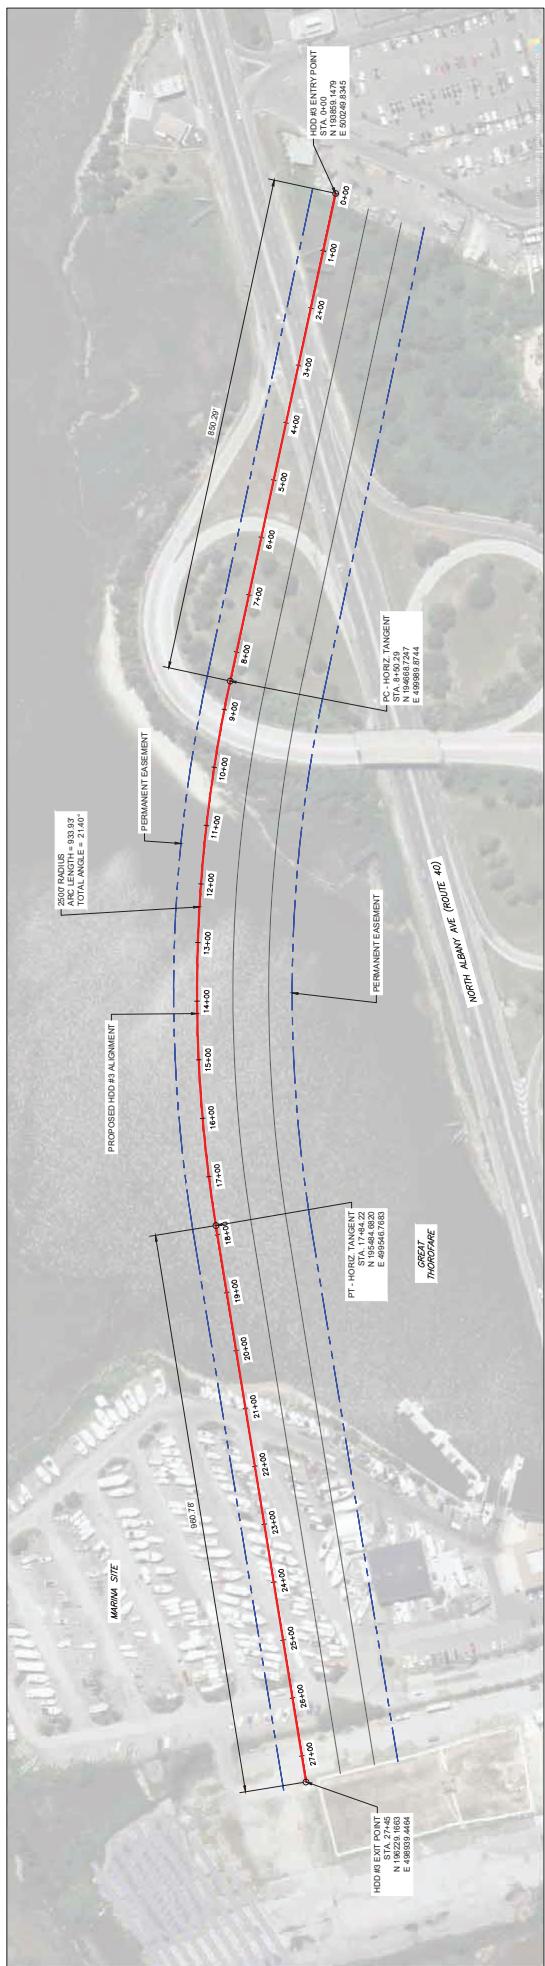

ISSUE FOR PERMIT

DRAFTER'S SIGNATURE		DATE: 10/10/2013	
DRAFTER'S NAME: JEFFREY L. HARRIS		DRAWING NUMBER: 020	
DESIGNER'S SIGNATURE		REVISION NUMBER: 0	
DESIGNER'S NAME: JEFFREY L. HARRIS		DRAWING TITLE: ATLANTIC SHORES OFF SHORE WIND	
CONTRACTOR'S SIGNATURE		SPECIFICATION NUMBER: AC ELECTRIC ALTERNATE	
CONTRACTOR'S NAME: CARSON CORPORATION		SUB-CONTRACTOR'S SIGNATURE	
CONTRACTOR'S ADDRESS: 171 ROUTE 9A N, LAFAYETTE, NJ 07849		SUB-CONTRACTOR'S ADDRESS: 973-579-4100	
PROJECT NUMBER: PWC2		PROJECT NAME: ATLANTIC SHORES OFF SHORE WIND	
PVC2 = 24+59.60		HORIZONTAL DISTANCE = 2,745.00 FT	
PV72 = 24+5.43		DIRECTIONAL DRILL PIPE LENGTH = 2,753.69 FT	
EXT @ 12° = 27+45			
9.00			
DRAWINGS, COORDINATES ORIGINAL, DUPLICATES, NO. 1, NEW EDITION, SAME FOR EXTRA NAME: NO. 8 (EDITION 09)			
DRAWING DATE: NO. 1, NEW EDITION, SAME FOR EXTRA NAME: NO. 8 (EDITION 09)			
DRAWING NUMBER: 020			
DRAWING DATE: NO. 1, NEW EDITION, SAME FOR EXTRA NAME: NO. 8 (EDITION 09)			
DRAWING NUMBER: 020			

Project Plan Sheet 31

FOR ILLUSTRATIVE PURPOSES ONLY

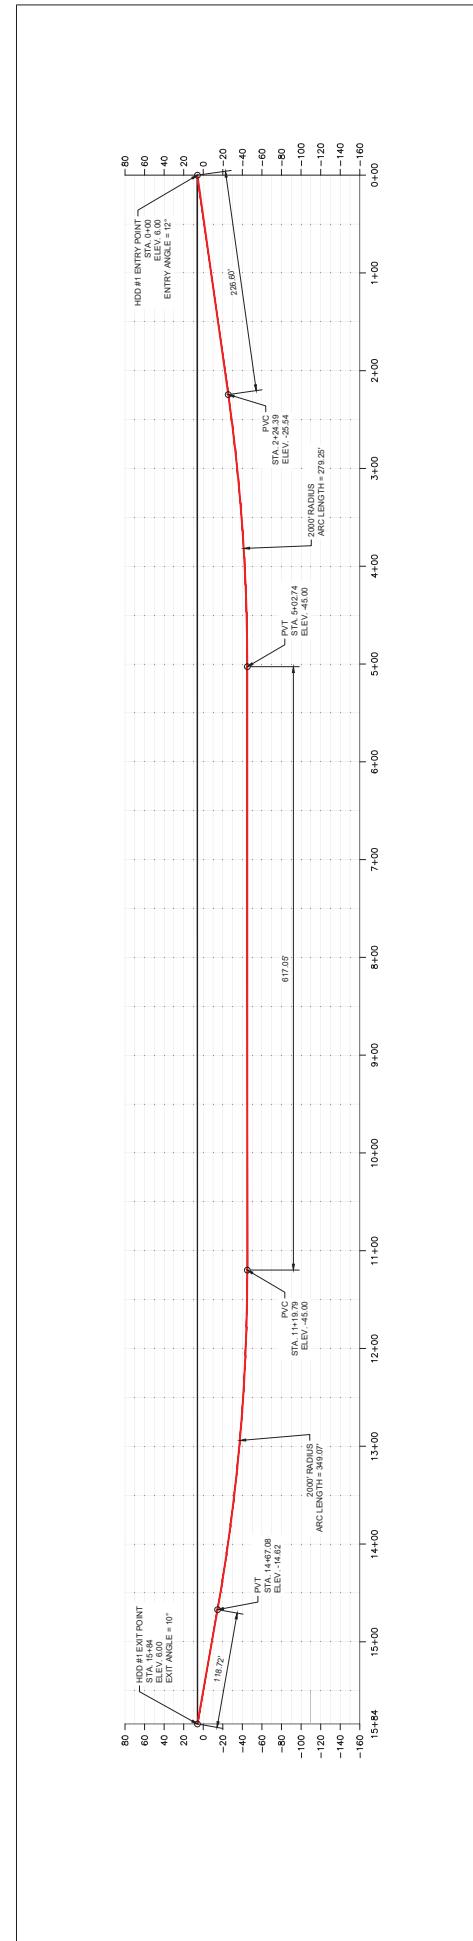
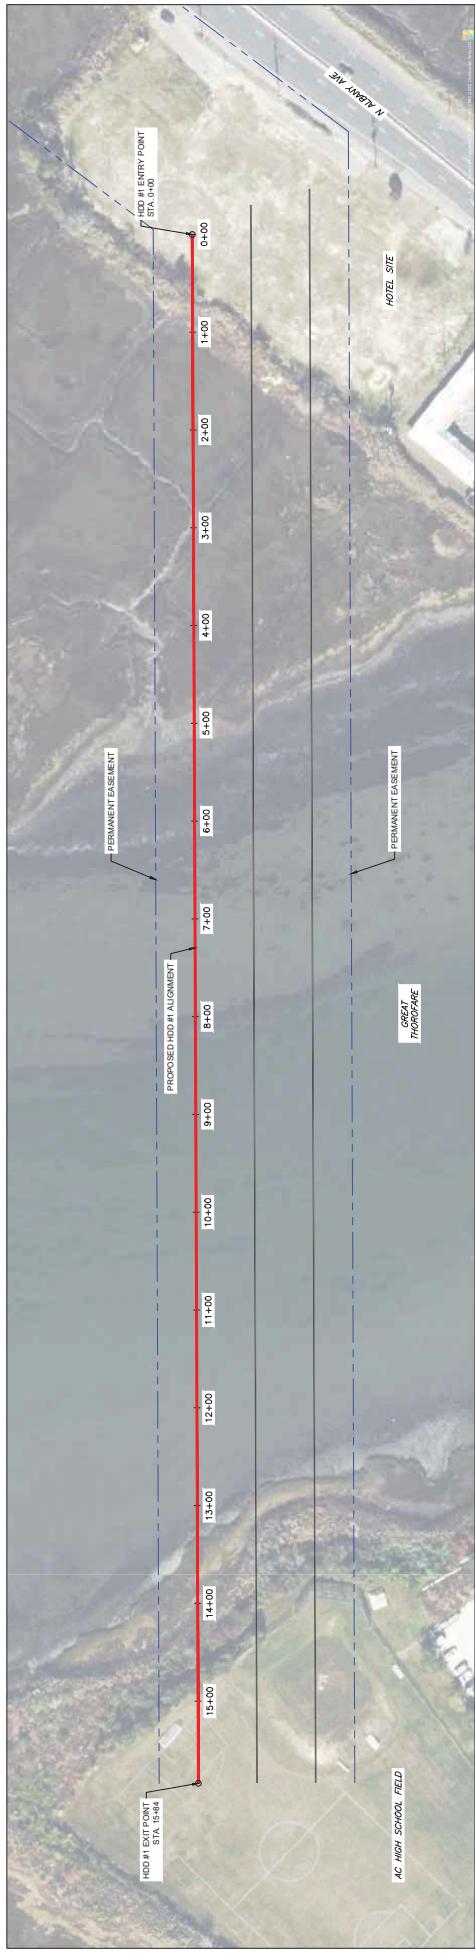


Figure 13. Great ThoroFare Crossing #5 HDD Plan & Profile

ISSUE FOR PERMIT

DRAWING #		012
PROJECT #		
ATLANTIC SHORES OFFSHORE WIND COP SOUTH TERRESTRIAL		
DRAWING TITLE:		
AC HIGH SCHOOL TO HOTEL		
DRAWING NUMBER:		
HDD #1 PLAN AND PROFILE		
SCALE:		
DATE:		
REMARKS:		
DRAFTER:		
CHECKER:		
APPROVING OFFICER:		
HIC NUMBER & 10-digit RTIN #: 000-000000000000000000		
HIC NUMBER & 10-digit RTIN #: 000-000000000000000000		
HIC NUMBER & 10-digit RTIN #: 000-000000000000000000		

Project Plan Sheet 32

FOR ILLUSTRATIVE PURPOSES ONLY

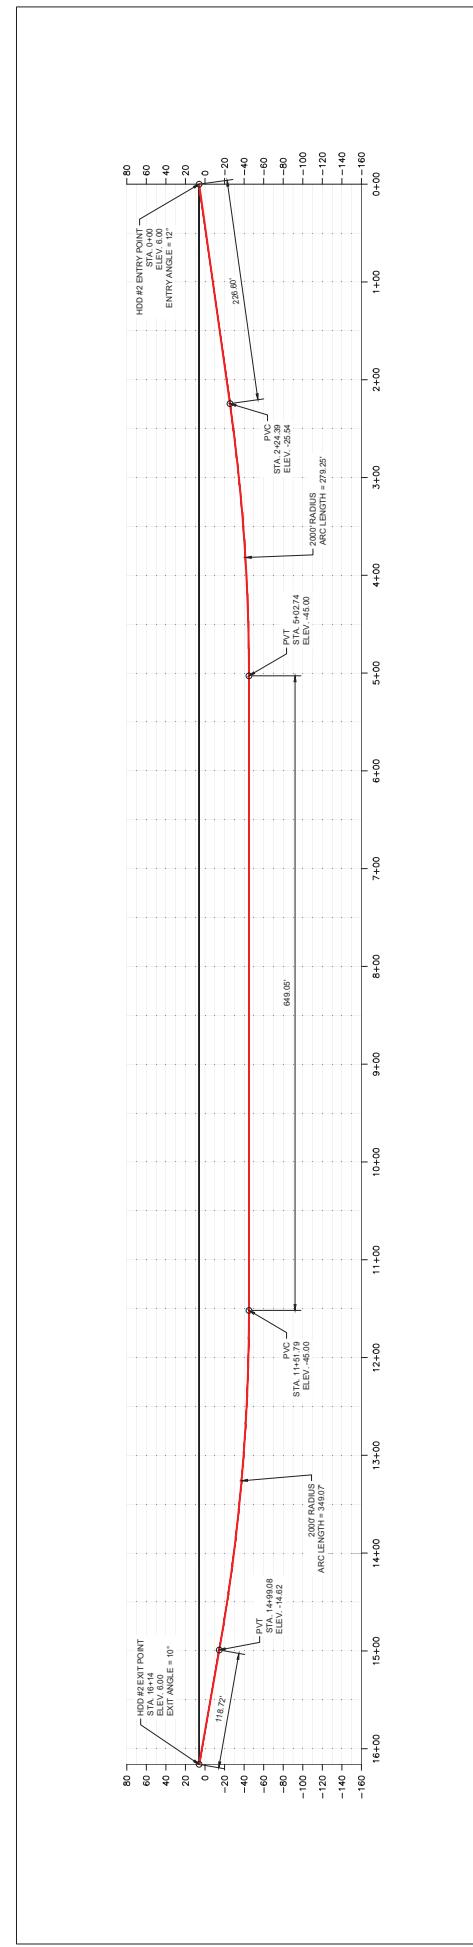
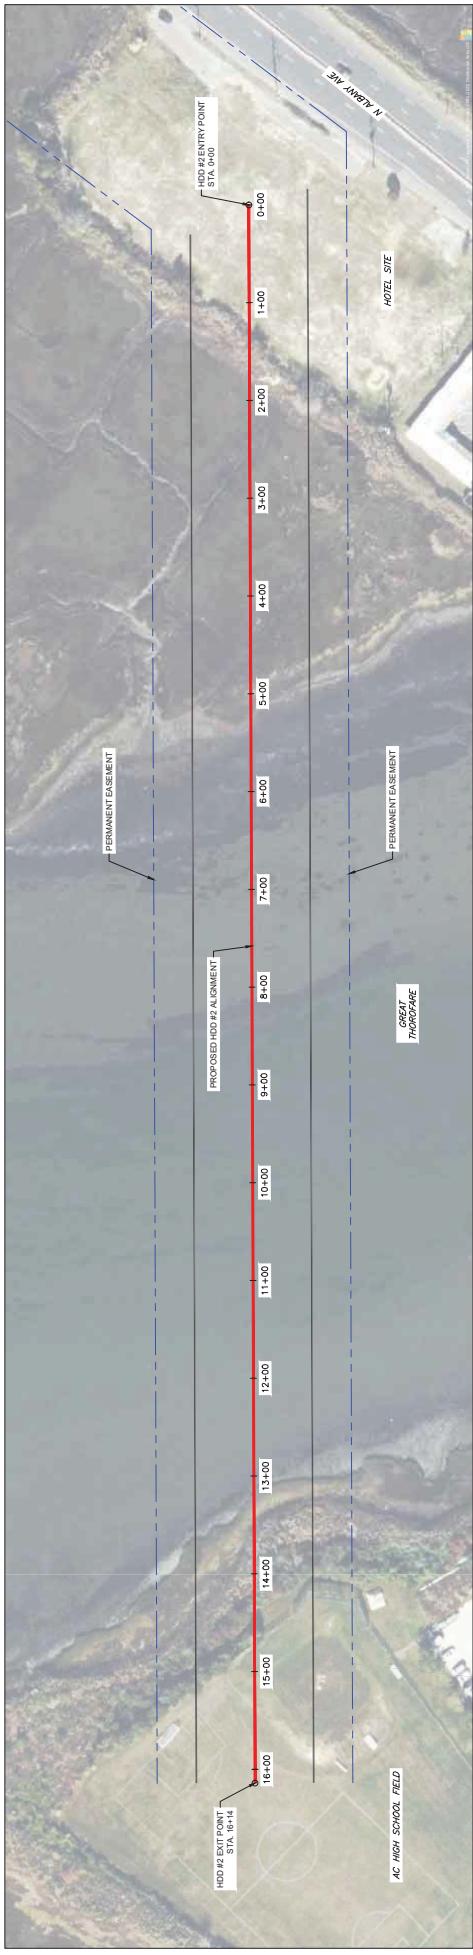


Figure 13. Great ThoroFare Crossing #5 HDD Plan & Profile

ISSUE FOR PERMIT

DRAWING #		013
PROJECT #		
ATLANTIC SHORES OFFSHORE WIND COP SOUTH TERRESTRIAL		
DRAWING TITLE: AC HIGH SCHOOL TO HOTEL		
DRAWING TYPE: HDD #2 PLAN AND PROFILE		
REVISIONS:		
HORIZONTAL DRILL PIPE LENGTH = 1614.00 FT DIRECTIONAL DRILL PIPE LENGTH = 1622.68 FT		
HORIZONTAL DRILL PIPE DIAMETER = 24 INCHES DIRECTIONAL DRILL PIPE DIAMETER = 24 INCHES		
HORIZONTAL DRILL PIPE WALL THICKNESS = 1/2 INCH DIRECTIONAL DRILL PIPE WALL THICKNESS = 1/2 INCH		
HORIZONTAL DRILL PIPE LENGTH = 1614.00 FT DIRECTIONAL DRILL PIPE LENGTH = 1622.68 FT		
HORIZONTAL DRILL PIPE DIAMETER = 24 INCHES DIRECTIONAL DRILL PIPE DIAMETER = 24 INCHES		
HORIZONTAL DRILL PIPE WALL THICKNESS = 1/2 INCH DIRECTIONAL DRILL PIPE WALL THICKNESS = 1/2 INCH		

Project Plan Sheet 33

FOR ILLUSTRATIVE PURPOSES ONLY

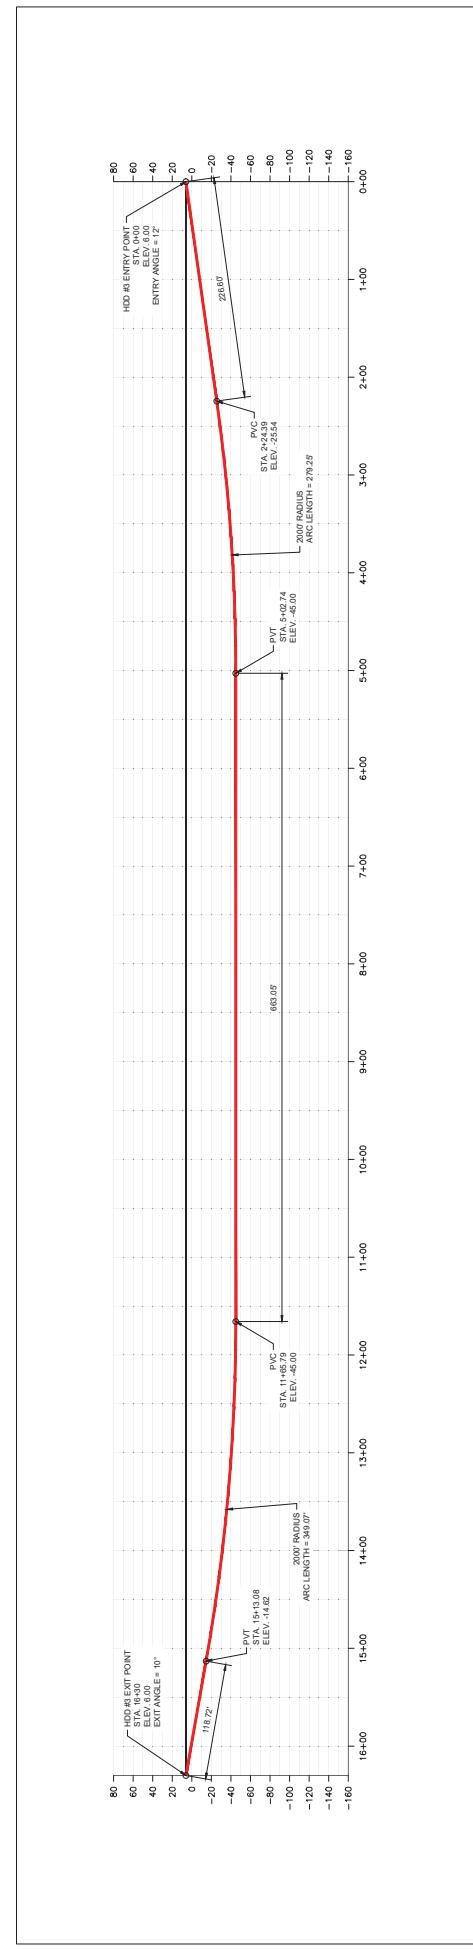
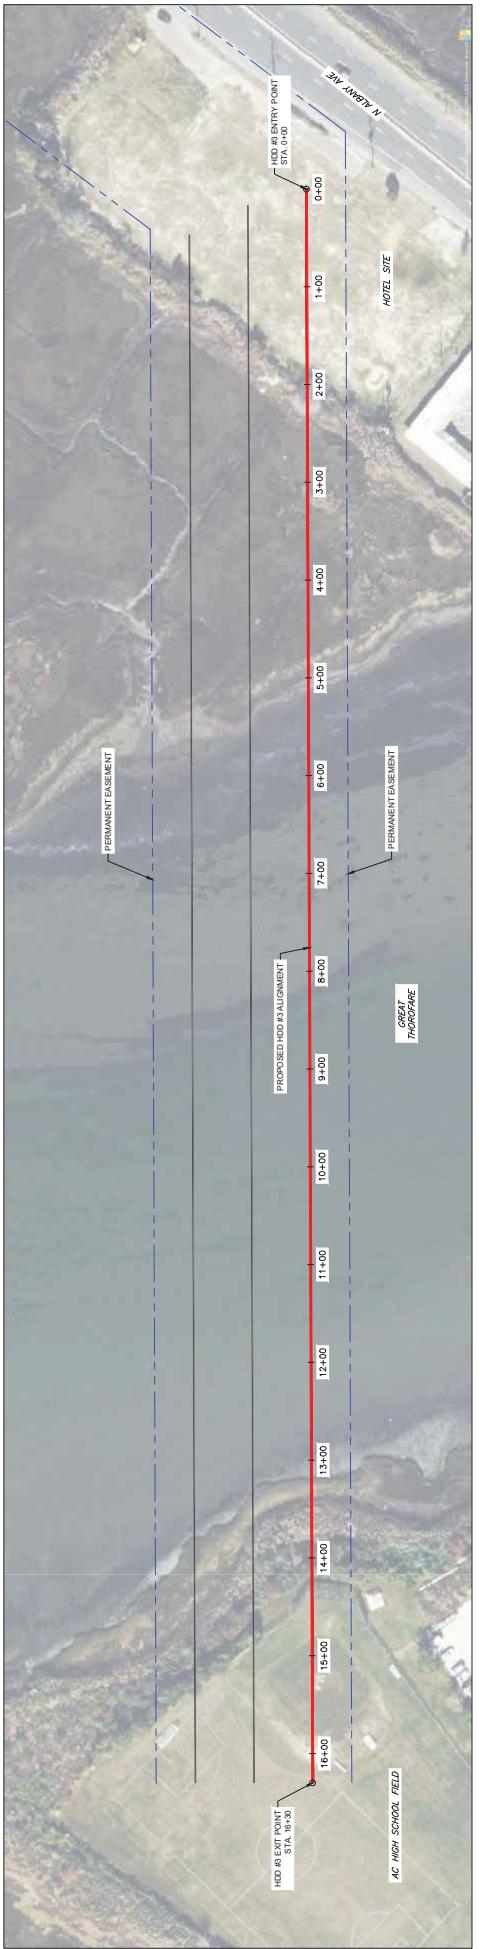


Figure 13. Great Thorofare Crossing #5 HDD Plan & Profile

ISSUE FOR PERMIT

DRAWING #		014
PROJECT #		A020
DRAWING DATE		10/22/2022
DRAWING NUMBER		10
DRAWING TITLE		ATLANTIC SHORES OFFSHORE WIND COP SOUTH TERRISTRIAL
DRAWING COMMENTS		CONTINUATION OF
HOLDING COORDINATES		
HOLDING DATE / TIME		10/22/2022 08:30:00 AM
VERSION		1.00
VERSION DATE		10/22/2022
VERIFIED BY		WOB (2022-19)
SPECIFICATIONS		INCUBUS: 6-in-10-in DRILL PIPS & 4-in-6-in DRILL PIPS PIPE: 3000 psi API 5L GR. B ANCHOR: 2x 10-in DRILL PIPS API 5L CABLE: 12-in-10-in DRILL PIPS API 5L DRAWS: 6-in-10-in DRILL PIPS API 5L
DIRECTIONAL DRILLING - CIVIL CONSTRUCTION		
171 Route 9A N		LAPERRETTTE, NJ
		973-259-4100