

CITY OF OCEAN CITY, NEW JERSEY



A north arrow pointing upwards and a scale bar labeled "SCALE IN FEET" with markings at 0, 30,000, and 60,000.

ONE INCH
AT FULL SIZE, IF NOT ONE
INCH SCALE ACCORDINGLY

GENERAL NOTES

1. THE OWNER'S REPRESENTATIVE SHALL BE PROMPTLY NOTIFIED IN WRITING OF ANY CONDITIONS THAT VARY MATERIALLY FROM THOSE SHOWN IN THE CONTRACT DOCUMENTS.
2. THE CONTRACTOR'S WORK SHALL NOT VARY FROM THESE DRAWINGS WITHOUT THE WRITTEN APPROVAL OF THE OWNER'S REPRESENTATIVE.
3. DETAILS SHOWN ARE TYPICAL; SIMILAR DETAILS APPLY TO SIMILAR CONDITIONS UNLESS OTHERWISE NOTED.
4. THE CONTRACTOR SHALL COMPLY WITH ALL REQUIRED PERMITS AND OTHER APPLICABLE REGULATORY REQUIREMENTS.
5. THE CONTRACTOR SHALL ABIDE BY THE REQUIREMENTS OF THE TECHNICAL SPECIFICATIONS AND THE CONTRACTOR'S HEALTH AND SAFETY PLAN (HASP), AS APPROPRIATE, AS WELL AS APPLICABLE OCCUPATIONAL SAFETY AND HEALTH ADMINISTRATION (OSHA) REGULATIONS.
6. THE CONTRACTOR IS RESPONSIBLE FOR SAFETY OF SITE PERSONNEL.
7. THE CONTRACTOR SHALL ADEQUATELY PROTECT ALL EXISTING STRUCTURES OR UTILITIES. ANY DAMAGE TO EXISTING STRUCTURES, SHORELINES, OR UTILITIES SHALL BE THE SOLE RESPONSIBILITY OF THE CONTRACTOR.
8. THE CONTRACTOR IS RESPONSIBLE FOR OBTAINING ALL UTILITY MARKOUTS AND FORWARDING CONFIRMATION OF NOTIFICATION TO THE OWNER'S REPRESENTATIVE. THE CONTRACTOR SHALL BE RESPONSIBLE TO OBTAIN ANY AND ALL NECESSARY PERMITS FROM THE AFFECTED UTILITY COMPANIES AND FOR SCHEDULING OF INSPECTIONS BY UTILITY COMPANY PERSONNEL, IF REQUIRED, DURING CONSTRUCTION.
9. THE CONTRACTOR SHALL BE RESPONSIBLE FOR SEDIMENT CONTROL MEASURES DURING THE CONSTRUCTION PERIOD, AS REQUIRED BY THE PERMITS, LOCAL ORDINANCES, PLANS, AND SPECIFICATIONS.
10. THE CONTRACTOR IS RESPONSIBLE FOR MAINTAINING A NEAT AND ORDERLY SITE, YARD AND GROUNDS. REMOVE AND DISPOSE OFF SITE ALL RUBBISH, WASTE MATERIALS, LITTER, AND ALL FOREIGN SUBSTANCES. PROMPTLY NOTIFY APPROPRIATE AUTHORITIES AND OWNER'S REPRESENTATIVE, AND REMOVE PETRO-CHEMICAL SPILLS, STAINS AND OTHER FOREIGN DEPOSITS IN ACCORDANCE WITH LOCAL, STATE, AND FEDERAL REGULATIONS.
11. THE CONTRACTOR SHALL FIELD VERIFY SEDIMENT PHYSICAL PROPERTIES AND OTHER SITE FEATURES. CONTRACTOR ACKNOWLEDGES THAT THEY HAVE UNDERTAKEN ANY PRE-BID INVESTIGATION THEY DEEM NECESSARY TO DETERMINE TO COMPOSITION, SIZE, SHAPE, LOCATION AND DEPTH OF MATERIALS THAT WILL BE ENCOUNTERED.
12. NON-CONFORMING MATERIALS OR CONDITIONS SHALL BE REPORTED TO THE OWNER'S REPRESENTATIVE PRIOR TO CORRECTIVE ACTION. ANY SUCH ACTION SHALL REQUIRE APPROVAL BY THE OWNER'S REPRESENTATIVE.
13. THE CONTRACTOR IS ADVISED THAT ALL LOCAL PUBLIC NUISANCE LAWS AND NOISE ORDINANCES SHALL BE OBSERVED DURING THE COURSE OF CONSTRUCTION.
14. THE CONTRACTOR SHALL RESTORE ALL PUBLIC OR PRIVATE PROPERTY AFFECTED BY CONSTRUCTION ACTIVITIES TO AT LEAST AS GOOD OF CONDITION AS BEFORE CONSTRUCTION ACTIVITIES, AS DETERMINED BY THE OWNER'S REPRESENTATIVE.
15. IN THE EVENT OF CONFLICT BETWEEN THESE DRAWINGS AND THE TECHNICAL SPECIFICATIONS THE TECHNICAL SPECIFICATIONS SHALL GOVERN.

DATUM NOTES


1. HORIZONTAL DATUM: NEW JERSEY STATE PLANE, NAD 83, U.S. FEET.
2. VERTICAL DATUM: NORTH AMERICAN VERTICAL DATUM OF 1988 (NAVD88)

DATA SOURCES

1. BATHYMETRIC SURVEY DATA WAS COLLECTED BY ACT ENGINEERS IN FEBRUARY 2017.
2. BASEMAPS PROVIDED BY THE CITY OF OCEAN CITY, JULY 2015
3. BASE LINE WORK PREPARED BY ACT ENGINEERS, INC. BASED ON FIELD SURVEY CONDUCTED ON FEBRUARY 14, 2017 THROUGH MARCH 1, 2017 AND SUPPLEMENTED WITH NEARSHORE TOPOGRAPHY COLLECTED ON JULY 27, 2017. ADDITIONAL TOPOGRAPHIC SURVEY CONDUCTED IN MAY AND AUGUST 2019 BY ACT ENGINEERS, INC.

SEQUENCE OF CONSTRUCTION

1. PRE-CONSTRUCTION MEETING WITH CONTRACTOR, OWNER, OWNER'S REPRESENTATIVE, AND KEY STAKEHOLDERS.
2. NO CONSTRUCTION ACTIVITY MAY COMMENCE PRIOR TO REVIEW AND ACCEPTANCE OF CONTRACTOR'S REQUIRED WORK PLANS AND PRE-CONSTRUCTION SUBMITTALS.
3. COMPLETE NECESSARY NOTIFICATIONS AND UTILITY LOCATION TASKS.
4. MOBILIZATION OF PERSONNEL, EQUIPMENT, FACILITIES, AND MATERIALS REQUIRED TO COMPLETE THE WORK.
5. INSTALL ENVIRONMENTAL CONTROLS AND MAINTAIN CONTROLS THROUGH DURATION OF THE PROJECT.
6. CONSTRUCT SHORELINE ACCESS AREA WITHIN LIMITS SHOWN ON THESE DRAWINGS.
7. CLOSURE OF LIVING SHORELINE ROCK SILL FISH WINDOWS AND PLACEMENT OF TURBIDITY CONTROLS.
8. CONDUCT PHASE 2 RESTORATION BACKFILL PLACEMENT OPERATIONS. TOTAL PHASE 2 BACKFILL VOLUME IS 11,200 CY.
9. CONDUCT PHASE 3 THIN LAYER PLACEMENT IN THE SEQUENCE IDENTIFIED ON SHEET C-10 AND IN THE TECHNICAL SPECIFICATIONS.
10. CONDUCT PHASE 4 CDF RESTORATION OPERATIONS.
11. COMPLETE SITE DEMOBILIZATION AND RESTORATION ACTIVITY.
12. IMPLEMENTATION OF SITE LONG-TERM MONITORING PLAN. INCLUDES REGULAR MONITORING AND REPORTING ACTIONS, AS WELL AS CONTINGENCY OR ADAPTIVE MANAGEMENT MEASURES, AS NECESSARY.

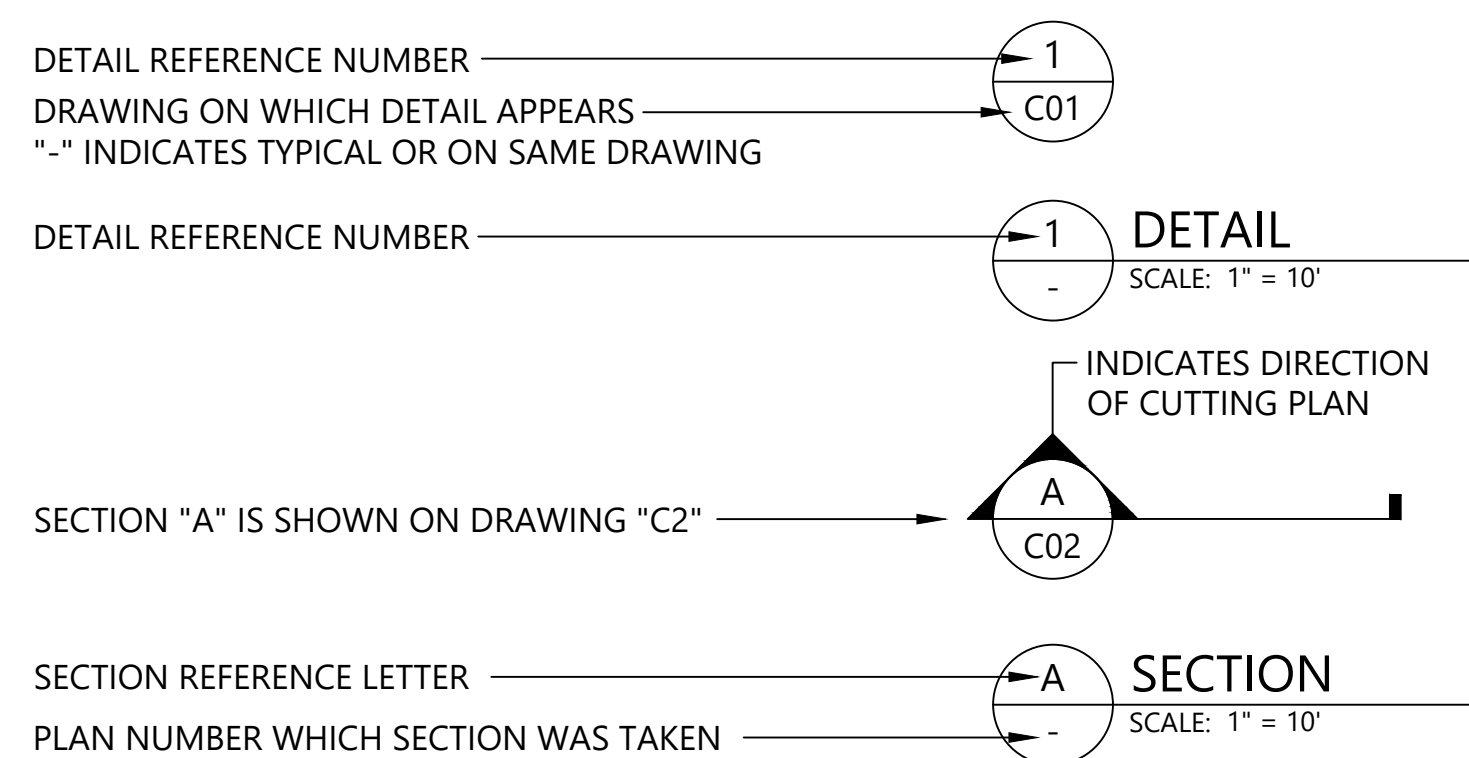

DETAIL AND SECTION REFERENCING

[illegible]

DESIGNED BY: S. BAGNULL
DRAWN BY: B. HURRY
CHECKED BY: T. MERRITTS
APPROVED BY: R. MOHAN
SCALE: AS NOTED
DATE: NOVEMBER 2019

**SHOOTING ISLAND HABITAT RESTORATION AND
COASTAL RESILIENCY PROJECT- PHASES 2, 3, AND 4
CITY OF OCEAN CITY, NJ**

GENERAL NOTES

G-02

SHEET NO. **2** OF **21**

ONE INCH
AT FULL SIZE, IF NOT ONE
INCH SCALE ACCORDINGLY

K:\Projects\1314-ACT Engineers Inc\NEW Phase 2 through 4\Construction Plans\T-01-COVER SHEET.dwg E-01
Nov 17, 2019 12:53 pm bhury



Description	Elevation (Feet, NAVD88)
High Tide Line	2.90
Spring High Tide	2.22
Mean Higher High Water Line	1.95
Mean High Water	1.55
Mean Low Water	-2.23
Mean Lower Low Water	-2.38

LEGEND:

- EXISTING LIVING SHORELINE SILL
- EXISTING CONCRETE HABITAT BLOCK SHORELINE
- 1978 SHORELINE
- 1978 TIDAL CREEK
- 2019 SURVEY ELEVATION CONTOURS, 1 AND 5 FOOT, NAVD88
- 2017 SURVEY SHORELINE (ELEVATION 0, NAVD88)
- 2017 SURVEY OSPREY NEST
- CHANNEL MARKER
- PRIVATE AID TO NAVIGATION

NOTES:

- HORIZONTAL DATUM: NEW JERSEY STATE PLANE, NAD83, U.S. FEET.
- VERTICAL DATUM: NORTH AMERICAN VERTICAL DATUM OF 1988 (NAVD88)
- AERIAL IMAGERY WAS OBTAINED FROM THE NJGIN INFORMATION WAREHOUSE, DATED 2007.
- BASE LINE WORK PREPARED BY ACT ENGINEERS, INC. BASED ON FIELD SURVEY CONDUCTED ON FEBRUARY 14, 2017 THROUGH MARCH 1, 2017 AND SUPPLEMENTED WITH NEARSHORE TOPOGRAPHY COLLECTED ON JULY 27, 2017. ADDITIONAL TOPOGRAPHIC SURVEY CONDUCTED IN MAY AND AUGUST 2019 BY ACT ENGINEERS, INC.
- SHELLFISH LEASE BOUNDARIES PROVIDED BY ACT IN MAY 2017.




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







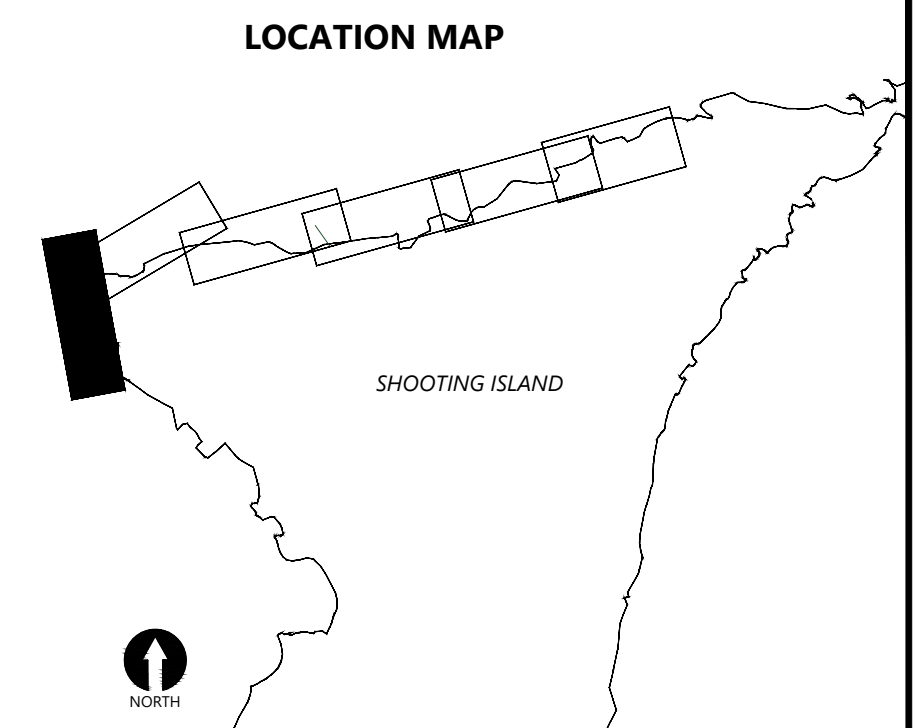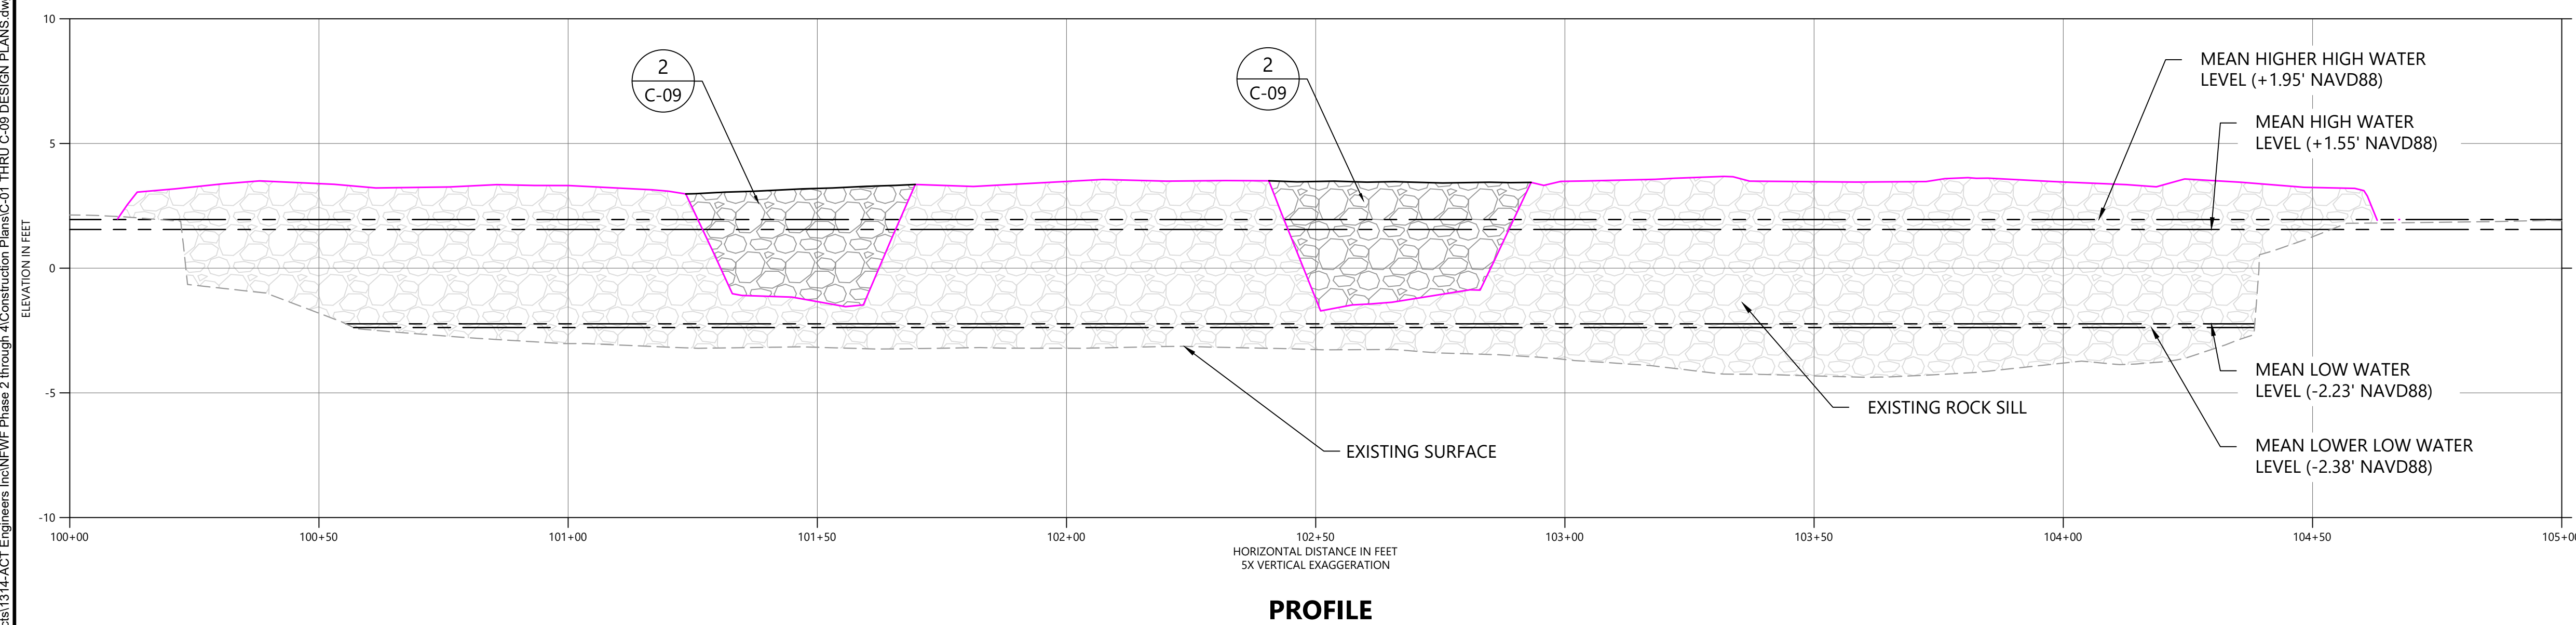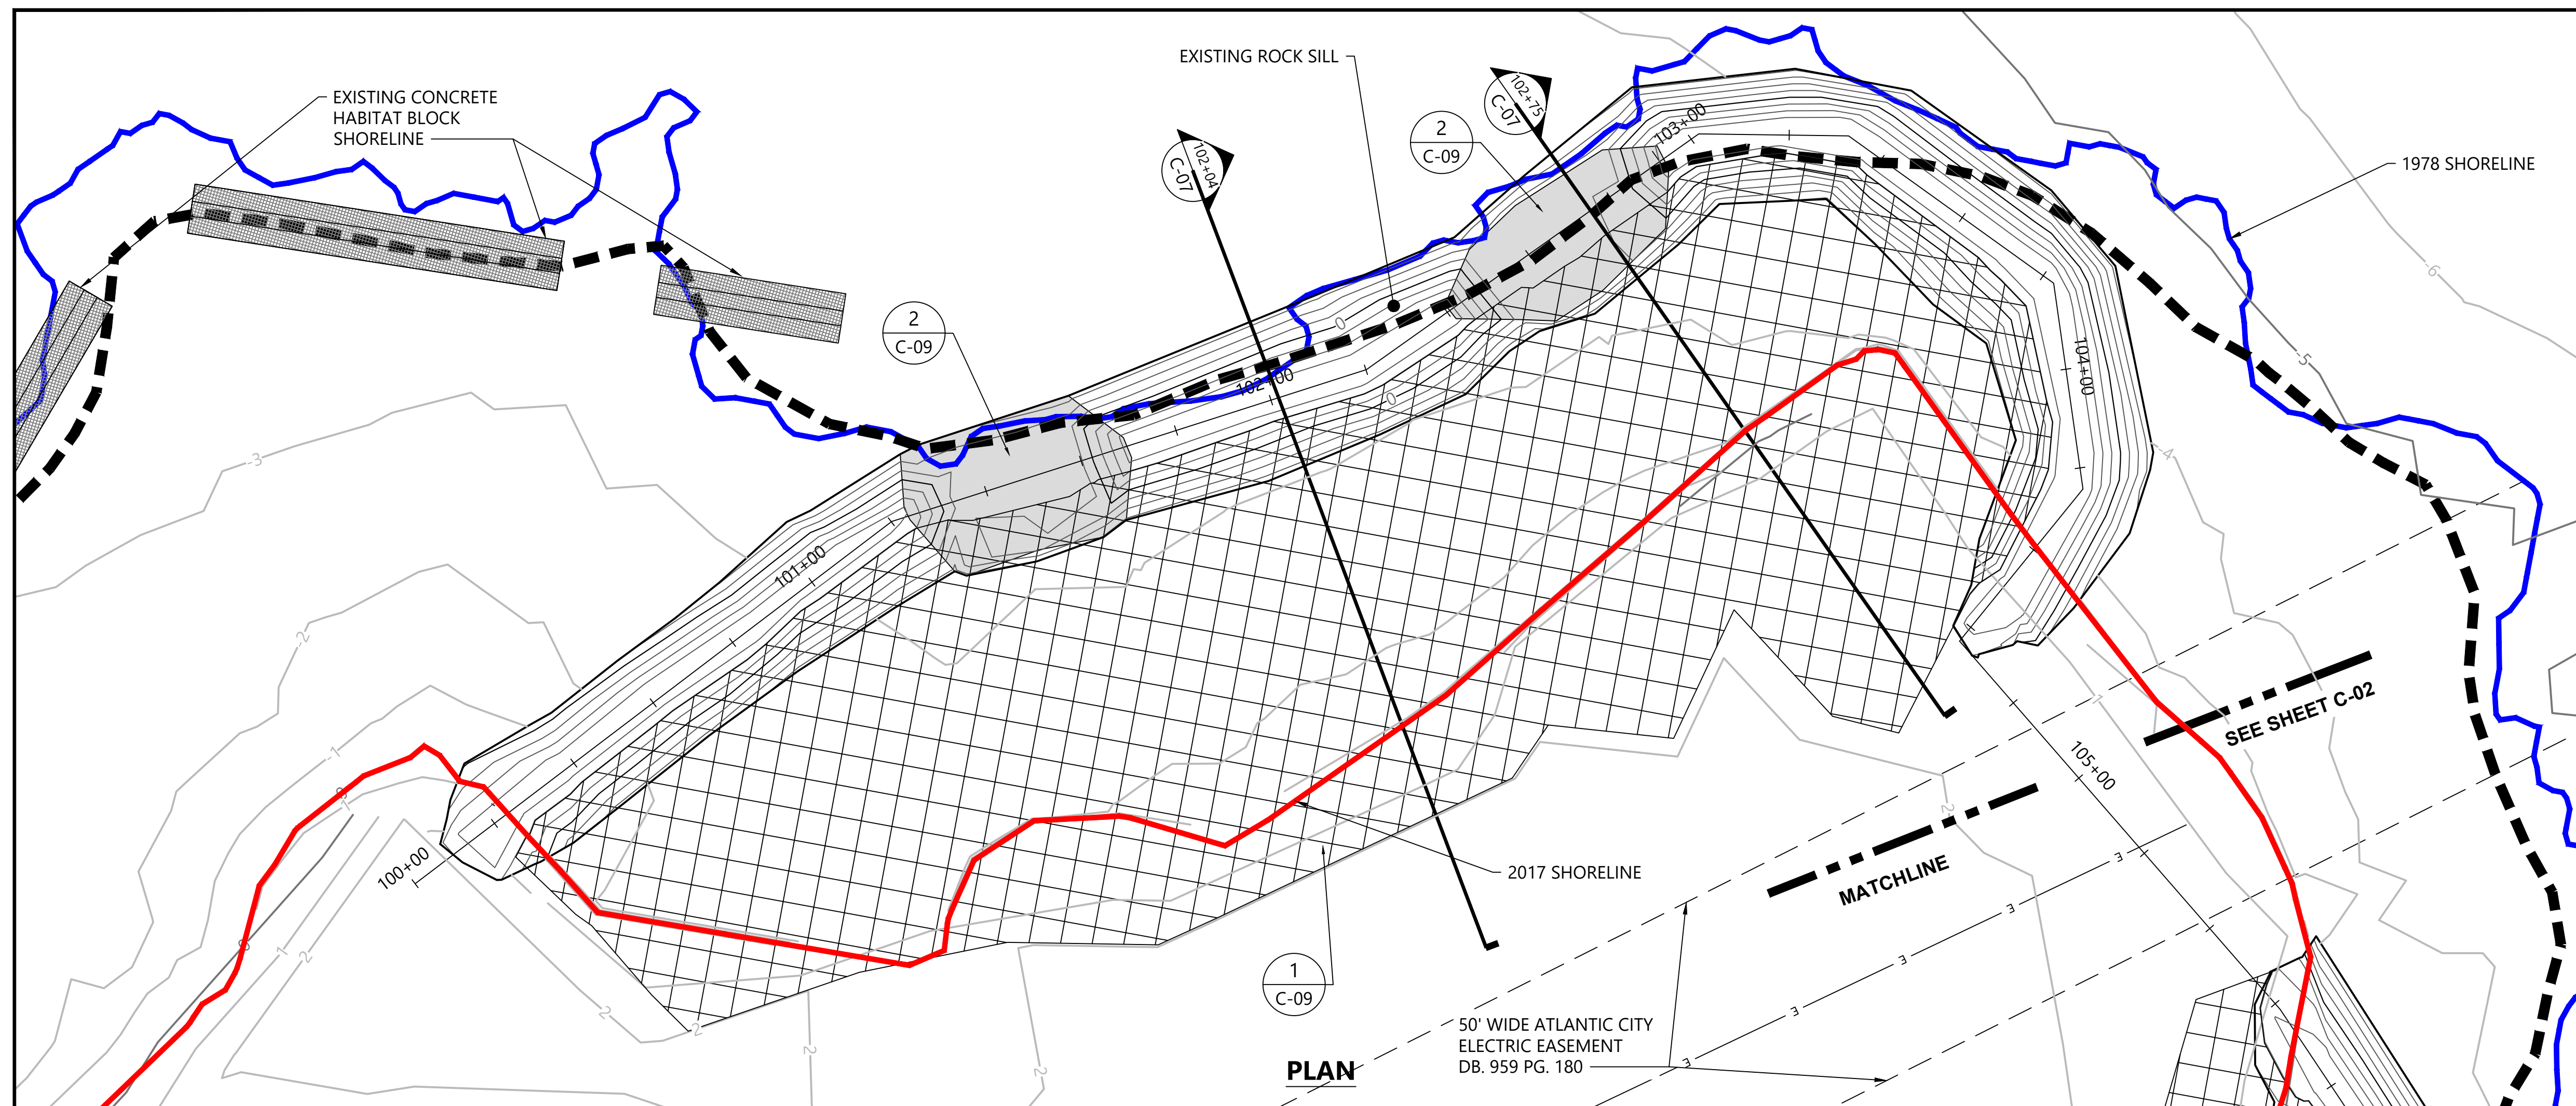


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ONE INCH

AT FULL SIZE. IF NOT ONE INCH SCALE ACCORDINGLY

			<table><tr><th>REV</th><th>DATE</th><th>BY</th><th>APP'D</th><th>DESCRIPTION</th></tr><tr><td> </td><td> </td><td> </td><td> </td><td> </td></tr><tr><td> </td><td> </td><td> </td><td> </td><td> </td></tr><tr><td> </td><td> </td><td> </td><td> </td><td> </td></tr><tr><td> </td><td> </td><td> </td><td> </td><td> </td></tr></table>	REV	DATE	BY	APP'D	DESCRIPTION																					DESIGNED BY: <u>S. BAGNULL</u> DRAWN BY: <u>B. HURRY</u> CHECKED BY: <u>T. MERRITTS</u> APPROVED BY: <u>R. MOHAN</u> SCALE: <u>AS NOTED</u> DATE: <u>NOVEMBER 2019</u>	SHOOTING ISLAND HABITAT RESTORATION AND COASTAL RESILIENCY PROJECT- PHASES 2, 3, AND 4 CITY OF OCEAN CITY, NJ	E-01 SHEET NO. 3 OF 21
				REV	DATE	BY	APP'D	DESCRIPTION																							
EXISTING CONDITIONS AND SHEET LAYOUT PLAN																															




- LEGEND - PLAN:**
-  1978 SHORELINE
 -  1978 TIDAL CREEK
 -  EXISTING CONTOURS,
1 AND 5 FOOT, NAVD88
 -  LIVING SHORELINE SILL CONTOURS
 -  PROPOSED SILL WINDOW CLOSURE
 -  2017 SURVEY SHORELINE (ELEVATION 0, NAVD88)
 -  1970 COASTAL WETLAND BOUNDARY
 -  PROPOSED BACKFILL TO 1.95 FT
- LEGEND - PROFILE:**
-  PROPOSED SILL WINDOW CLOSURE
 -  EXISTING ROCK SILL
 -  TOP OF EXISTING ROCK SILL

SOURCE: BASE LINE WORK PREPARED BY ACT ENGINEERS, INC. BASED ON FIELD SURVEY CONDUCTED ON FEBRUARY 14, 2017 THROUGH MARCH 1, 2017 AND SUPPLEMENTED WITH NEARSHORE TOPOGRAPHY COLLECTED ON JULY 27, 2017. ADDITIONAL TOPOGRAPHIC SURVEY CONDUCTED IN MAY AND AUGUST 2019 BY ACT ENGINEERS, INC.

HORIZONTAL DATUM: NEW JERSEY STATE PLANE, NAD83,
U.S. FEET.

VERTICAL DATUM: VERTICAL DATUM OF 1988 (NAVD88).

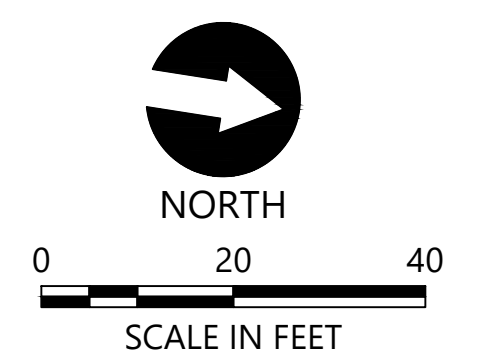

AT FULL SIZE, IF NOT ONE
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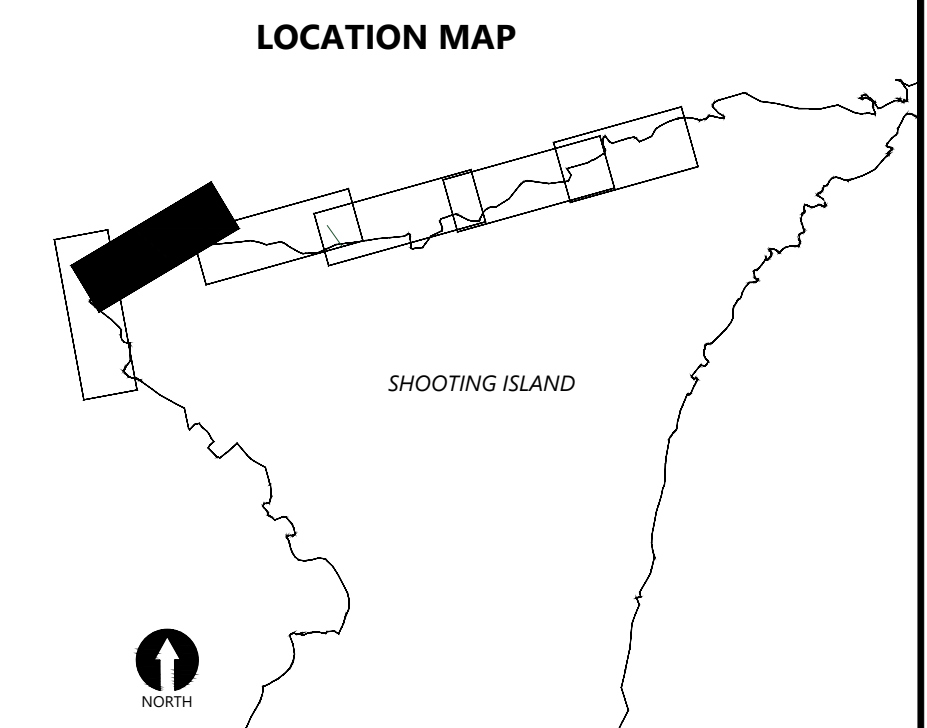
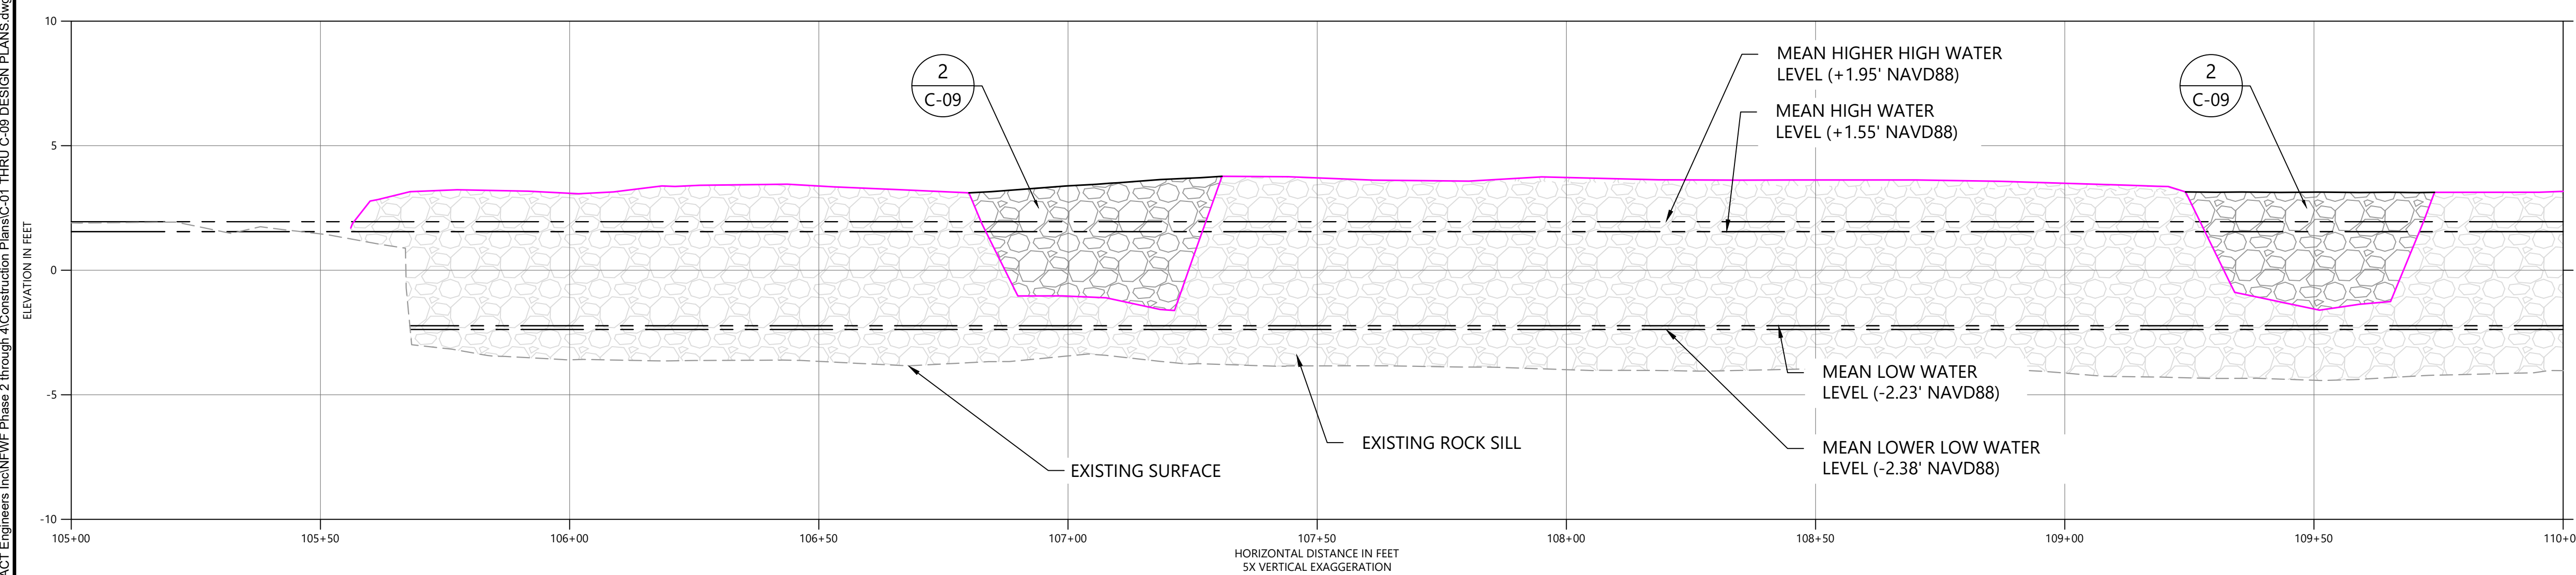
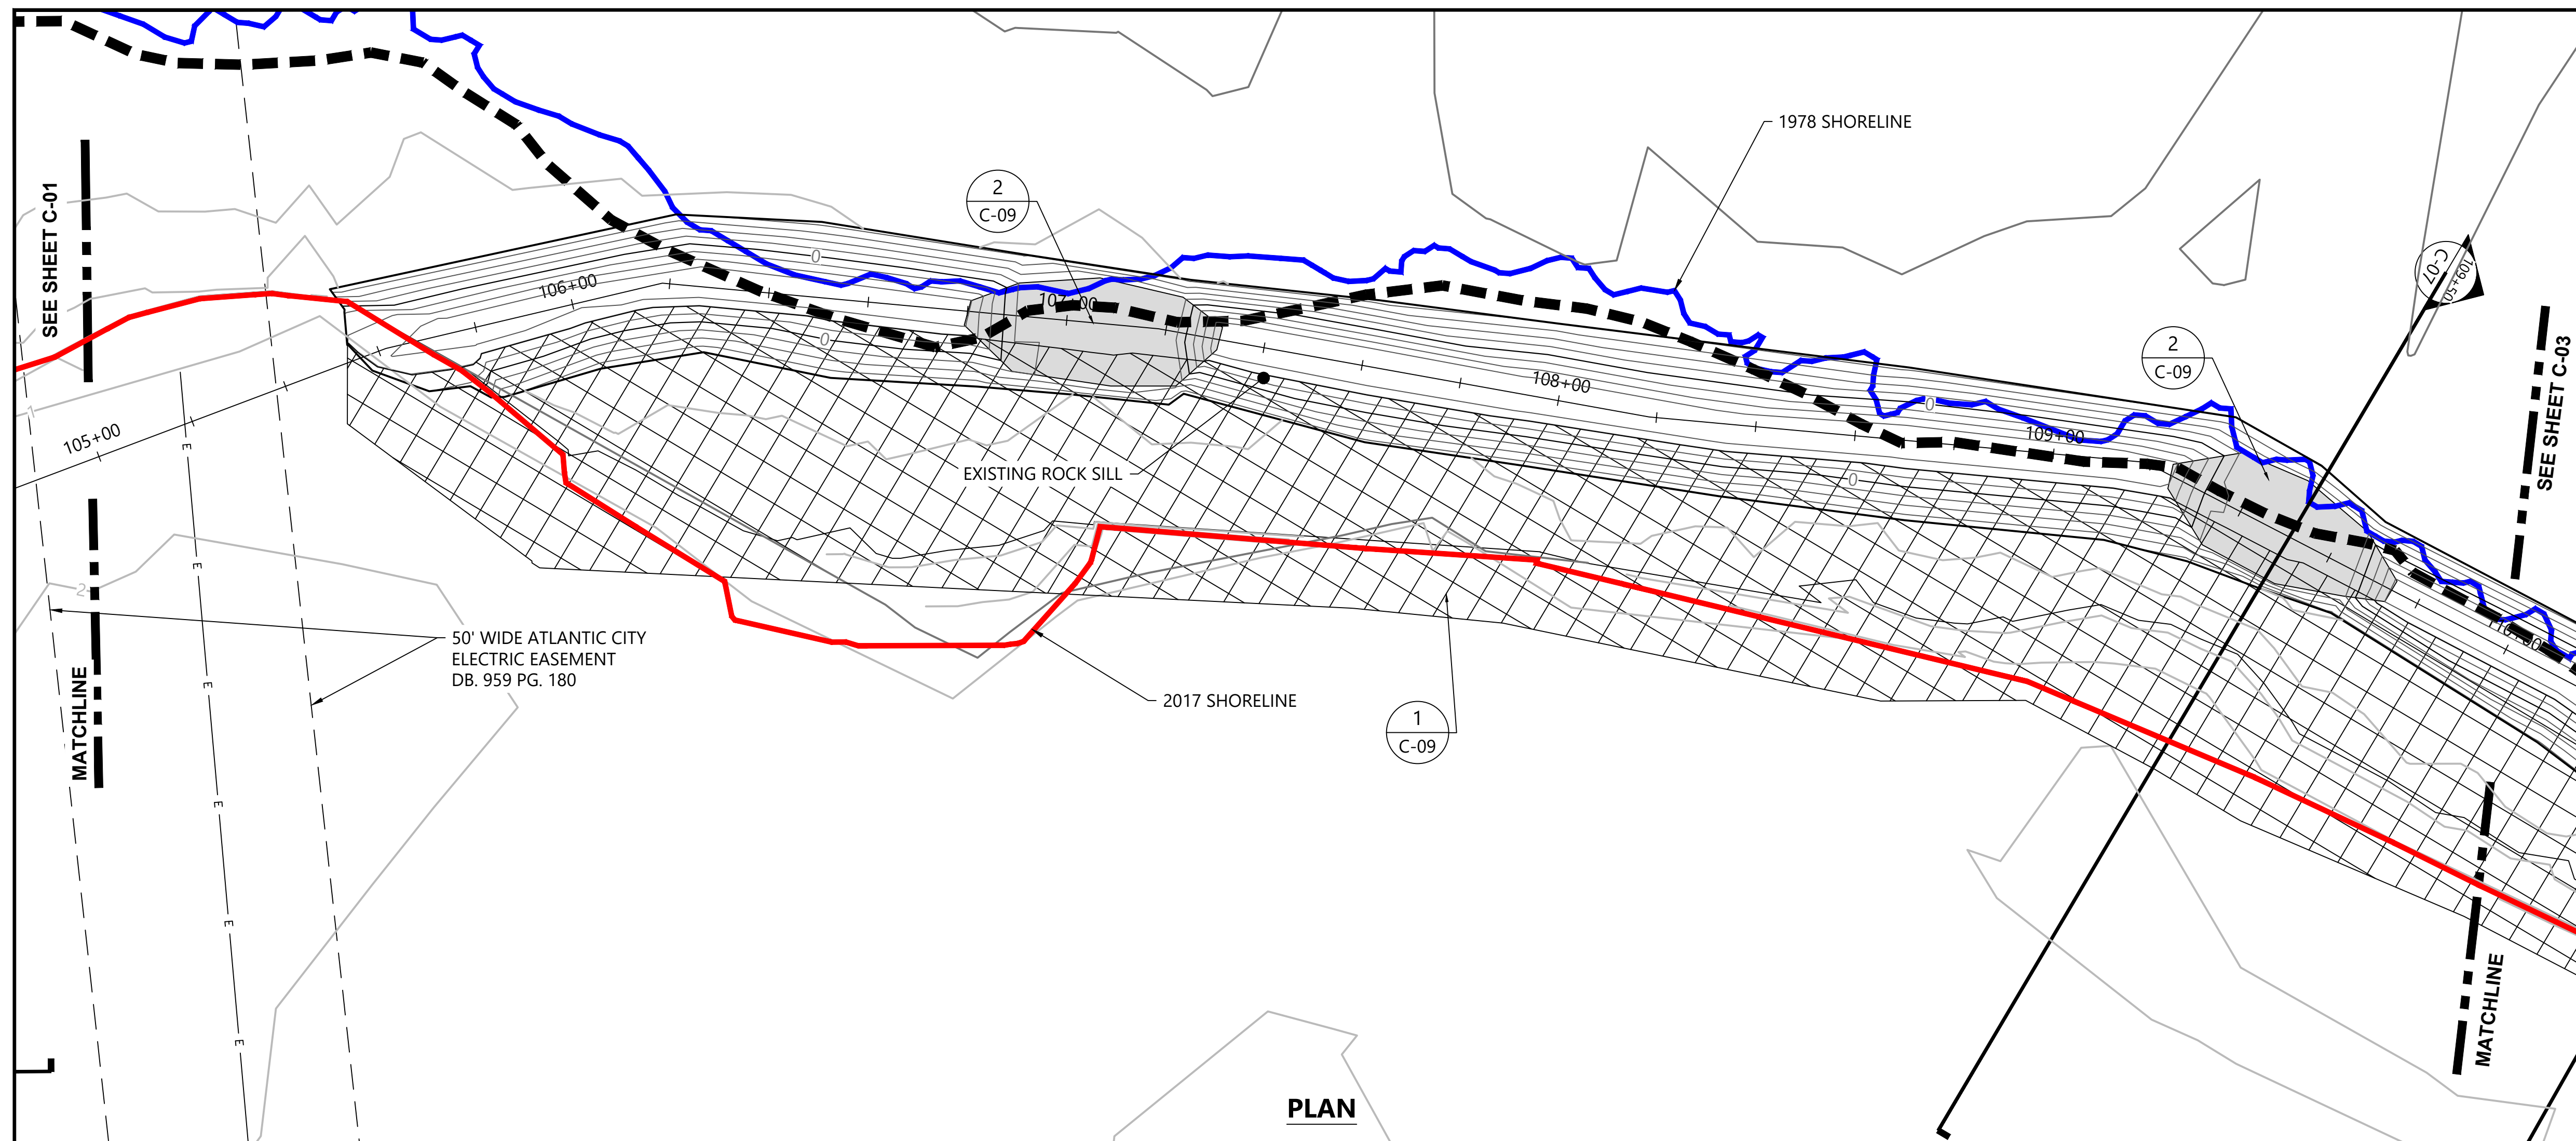
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










**SHOOTING ISLAND HABITAT RESTORATION AND
COASTAL RESILIENCY PROJECT- PHASES 2, 3, AND 4
CITY OF OCEAN CITY, NJ**

PHASE 2 BACKFILL- STA 100+00 TO STA 105+00
PLAN AND PROFILE

C-01

SHEET NO. 4 OF 21




- LEGEND - PLAN:**
-  1978 SHORELINE
 -  1978 TIDAL CREEK
 -  EXISTING CONTOURS,
1 AND 5 FOOT, NAVD88
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- LEGEND - PROFILE:**
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 -  EXISTING ROCK SILL
 -  TOP OF EXISTING ROCK SILL

SOURCE: BASE LINE WORK PREPARED BY ACT ENGINEERS, INC. BASED ON FIELD SURVEY CONDUCTED ON FEBRUARY 14, 2017 THROUGH MARCH 1, 2017 AND SUPPLEMENTED WITH NEARSHORE TOPOGRAPHY COLLECTED ON JULY 27, 2017. ADDITIONAL TOPOGRAPHIC SURVEY CONDUCTED IN MAY AND AUGUST 2019 BY ACT ENGINEERS, INC.

HORIZONTAL DATUM: NEW JERSEY STATE PLANE, NAD83,
U.S. FEET.

VERTICAL DATUM: VERTICAL DATUM OF 1988 (NAVD88).

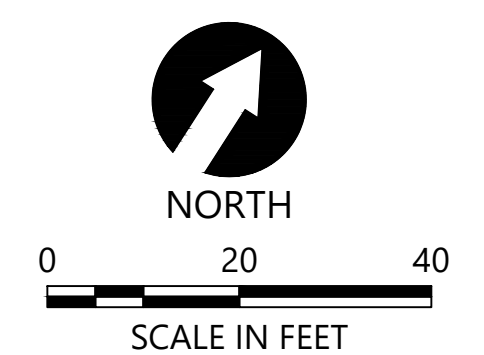

ONE INCH
AT FULL SIZE, IF NOT ONE
INCH SCALE ACCORDINGLY

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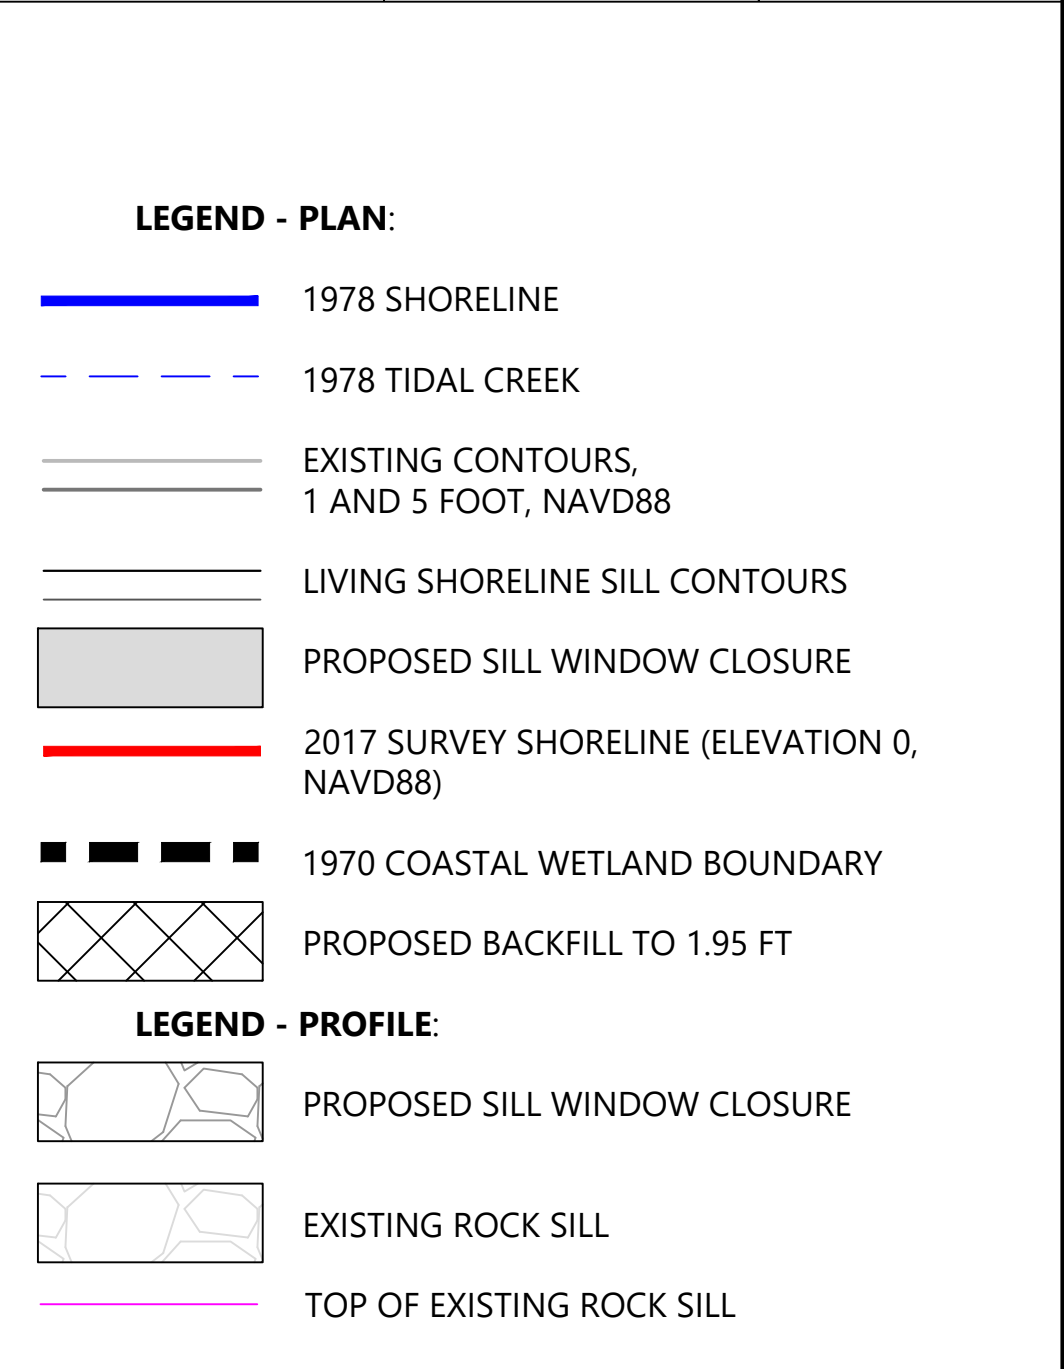
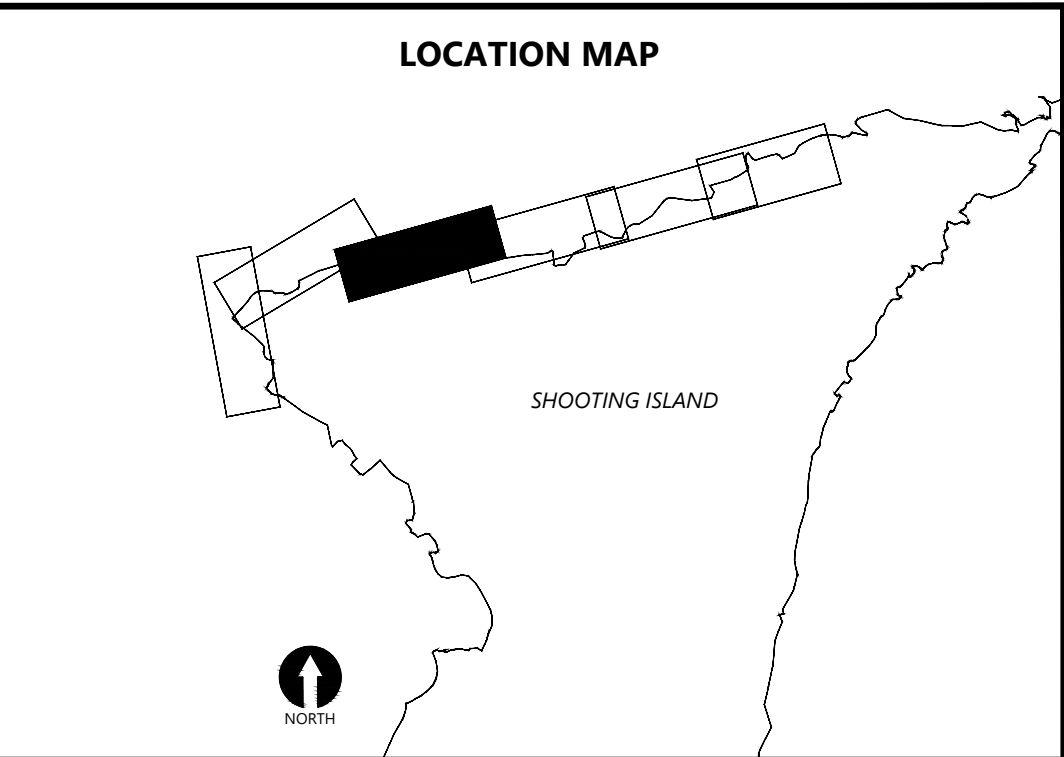
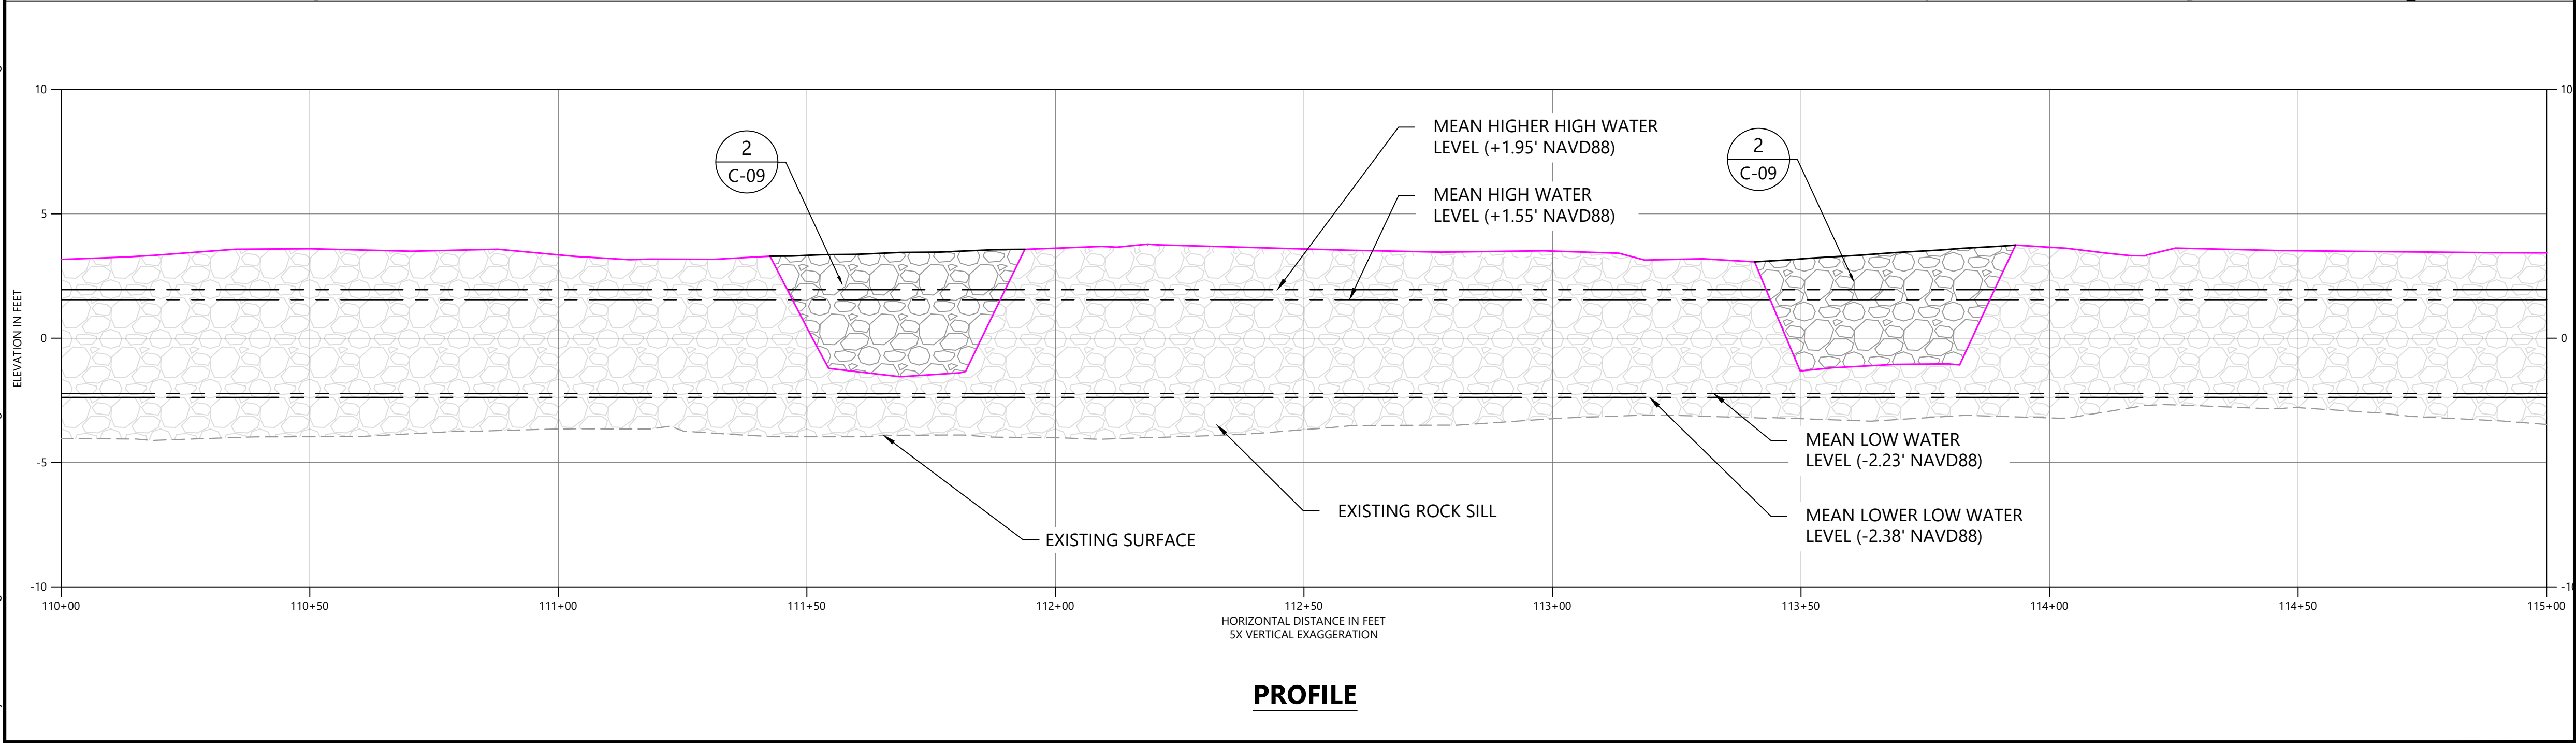
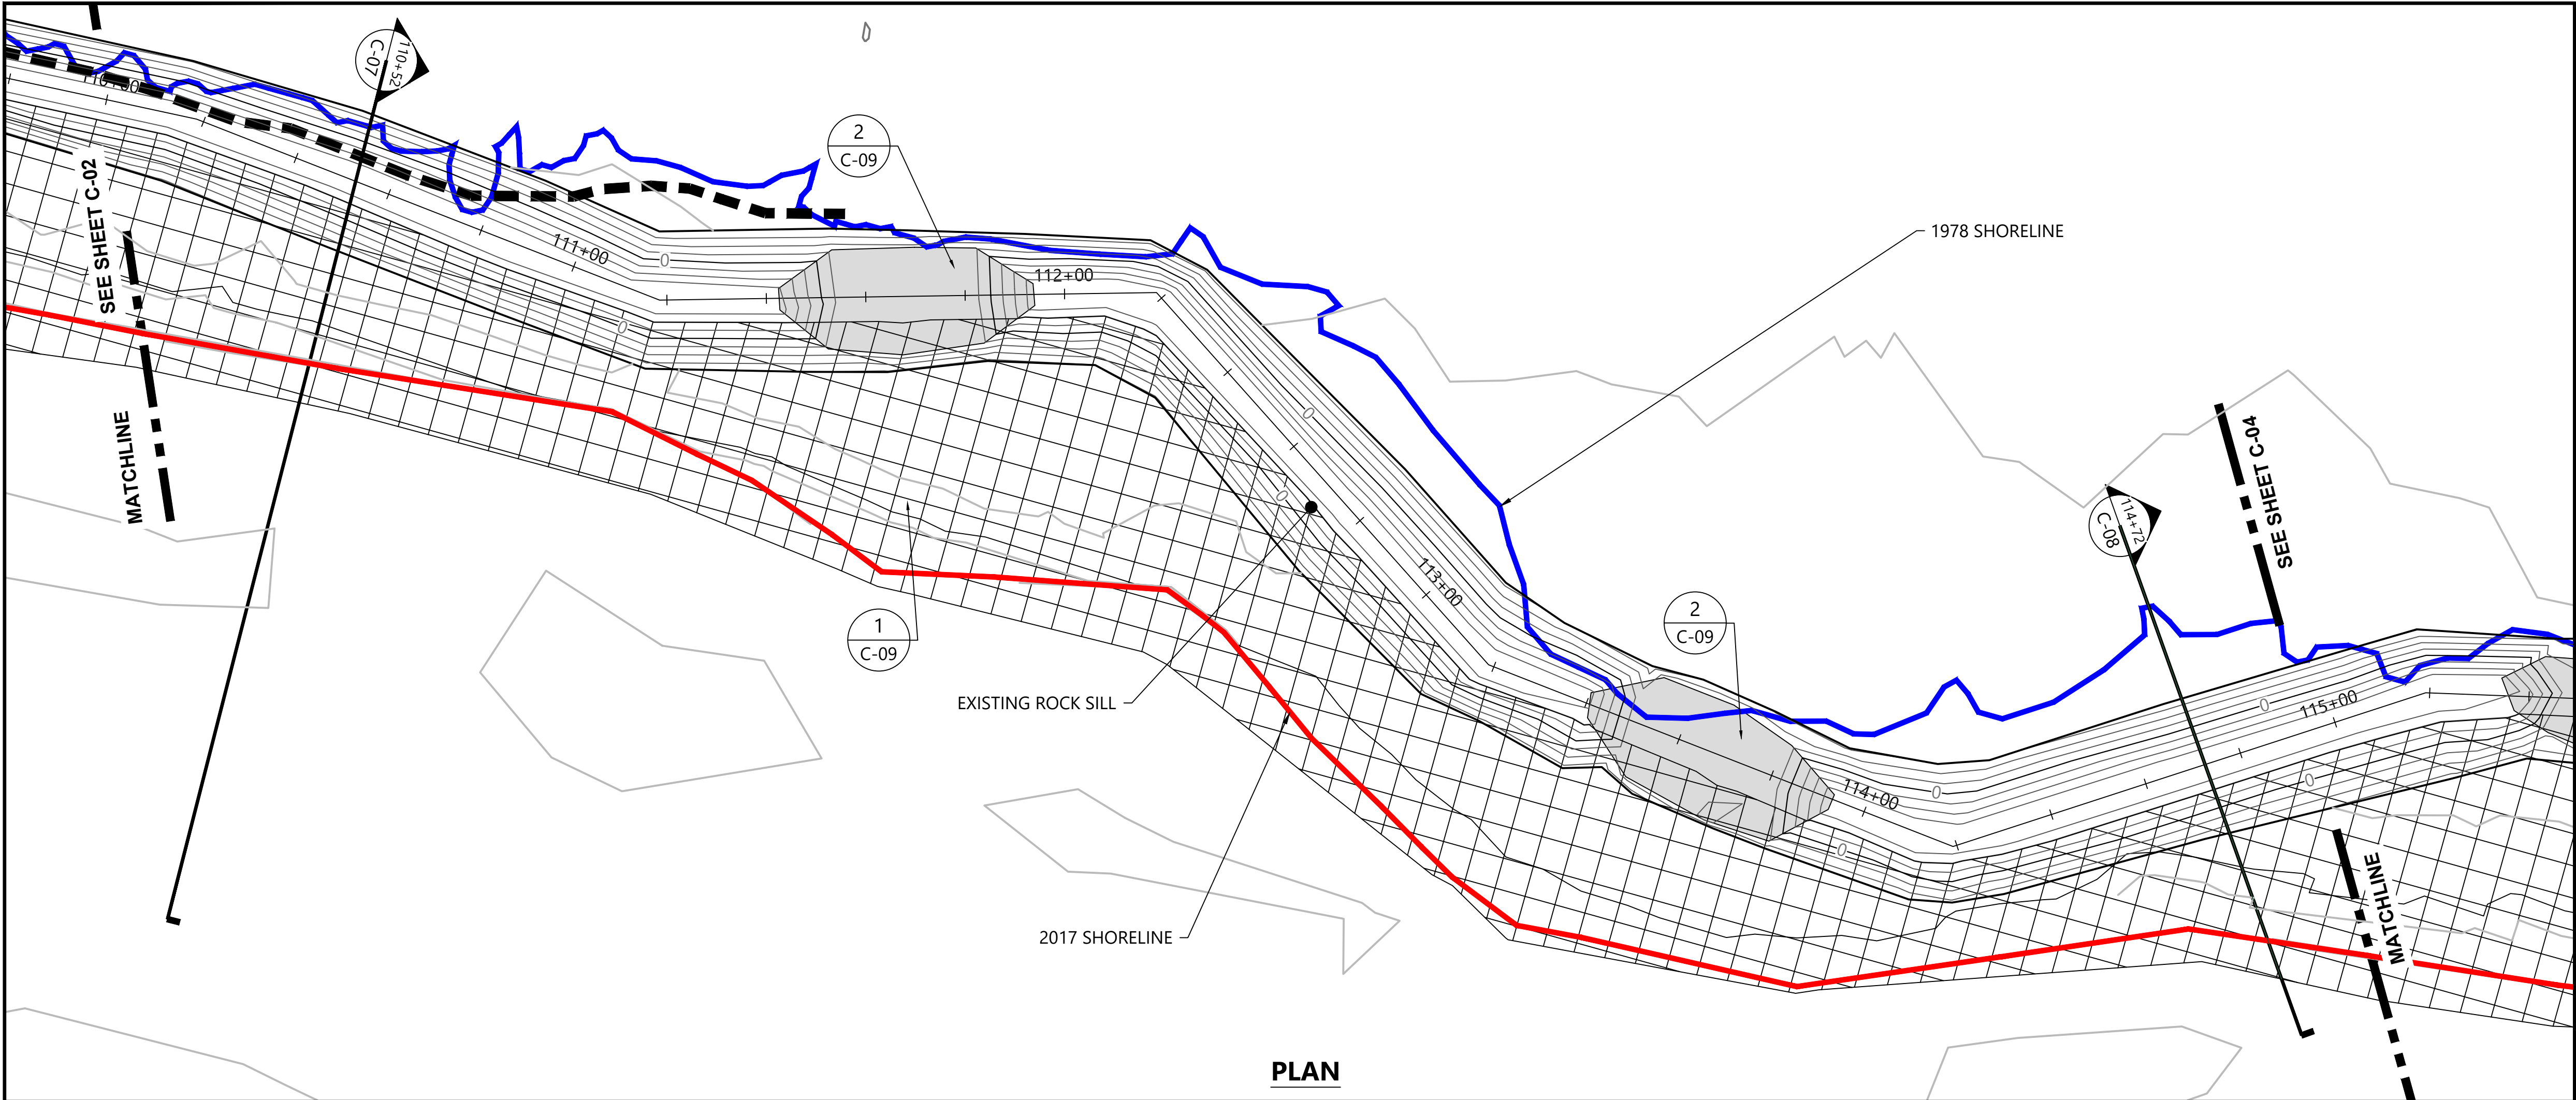
DESIGNED BY: S. BAGNULL
DRAWN BY: B. HURRY
CHECKED BY: T. MERRITTS
APPROVED BY: R. MOHAN
SCALE: AS NOTED
DATE: NOVEMBER 2019

**SHOOTING ISLAND HABITAT RESTORATION AND
COASTAL RESILIENCY PROJECT- PHASES 2, 3, AND 4
CITY OF OCEAN CITY, NJ**

**PHASE 2 BACKFILL- STA. 105+00 TO STA. 110+00
PLAN AND PROFILE**

C-02


SHEET NO. 5 OF 21



SOURCE: BASE LINE WORK PREPARED BY ACT ENGINEERS, INC. BASED ON FIELD SURVEY CONDUCTED ON FEBRUARY 14, 2017 THROUGH MARCH 1, 2017 AND SUPPLEMENTED WITH NEARSHORE TOPOGRAPHY COLLECTED ON JULY 27, 2017. ADDITIONAL TOPOGRAPHIC SURVEY CONDUCTED IN MAY AND AUGUST 2019 BY ACT ENGINEERS, INC.

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REVISIONS				
REV	DATE	BY	APP'D	DESCRIPTION

DESIGNED BY: S. BAGNULL
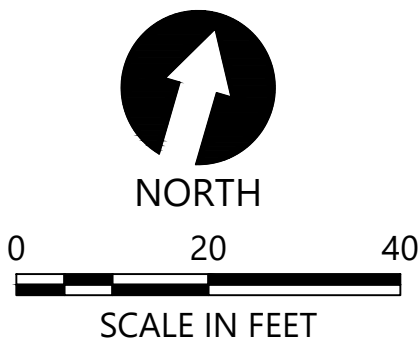
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APPROVED BY: R. MOHAN

SCALE: AS NOTED

DATE: NOVEMBER 2019

SHOOTING ISLAND HABITAT RESTORATION AND COASTAL RESILIENCY PROJECT- PHASES 2, 3, AND 4



CITY OF OCEAN CITY, NJ

PHASE 2 BACKFILL- STA. 110+00 TO STA. 115+00 PLAN AND PROFILE


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SHEET NO. 6 OF 21

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LOCATION MAP

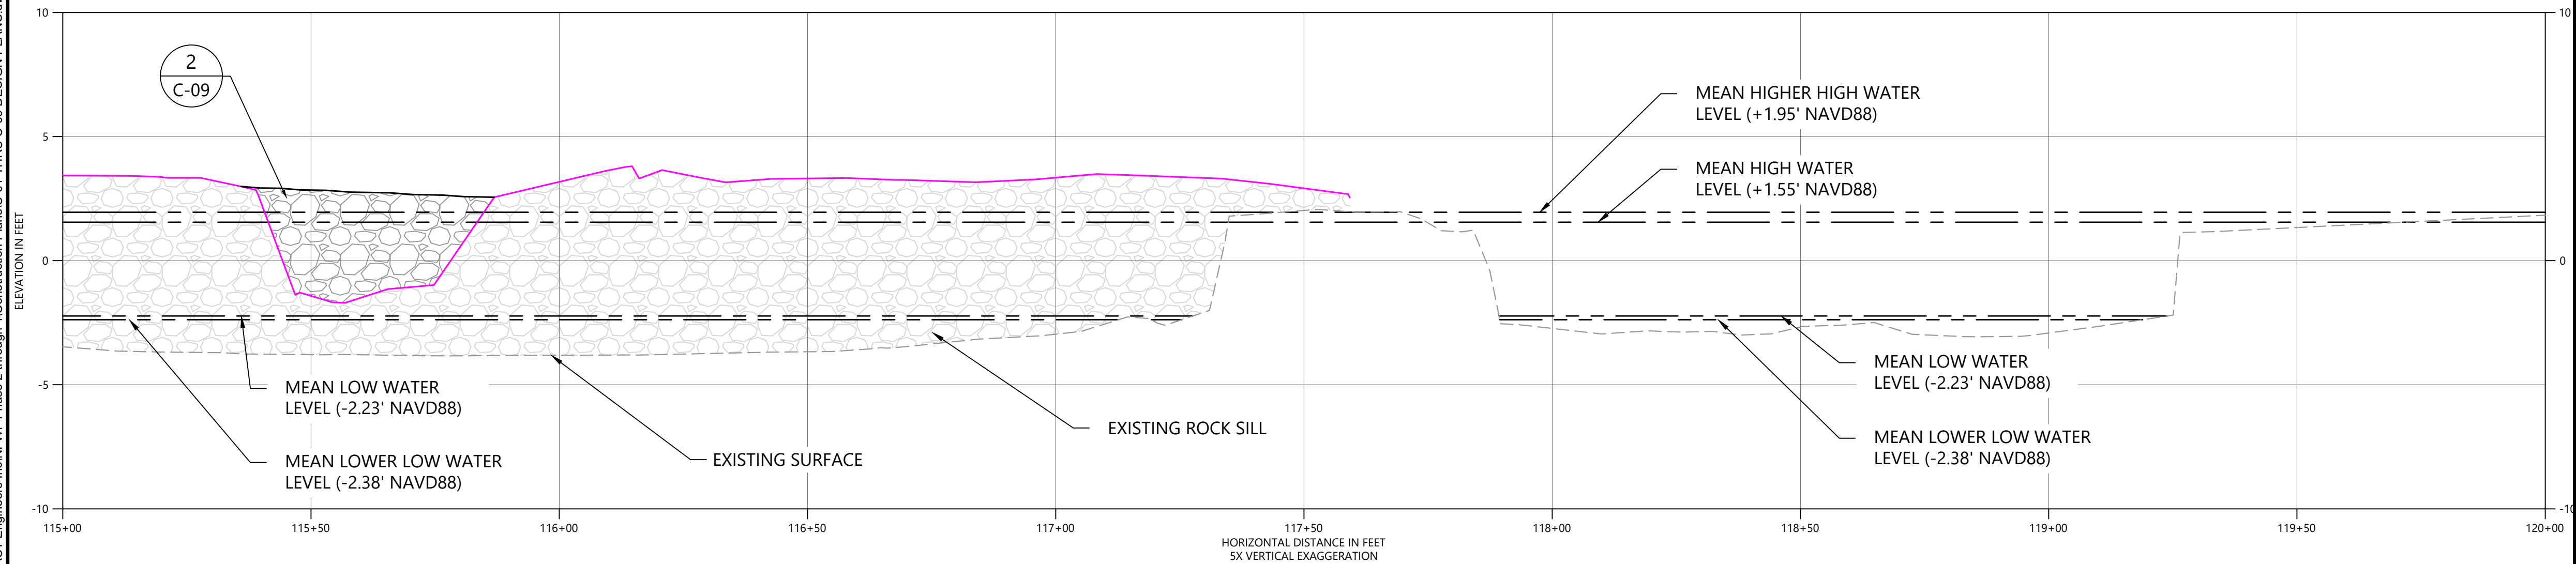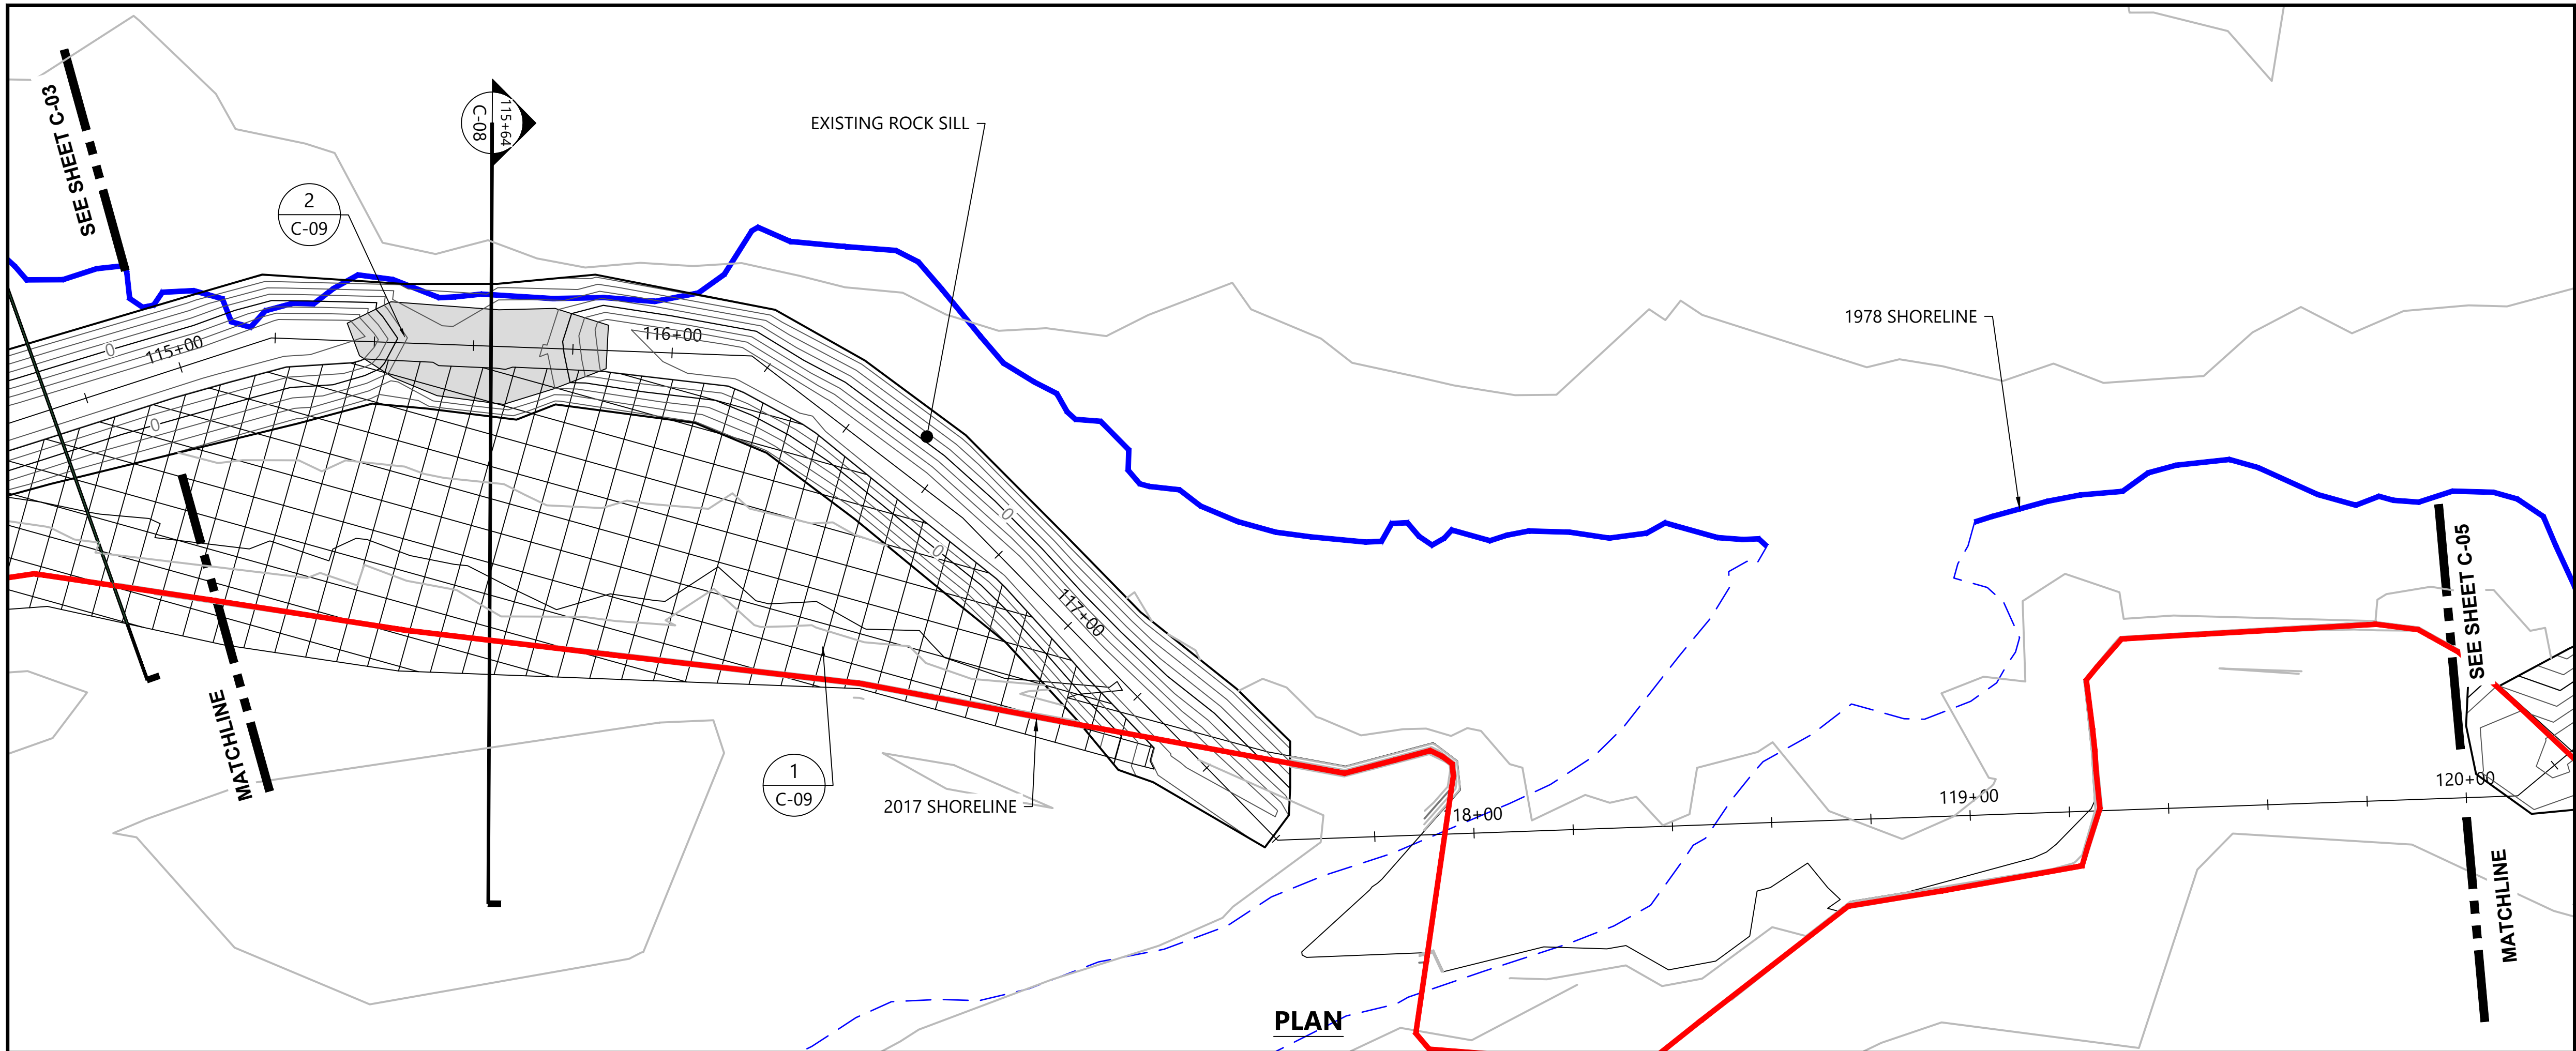

LEGEND - PLAN:

- 1978 SHORELINE
- 1978 TIDAL CREEK
- EXISTING CONTOURS, 1 AND 5 FOOT, NAVD88
- LIVING SHORELINE SILL CONTOURS
- PROPOSED SILL WINDOW CLOSURE
- 2017 SURVEY SHORELINE (ELEVATION 0, NAVD88)
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- PROPOSED BACKFILL TO 1.95 FT

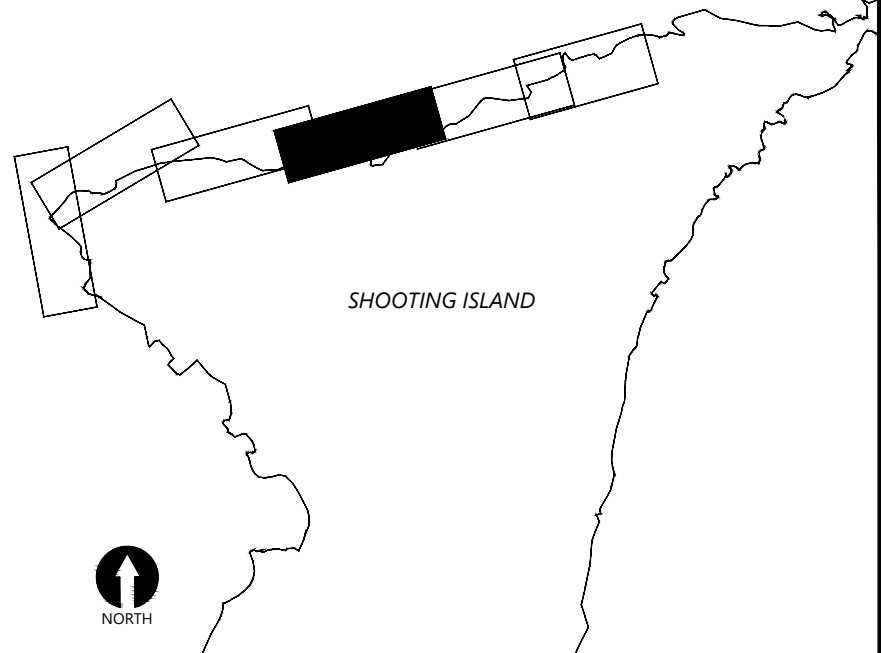
LEGEND - PROFILE:

- PROPOSED SILL WINDOW CLOSURE
- EXISTING ROCK SILL
- TOP OF EXISTING ROCK SILL

SOURCE: BASE LINE WORK PREPARED BY ACT ENGINEERS, INC. BASED ON FIELD SURVEY CONDUCTED ON FEBRUARY 14, 2017 THROUGH MARCH 1, 2017 AND SUPPLEMENTED WITH NEARSHORE TOPOGRAPHY COLLECTED ON JULY 27, 2017. ADDITIONAL TOPOGRAPHIC SURVEY CONDUCTED IN MAY AND AUGUST 2019 BY ACT ENGINEERS, INC.

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VERTICAL DATUM: VERTICAL DATUM OF 1988 (NAVD88).

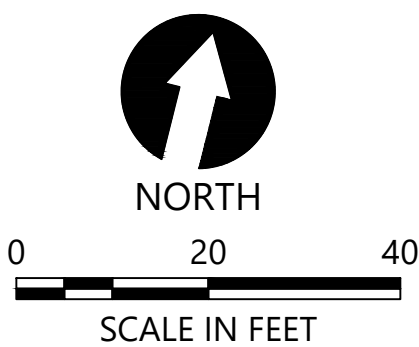

ONE INCH
= 40 FEET
AT FULL SIZE, IF NOT ONE
INCH SCALE ACCORDINGLY



REVISIONS					DESCRIPTION
REV	DATE	BY	APP'D		



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SHOOTING ISLAND HABITAT RESTORATION AND
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CITY OF OCEAN CITY, NJ




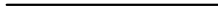




PHASE 2 BACKFILL- STA. 115+00 TO STA.
120+00 PLAN AND PROFILE

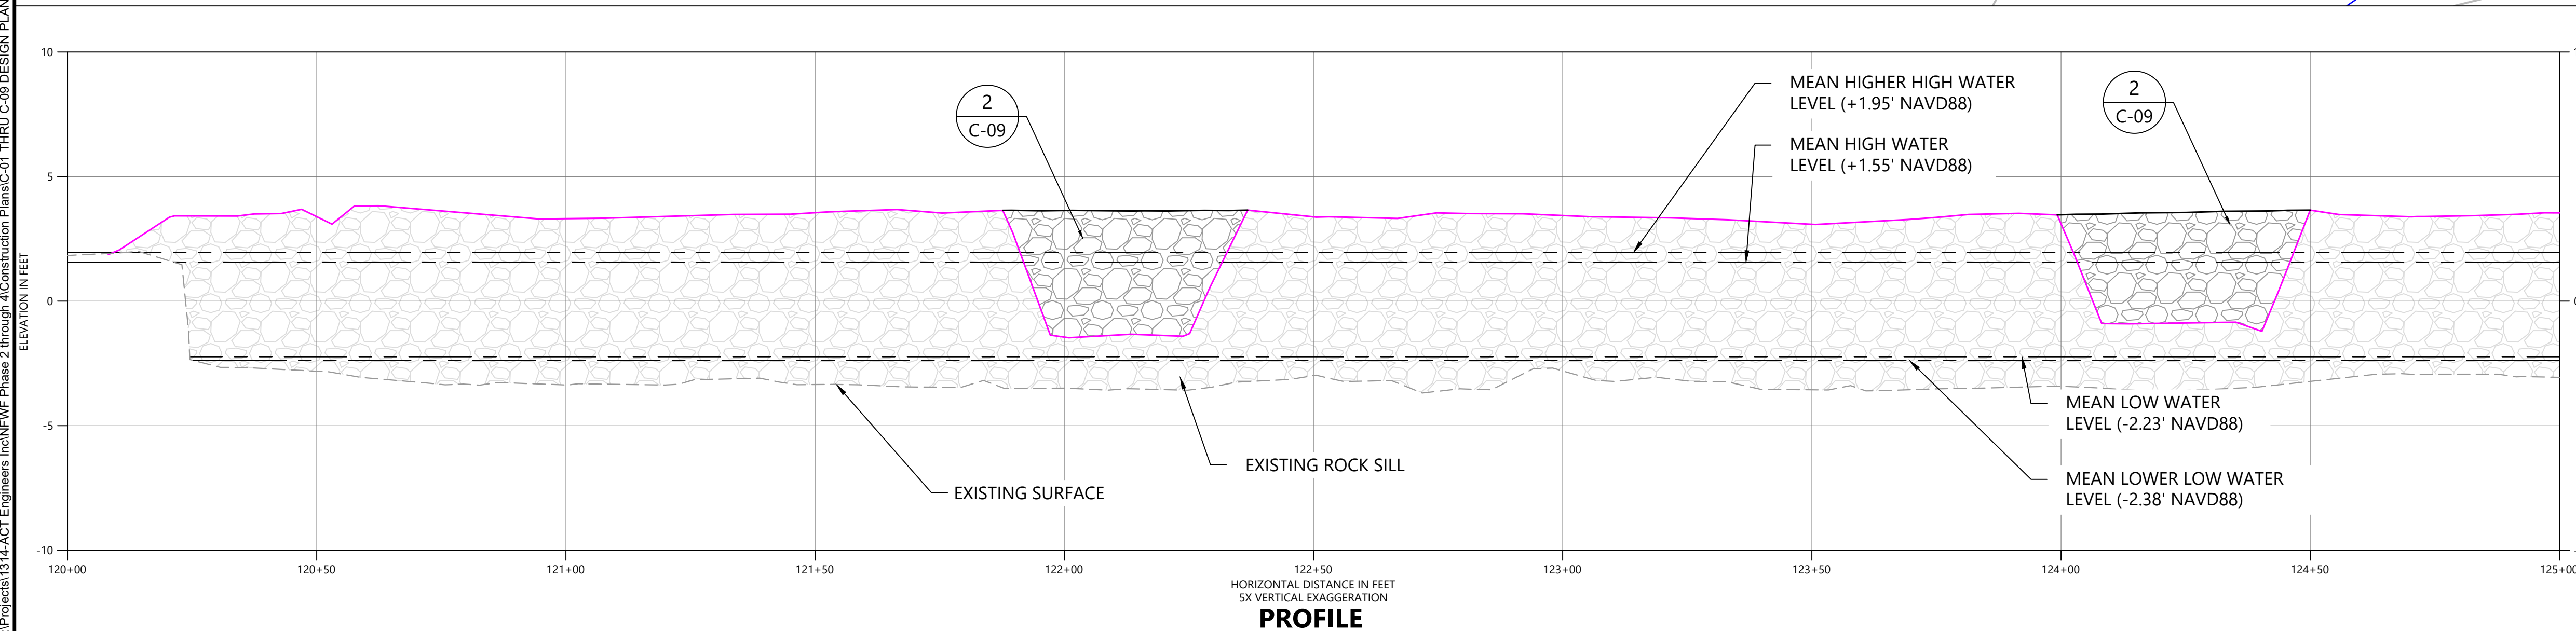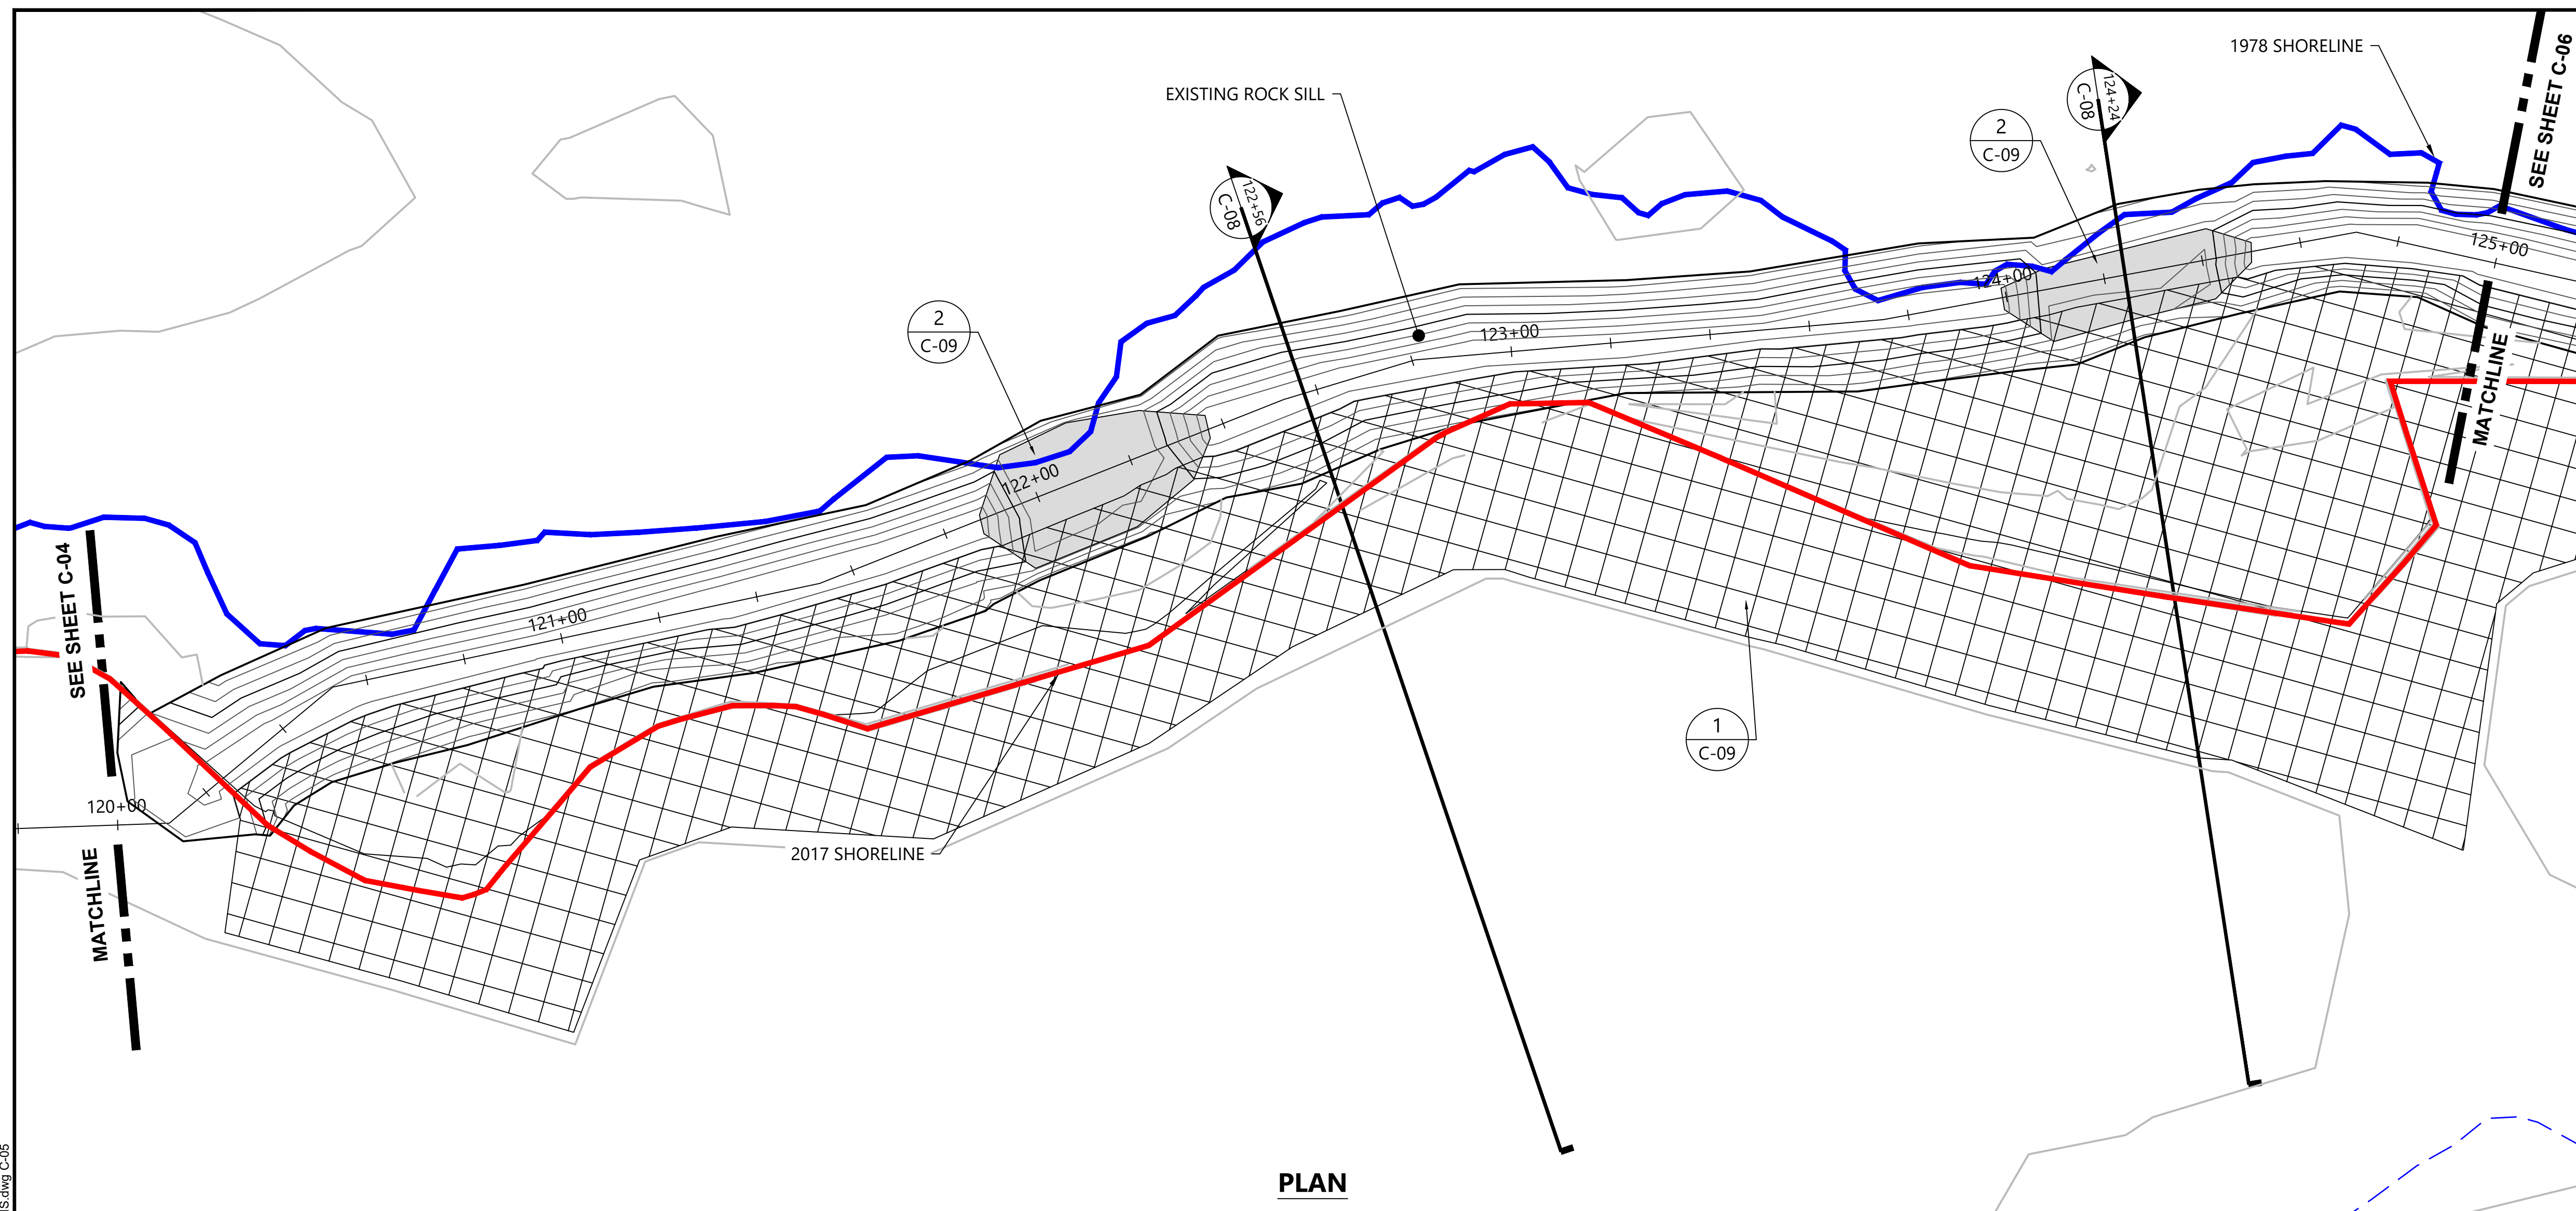C-04

SHEET NO. 7 OF 21




- LEGEND - PLAN:**

- | | |
|---|--|
|  | 1978 SHORELINE |
|  | 1978 TIDAL CREEK |
|  | EXISTING CONTOURS,
1 AND 5 FOOT, NAVD88 |
|  | LIVING SHORELINE SILL CONTOURS |
|  | PROPOSED SILL WINDOW CLOSURE |
|  | 2017 SURVEY SHORELINE (ELEVATION 0,
NAVD88) |
|  | 1970 COASTAL WETLAND BOUNDARY |
|  | PROPOSED BACKFILL TO 1.95 FT |

SOURCE: BASE LINE WORK PREPARED BY ACT ENGINEERS, INC. BASED ON FIELD SURVEY CONDUCTED ON FEBRUARY 14, 2017 THROUGH MARCH 1, 2017 AND SUPPLEMENTED WITH NEARSHORE TOPOGRAPHY COLLECTED ON JULY 27, 2017. ADDITIONAL TOPOGRAPHIC SURVEY CONDUCTED IN MAY AND AUGUST 2019 BY ACT ENGINEERS, INC.

HORIZONTAL DATUM: NEW JERSEY STATE PLANE, NAD83,
U.S. FEET.

VERTICAL DATUM: VERTICAL DATUM OF 1988 (NAVD88).

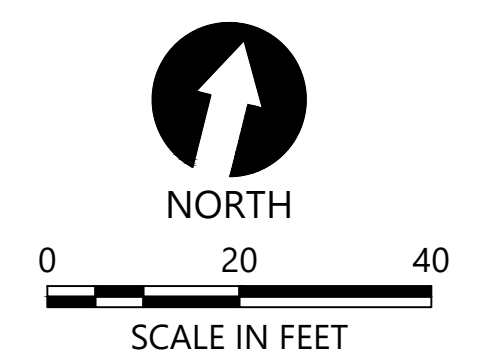

ONE INCH
AT FULL SIZE, IF NOT ONE
INCH SCALE ACCORDINGLY

[illegible]

DESIGNED BY: S. BAGNULL
DRAWN BY: B. HURRY
CHECKED BY: T. MERRITTS
APPROVED BY: R. MOHAN
SCALE: AS NOTED
DATE: NOVEMBER 2019

**SHOOTING ISLAND HABITAT RESTORATION AND
COASTAL RESILIENCY PROJECT- PHASES 2, 3, AND 4
CITY OF OCEAN CITY, NJ**





PHASE 2 BACKFILL- STA. 120+00 TO 125+00
PLAN AND PROFILE

C-05

SHEET NO. 8 OF 21

Nov 17, 2019 12:47 pm bhurry K:\Projects\1314-ACT Engineers Inc\NFWF Phase 2 through 4\Construction Plans\C-01 THRU C-09 DESIGN PLANS.dwg C-05

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Nov 17, 2019 12:47pm bhurry

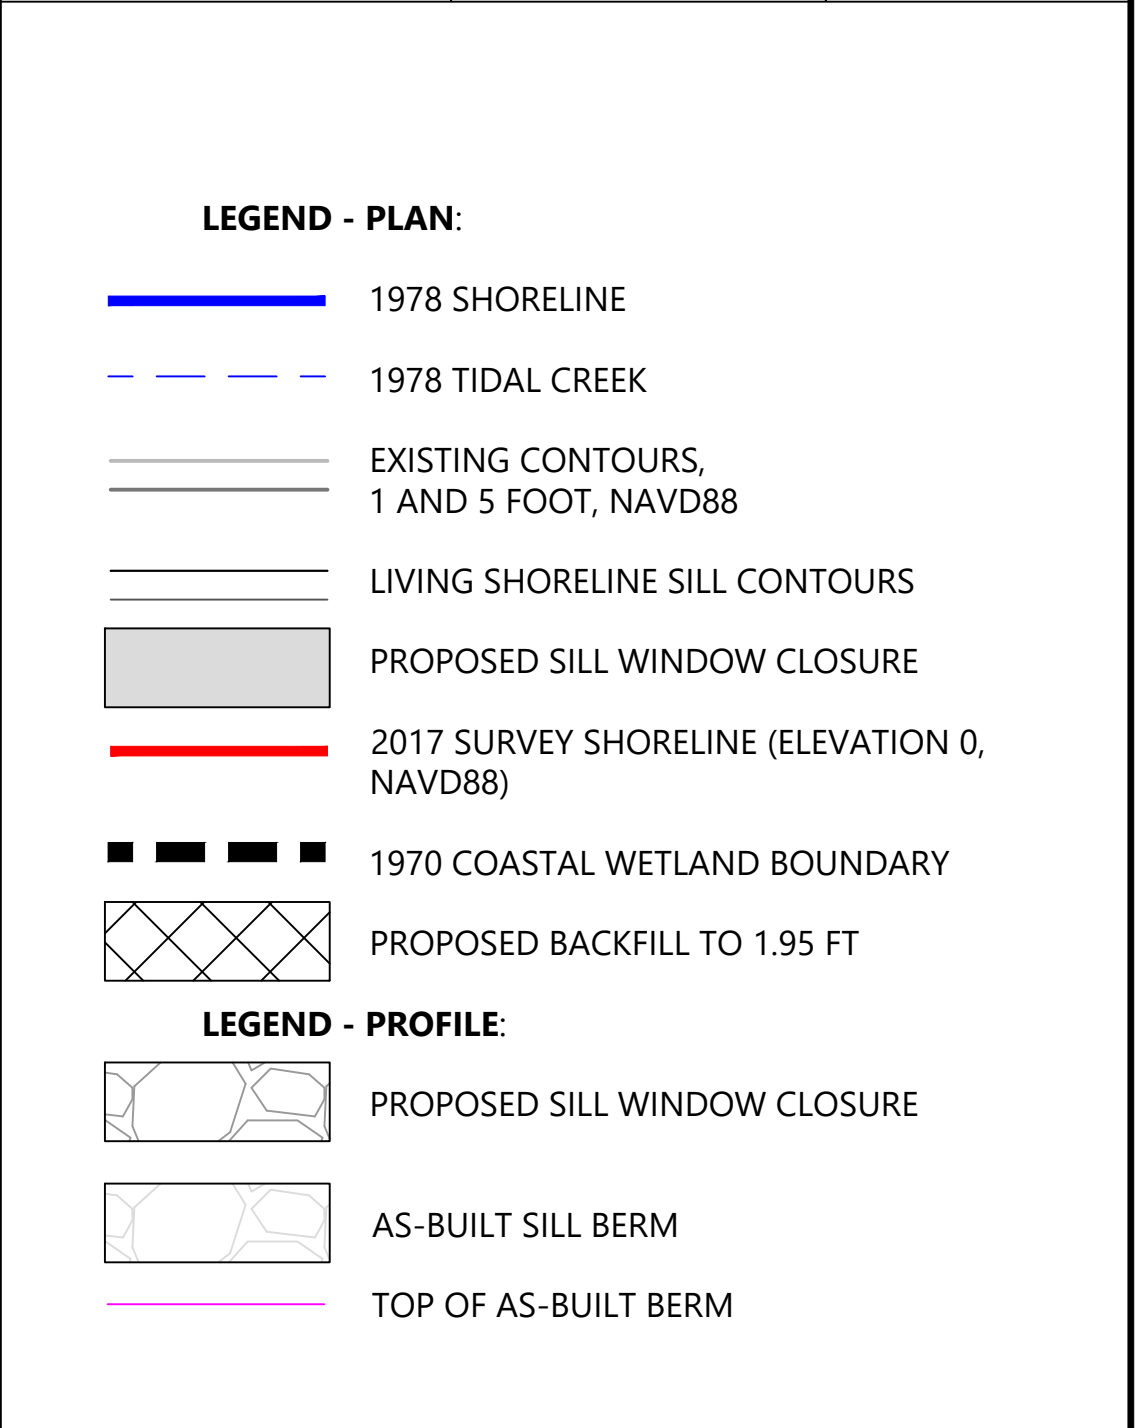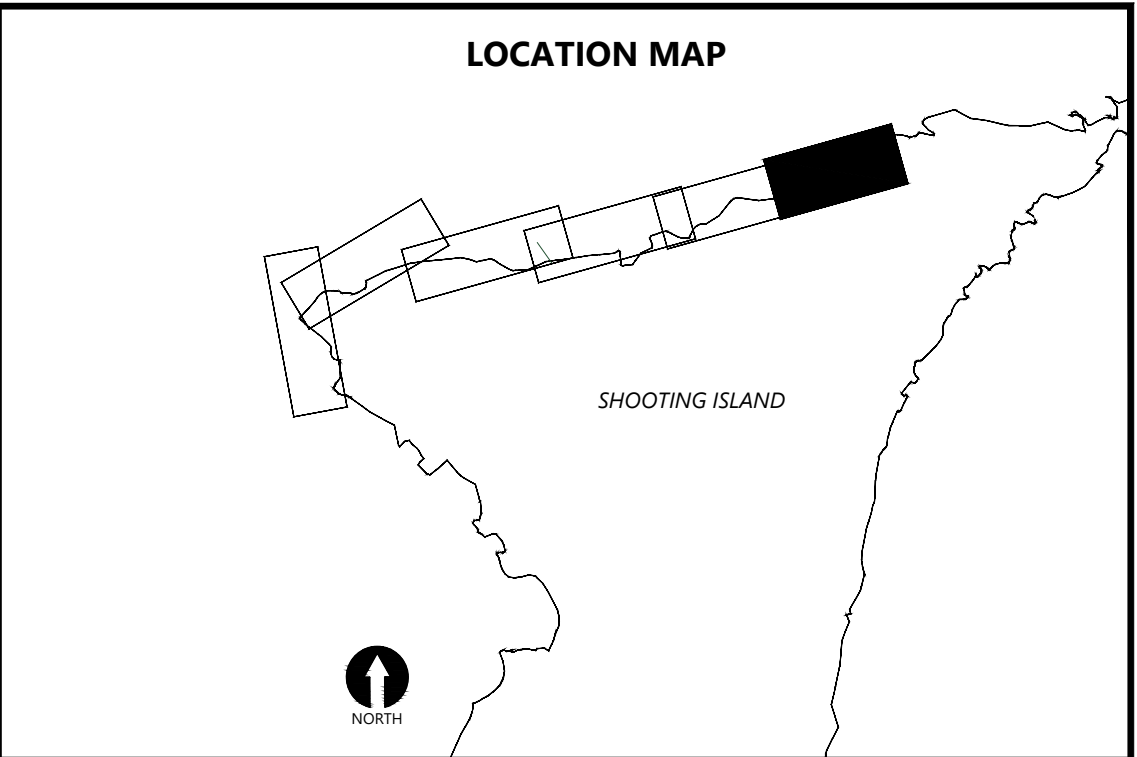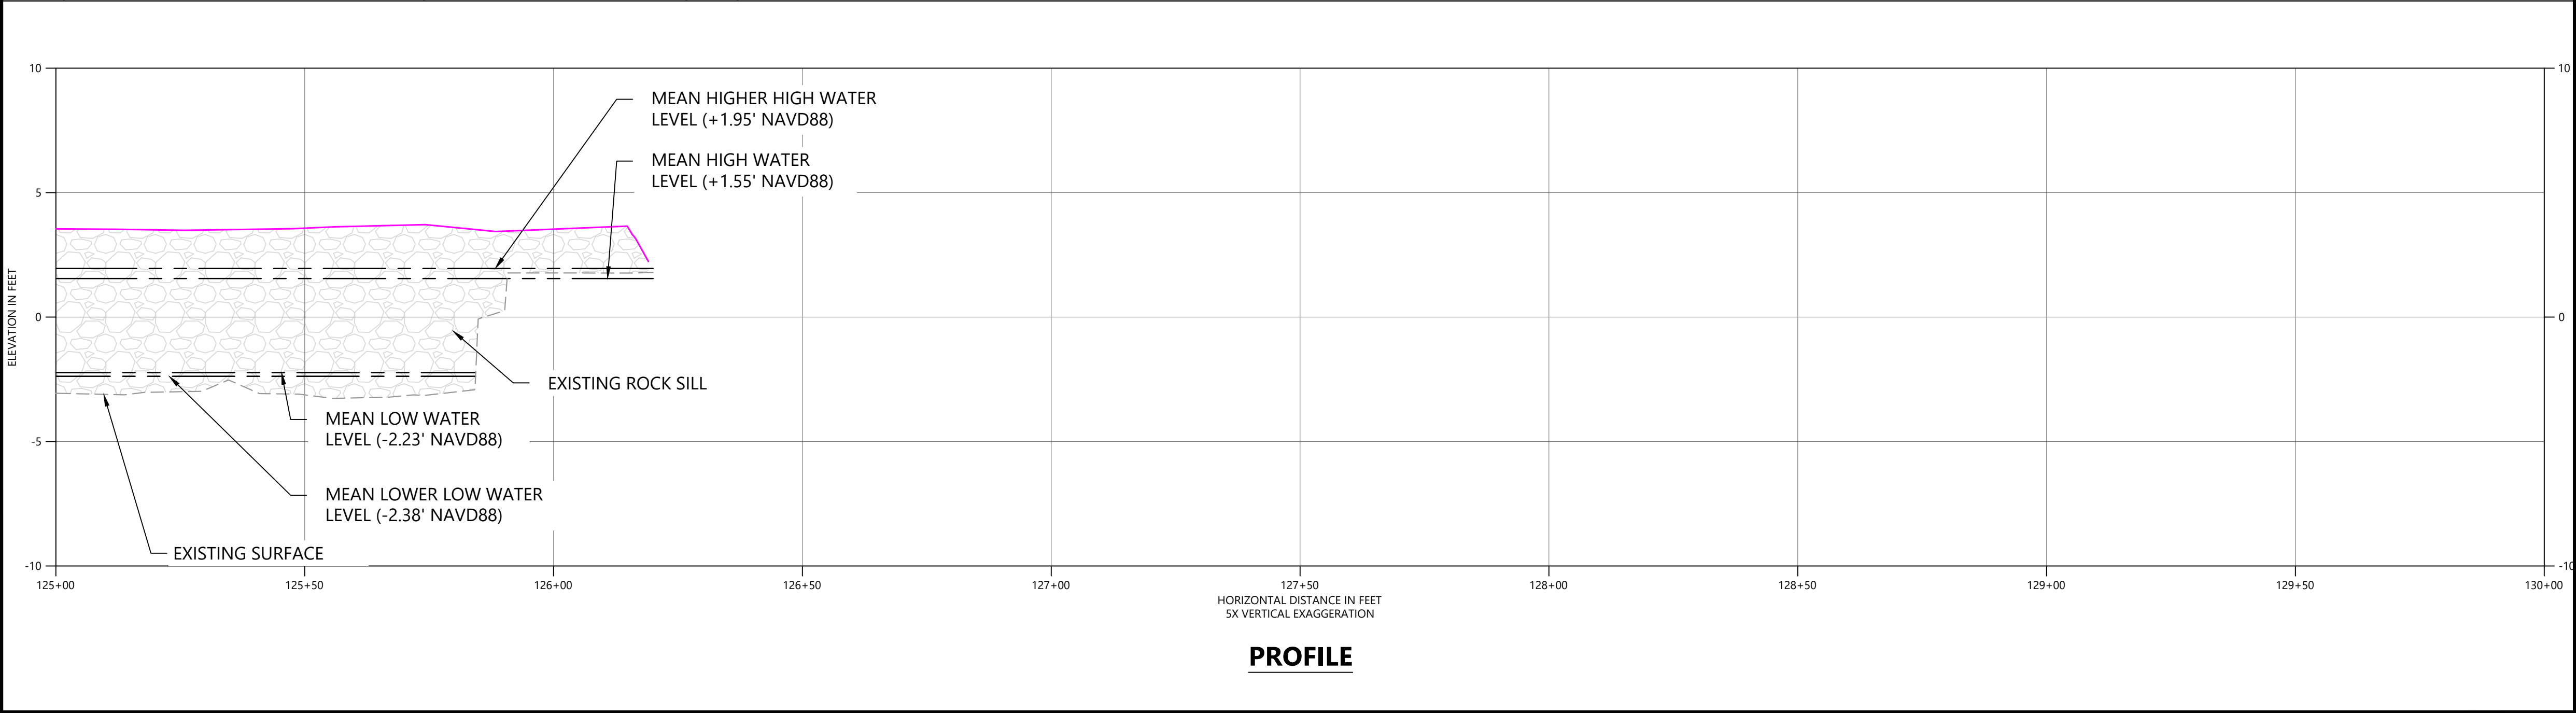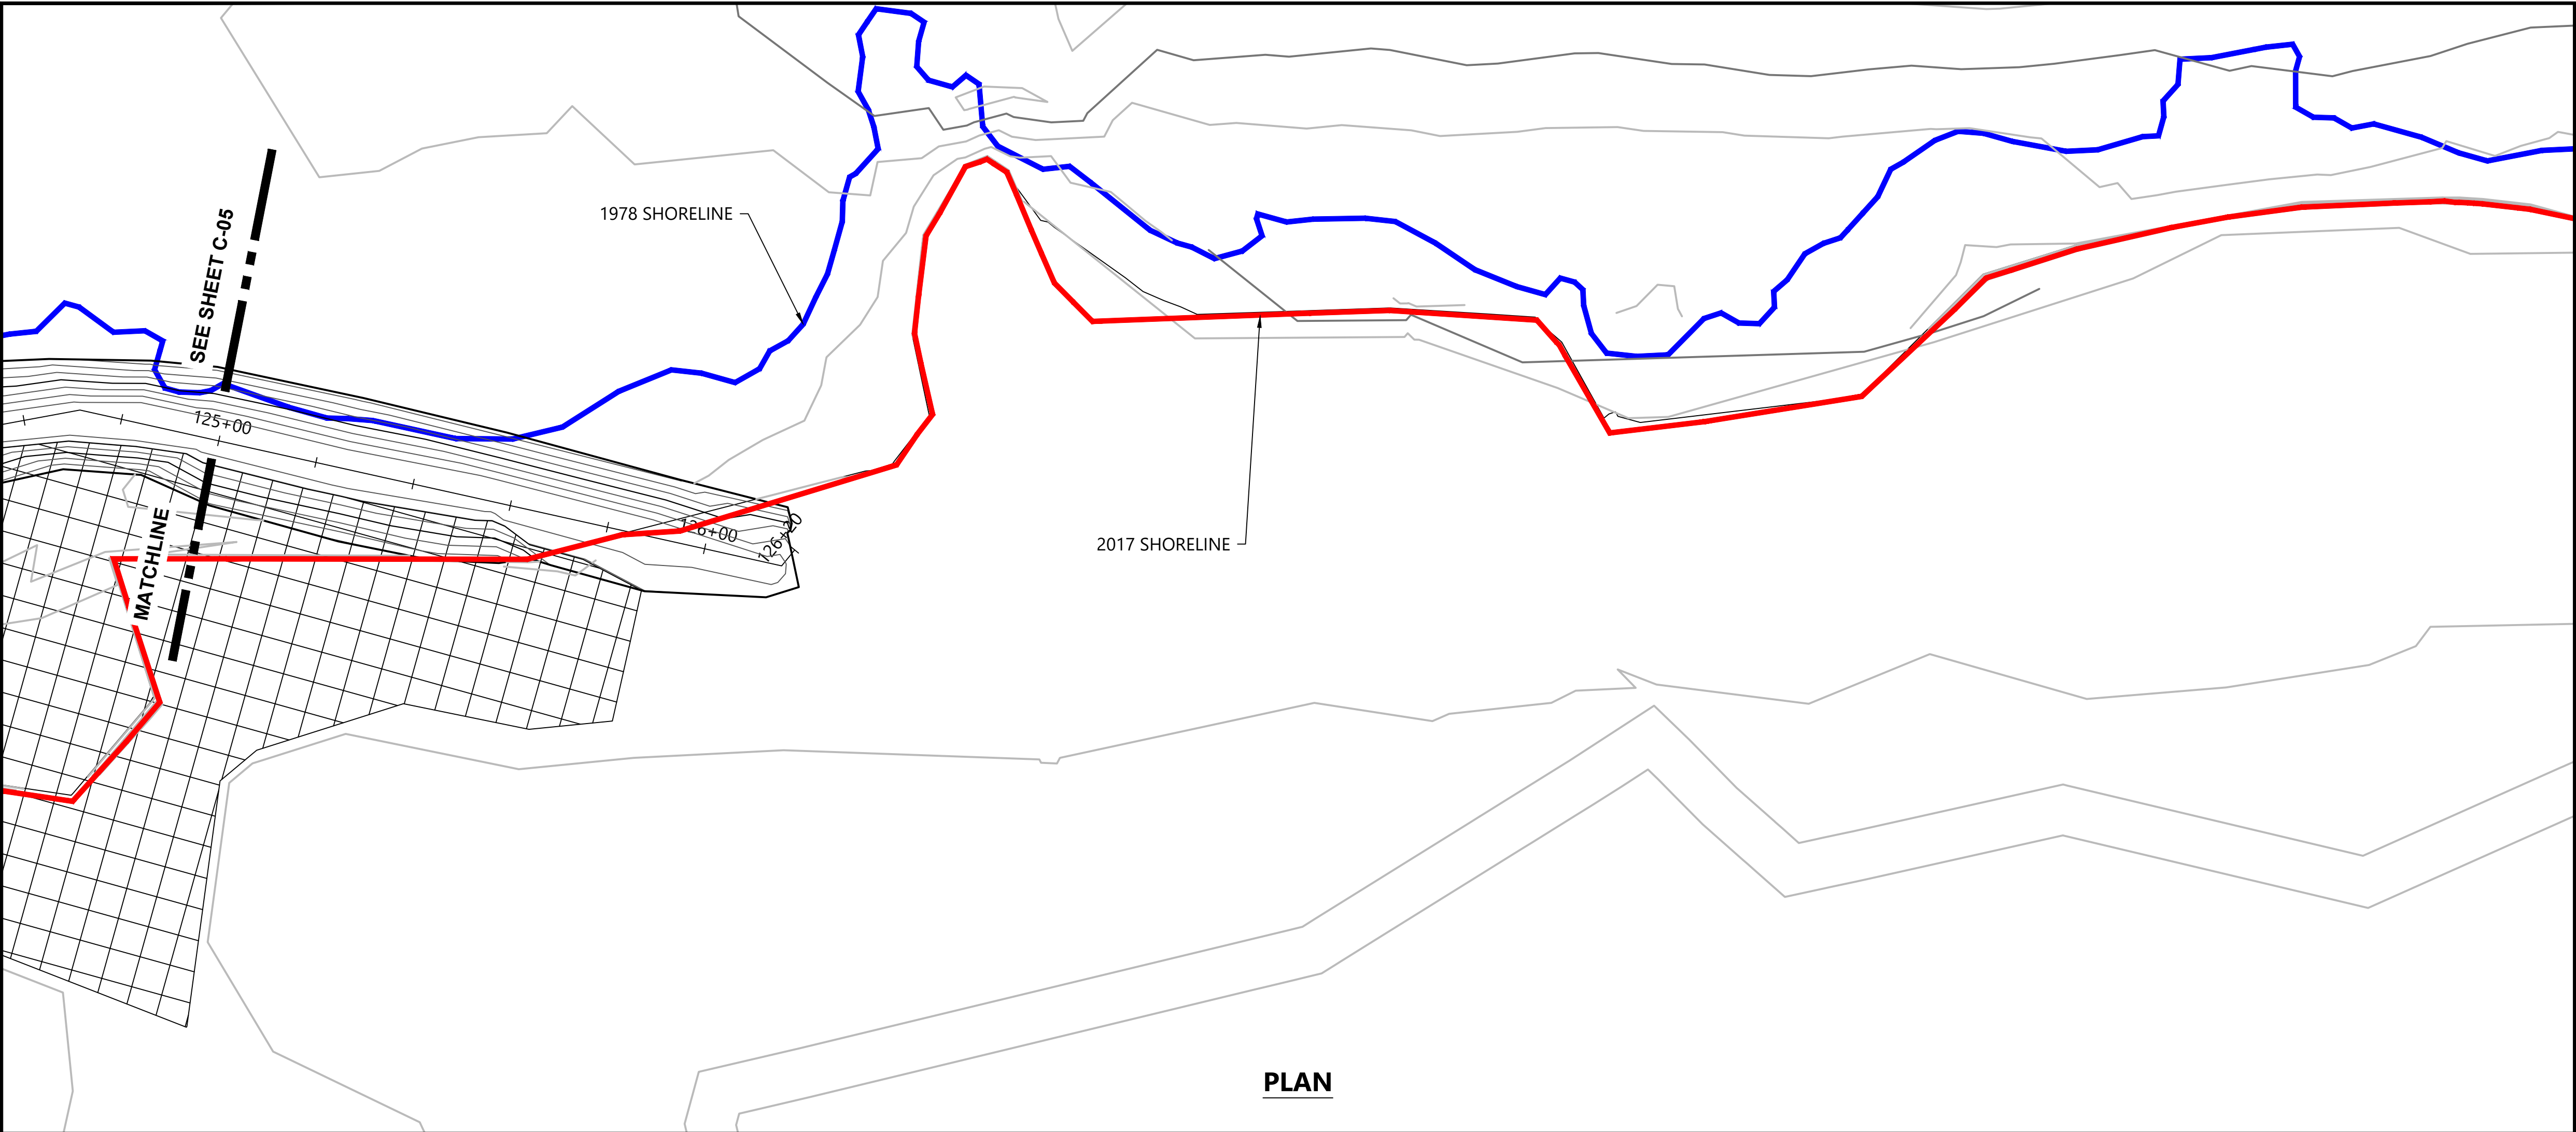

SOURCE: BASE LINE WORK PREPARED BY ACT ENGINEERS, INC. BASED ON FIELD SURVEY CONDUCTED ON FEBRUARY 14, 2017 THROUGH MARCH 1, 2017 AND SUPPLEMENTED WITH NEARSHORE TOPOGRAPHY COLLECTED ON JULY 27, 2017. ADDITIONAL TOPOGRAPHIC SURVEY CONDUCTED IN MAY AND AUGUST 2019 BY ACT ENGINEERS, INC.

HORIZONTAL DATUM: NEW JERSEY STATE PLANE, NAD83, U.S. FEET.

VERTICAL DATUM: VERTICAL DATUM OF 1988 (NAVD88).





NORTH

0 20 40

SCALE IN FEET

ONE INCH
AT FULL SIZE, IF NOT ONE
INCH SCALE ACCORDINGLY

			REVISIONS					DESIGNED BY: S. BAGNULL DRAWN BY: B. HURRY CHECKED BY: T. MERRITTS APPROVED BY: R. MOHAN SCALE: AS NOTED DATE: NOVEMBER 2019	SHOOTING ISLAND HABITAT RESTORATION AND COASTAL RESILIENCY PROJECT- PHASES 2, 3, AND 4 CITY OF OCEAN CITY, NJ	C-06
			REV	DATE	BY	APP'D	DESCRIPTION			
									PHASE 2 BACKFILL- STA. 125+00 TO END PLAN AND PROFILE	SHEET NO. 9 OF 21

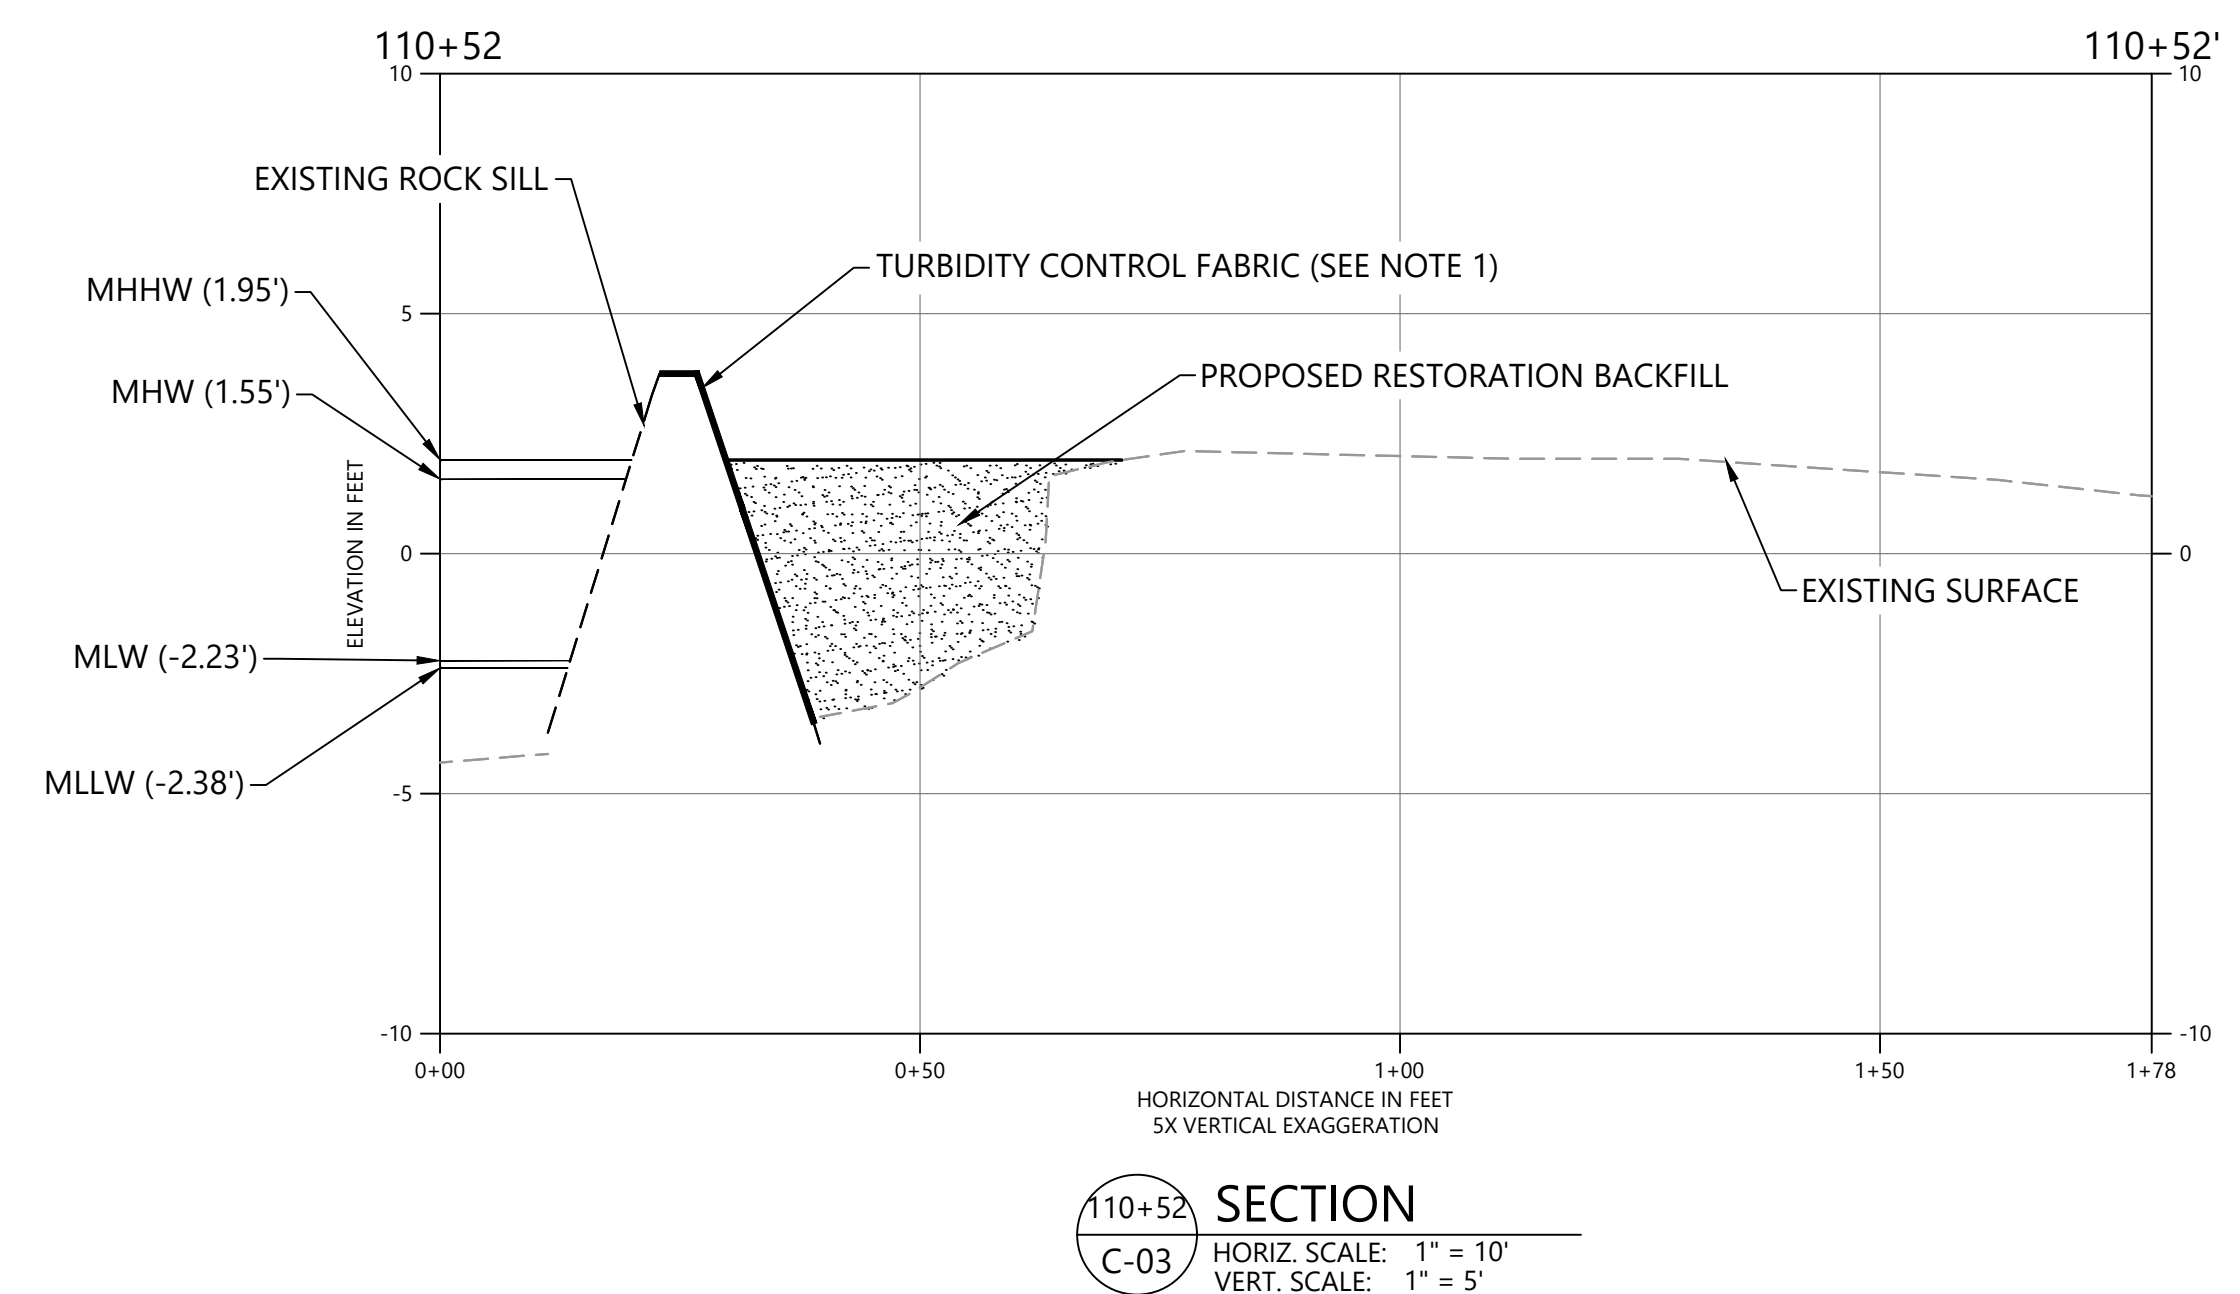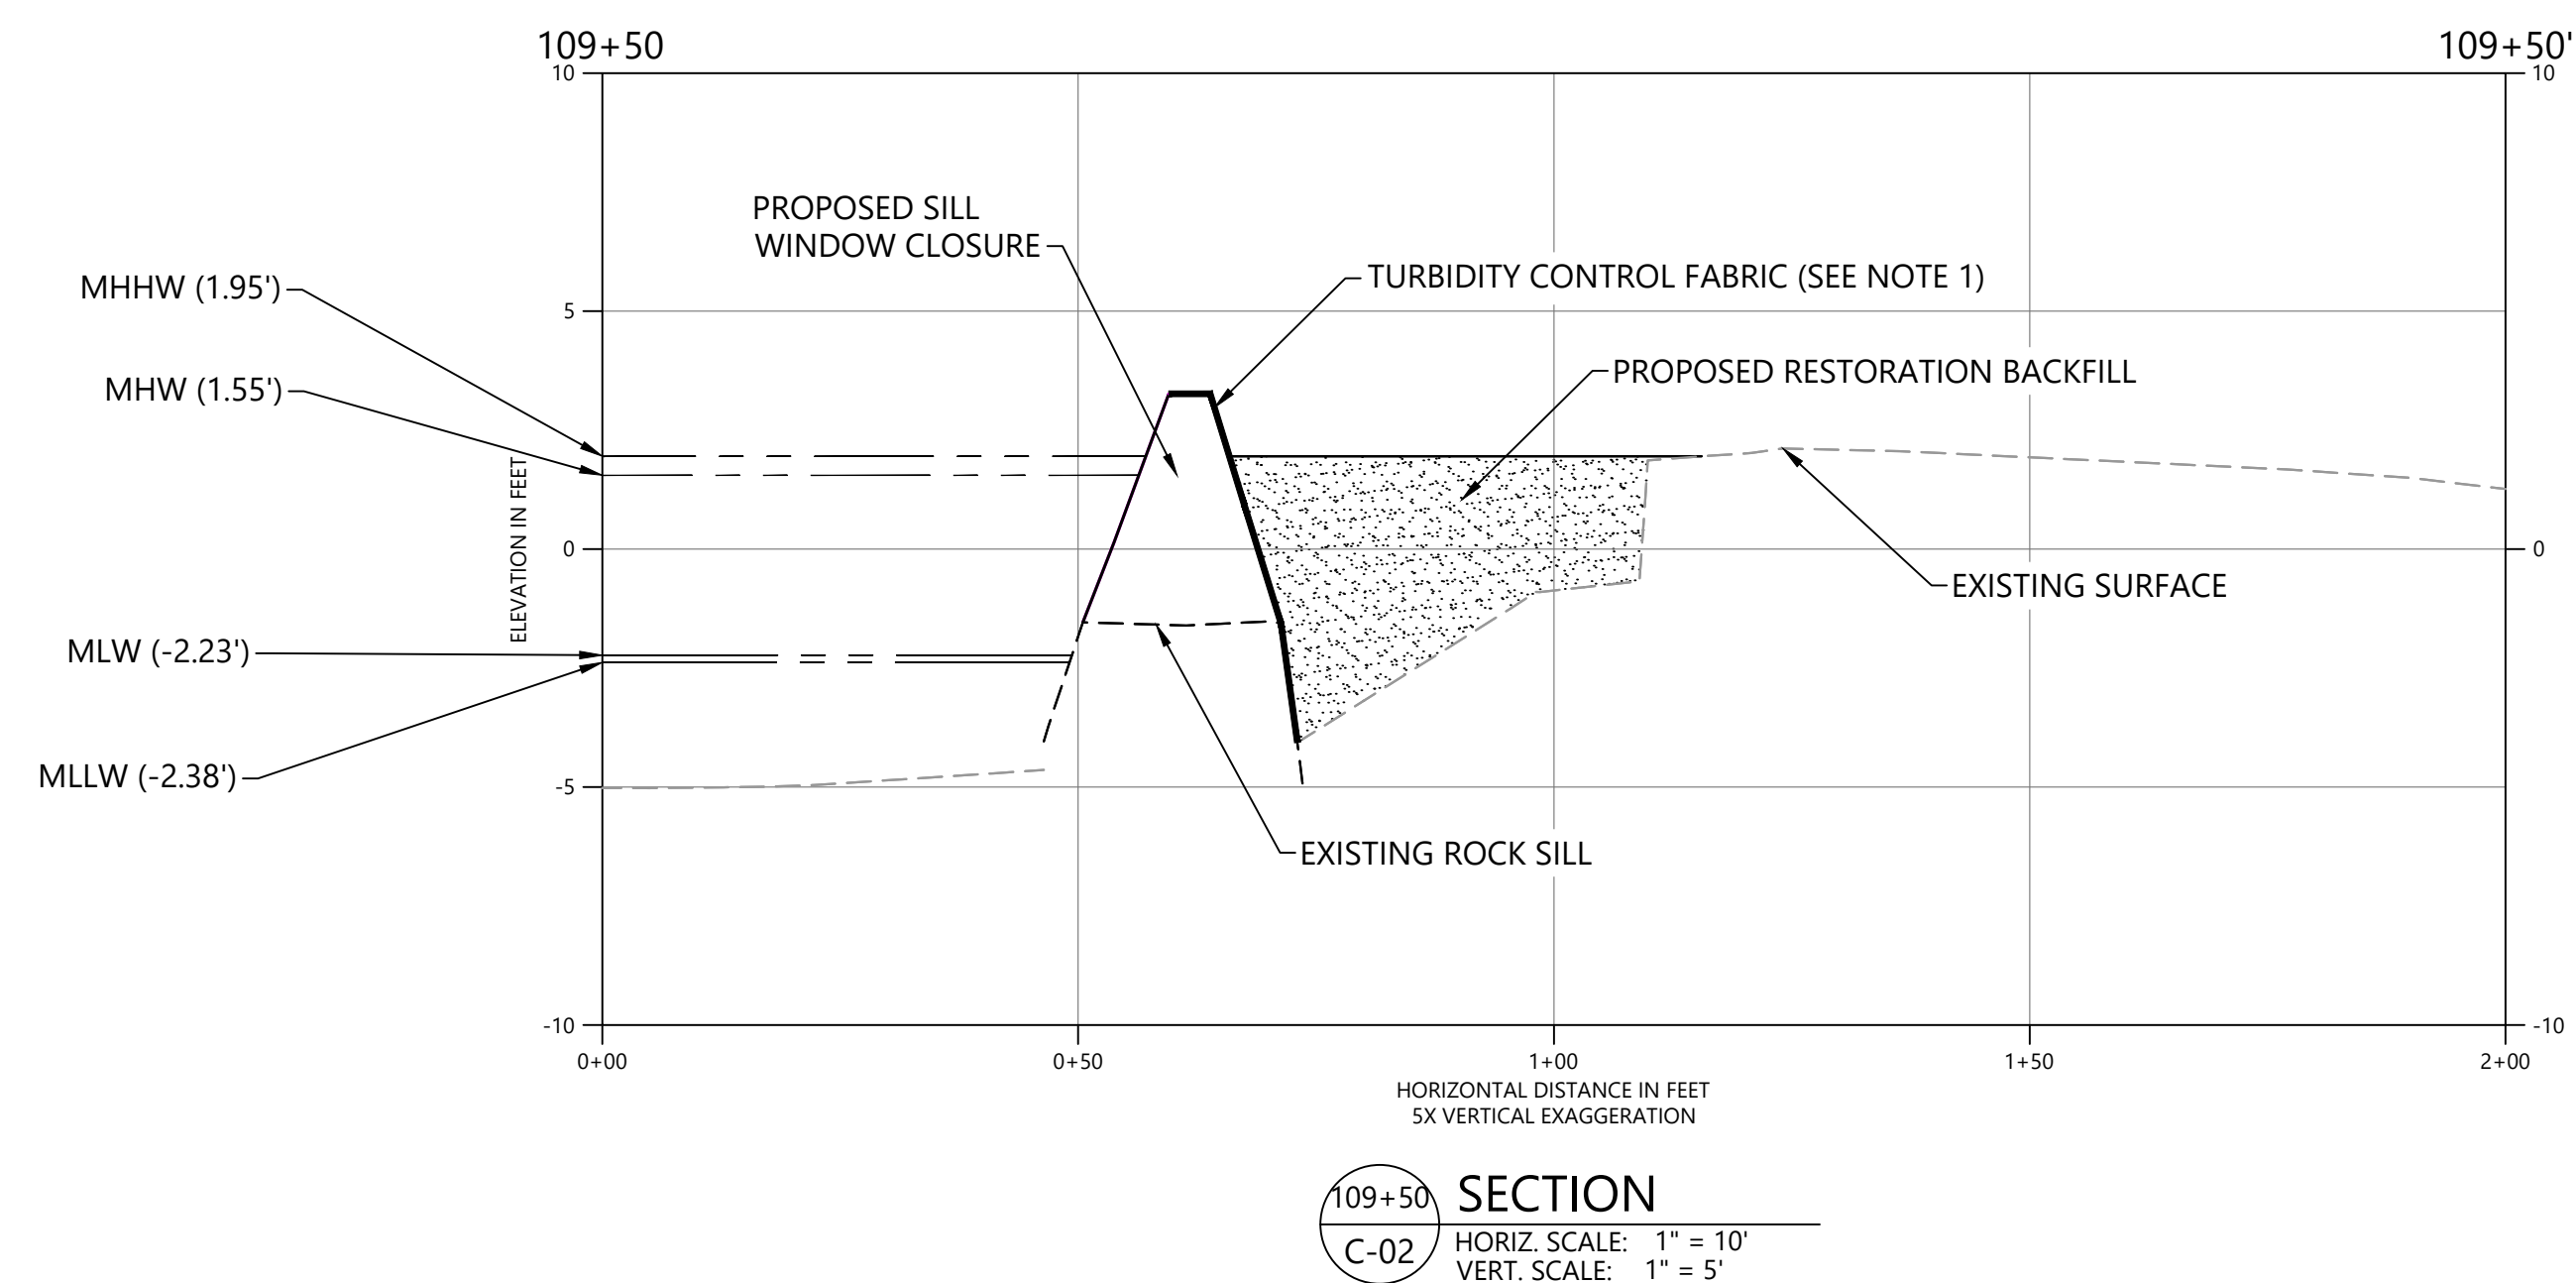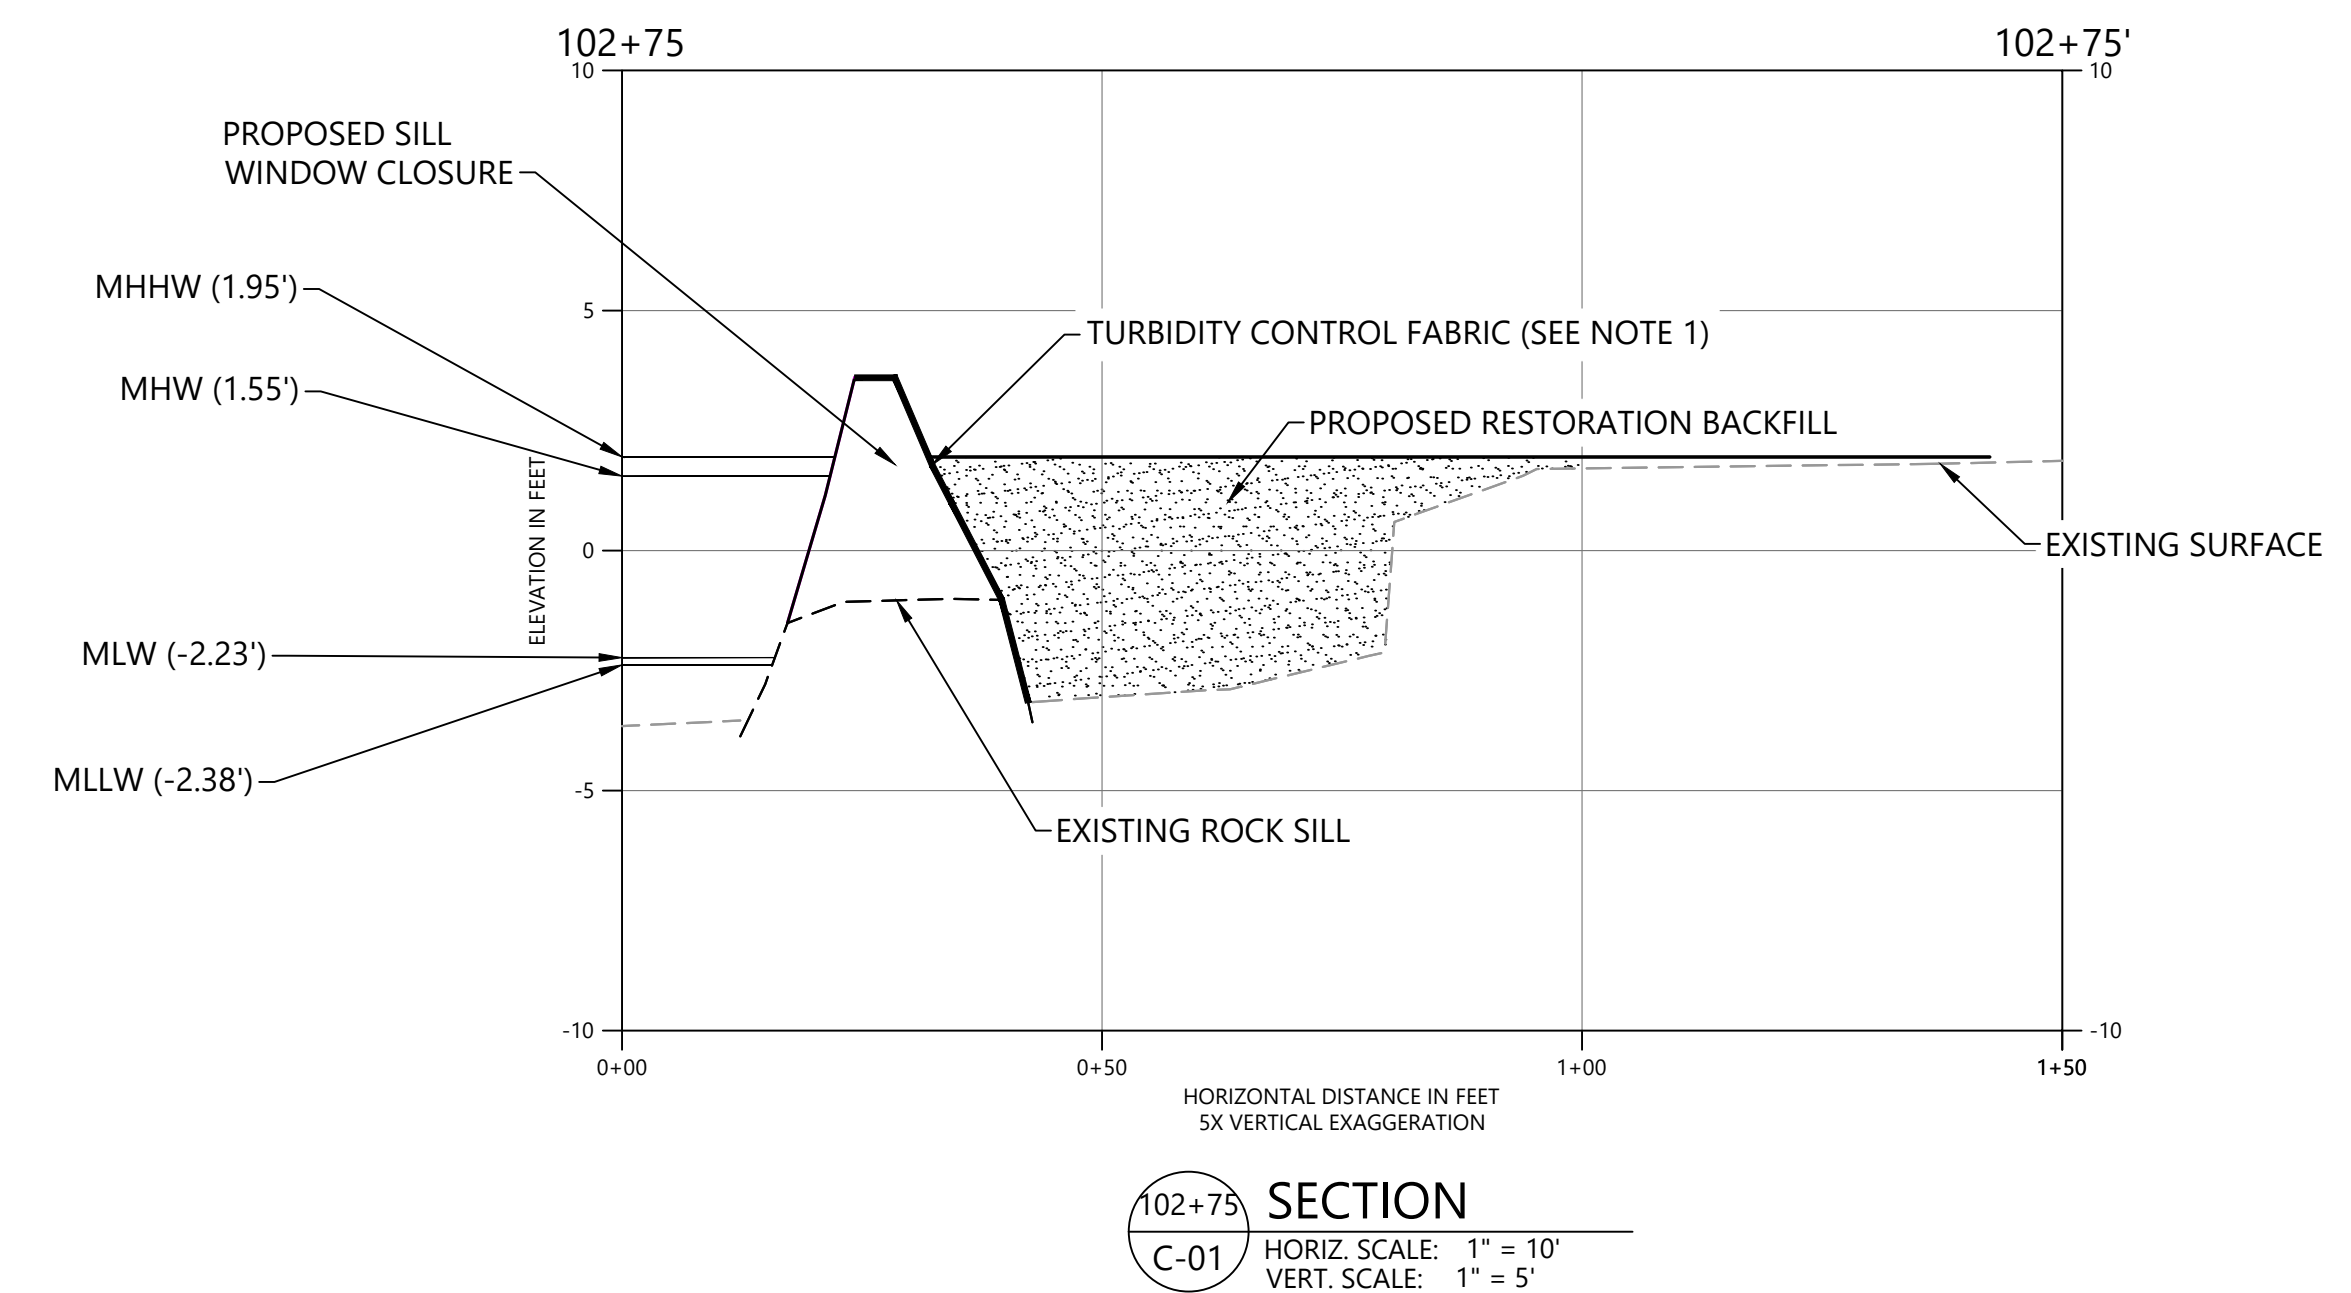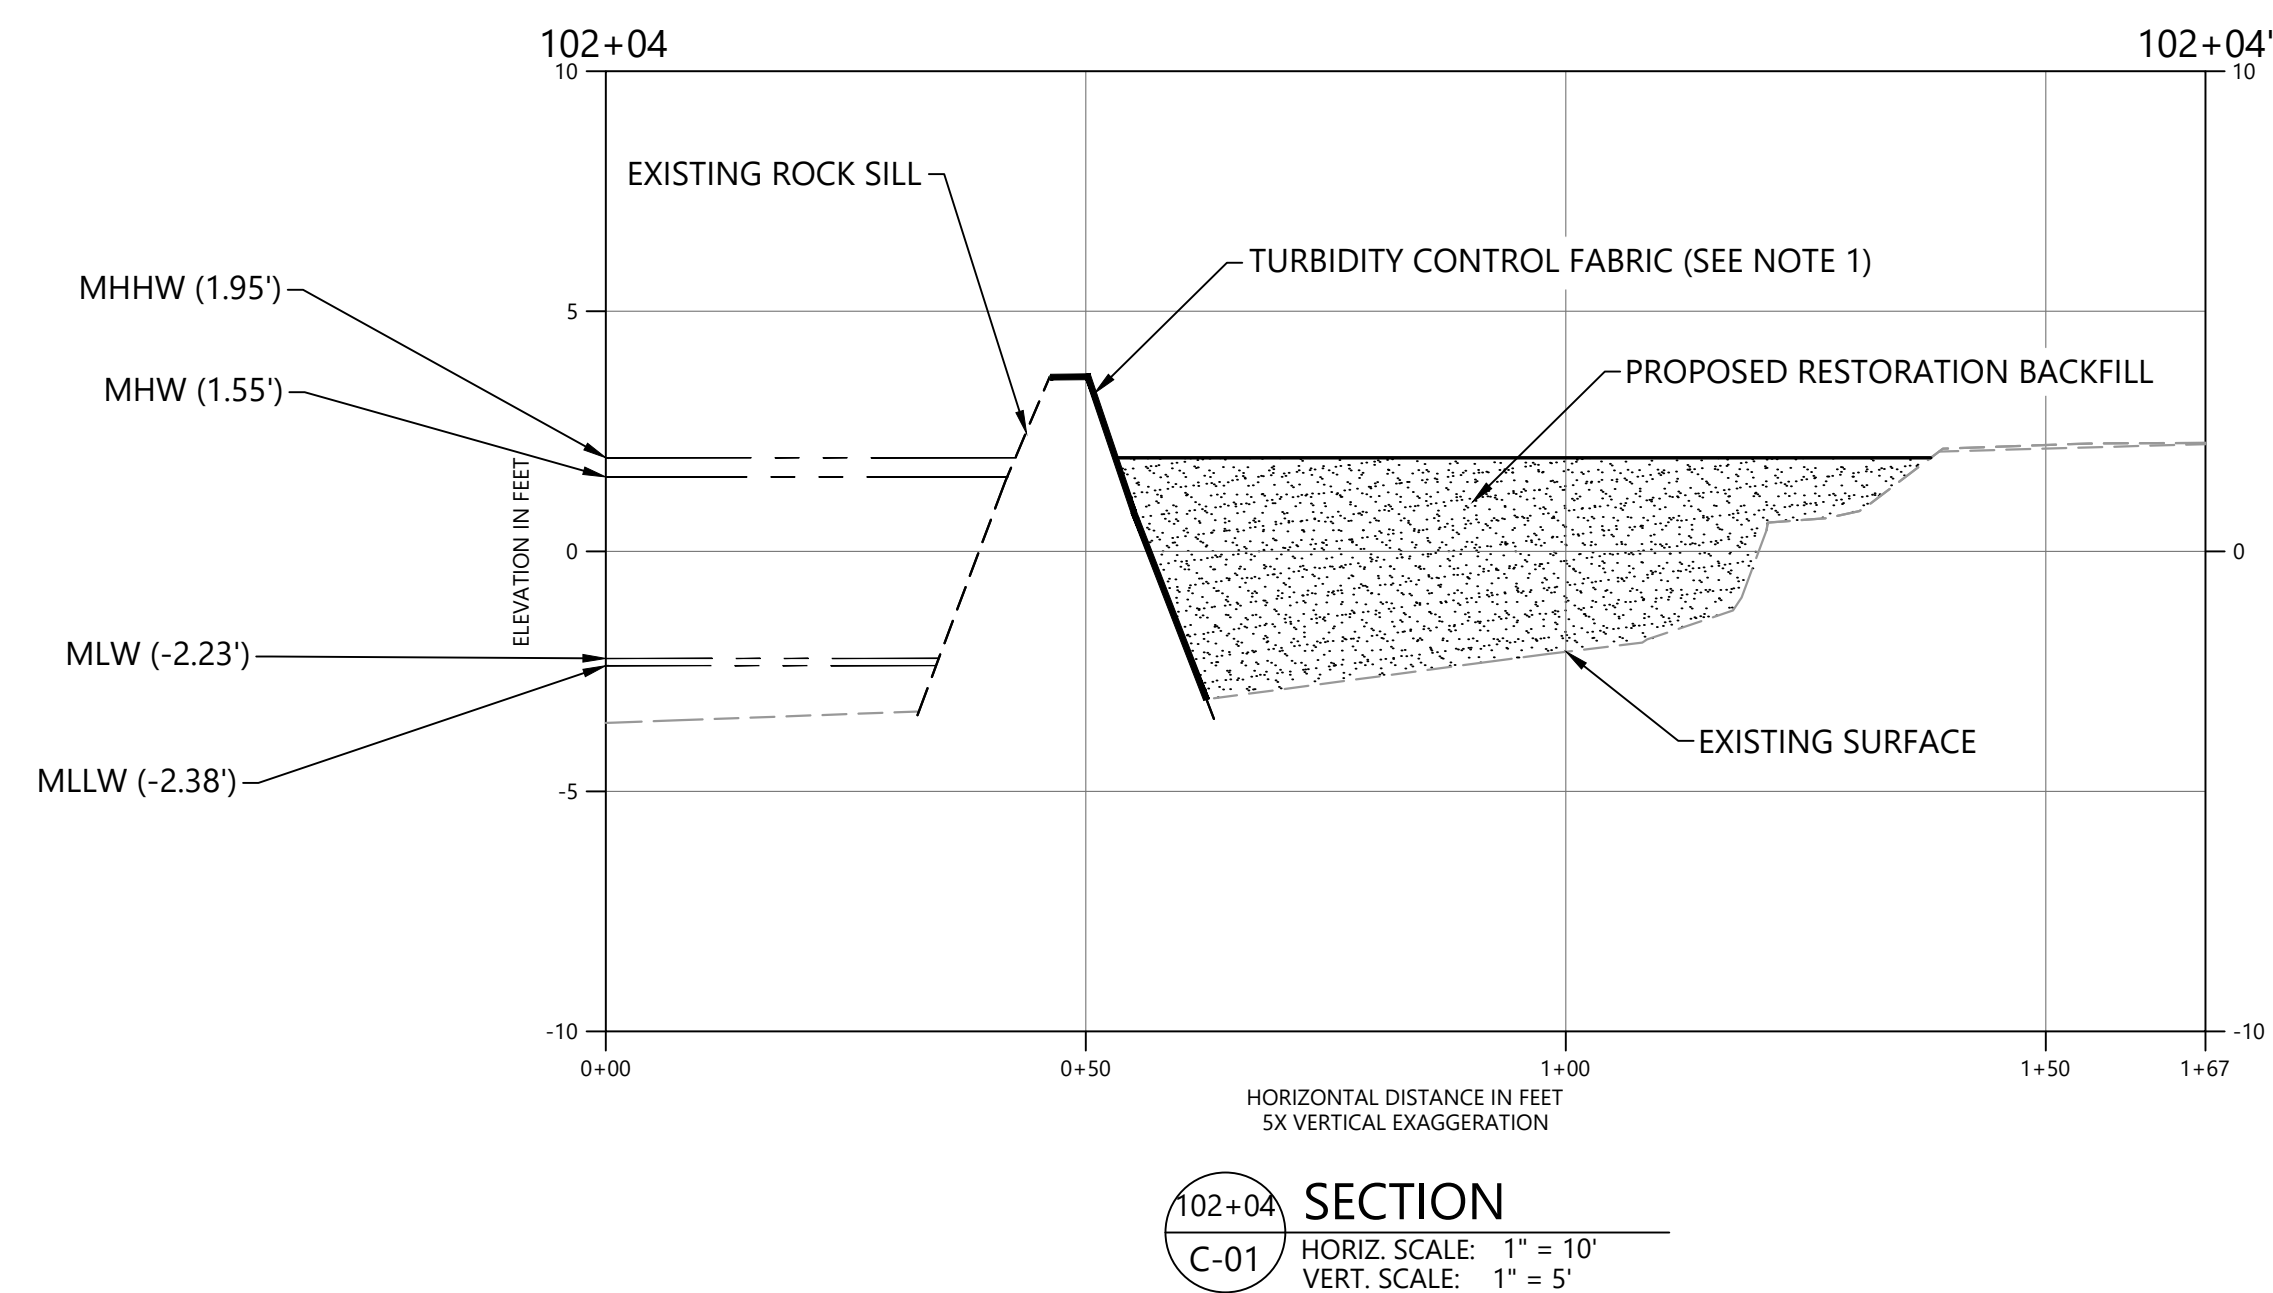

NOTE:
1. SECURE BIODEGRADABLE EROSION CONTROL BLANKET OVER SILL CREST AND AT INTERIOR TOE OF SLOPE.

[illegible]

DESIGNED BY: S. BAGNULL
DRAWN BY: B. HURRY
CHECKED BY: T. MERRITTS
APPROVED BY: R. MOHAN
SCALE: AS NOTED
DATE: NOVEMBER 2019

**SHOOTING ISLAND HABITAT RESTORATION AND
COASTAL RESILIENCY PROJECT- PHASES 2, 3, AND 4
CITY OF OCEAN CITY, NJ**


PHASE 2 BACKFILL CROSS SECTIONS

C-07


SHEET NO. 10 OF 21

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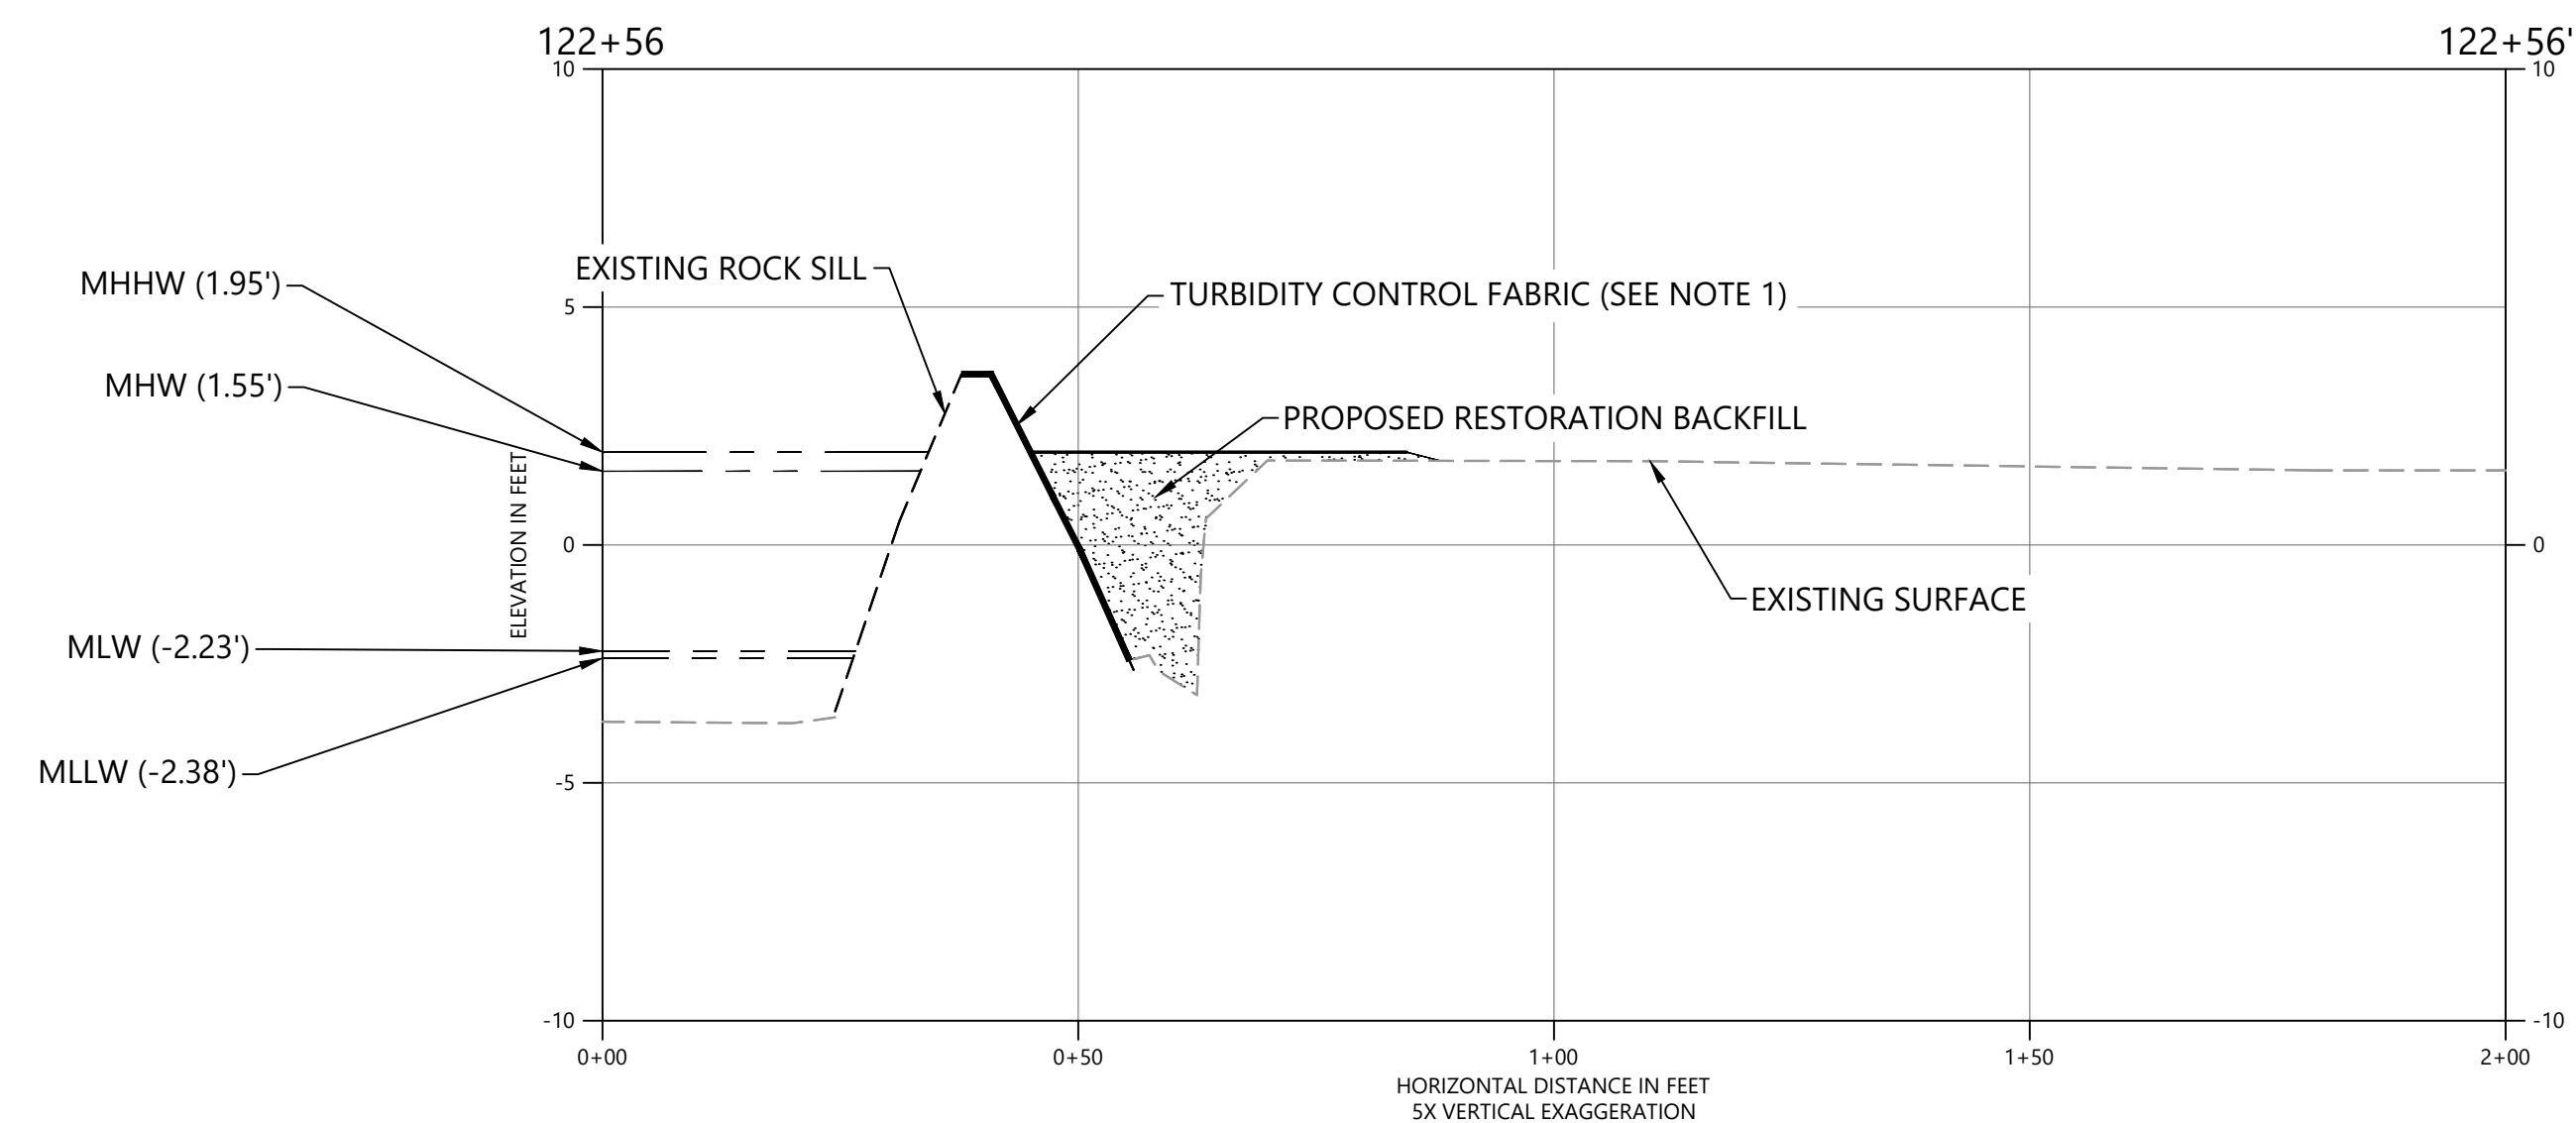
ONE INCH
AT FULL SIZE, IF NOT ONE
INCH SCALE ACCORDINGLY

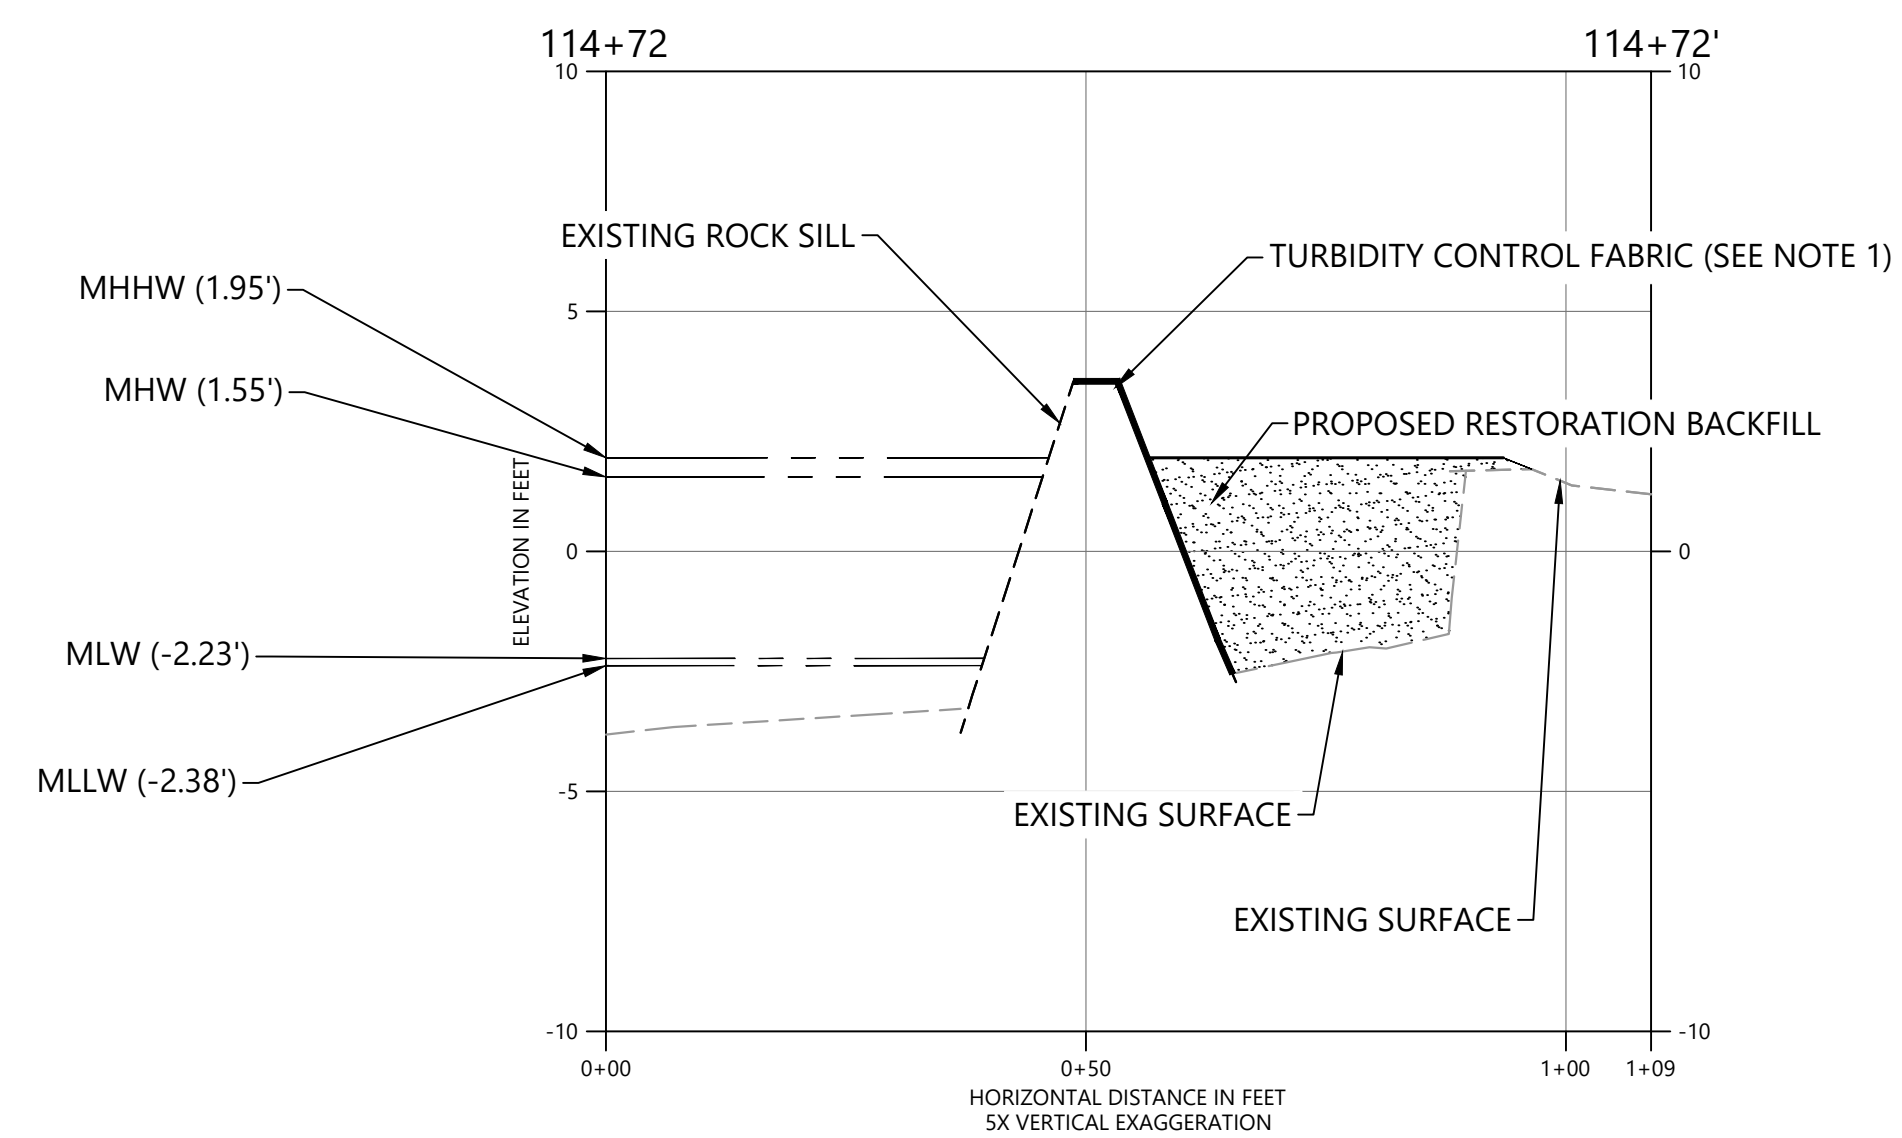


114+72
C-03

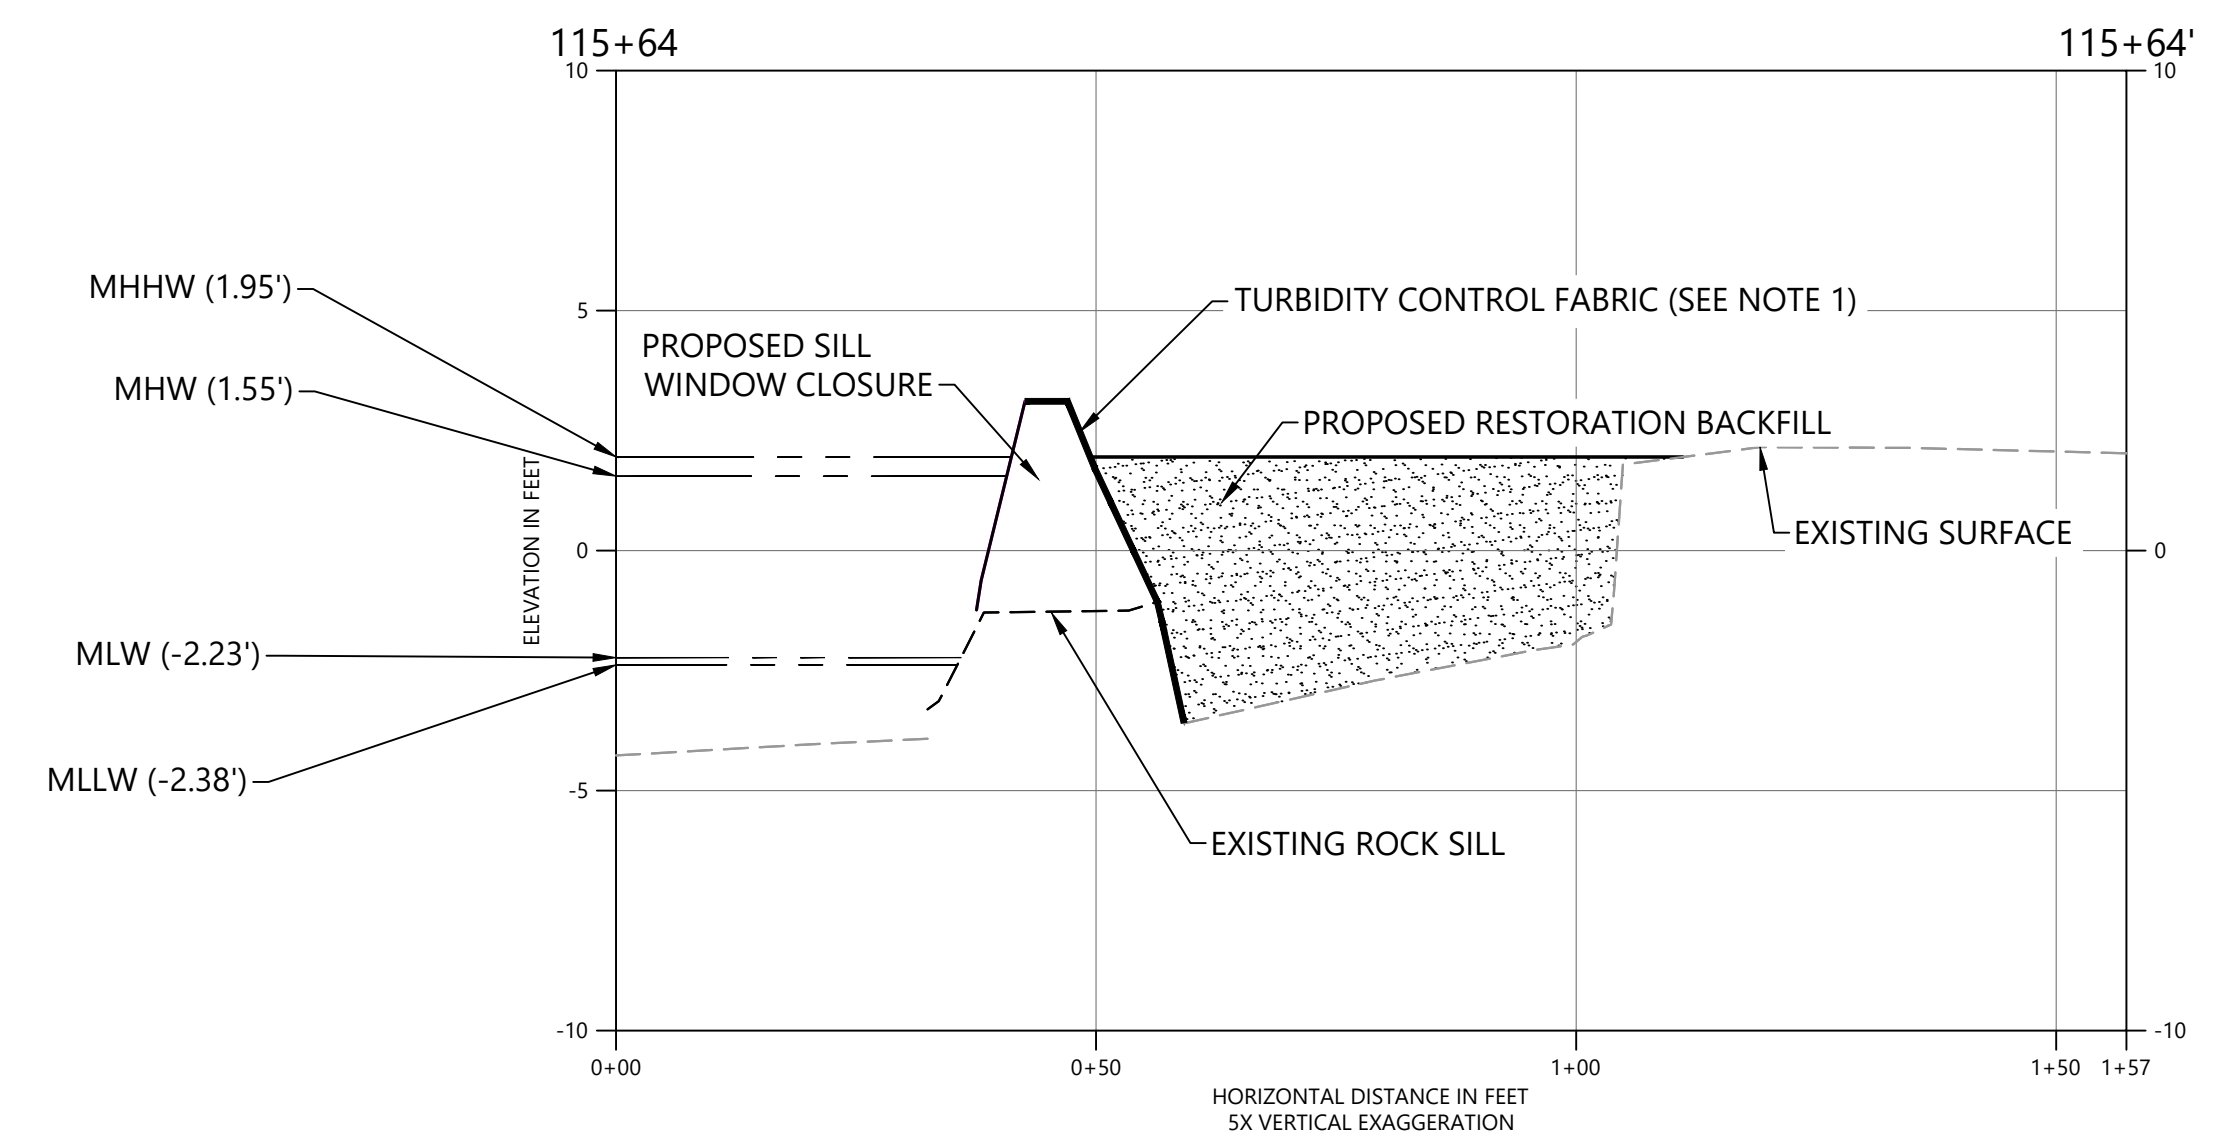

115+64
C-04



122+56 SECTION
C-05
HORIZ. SCALE: 1" = 10'
VERT. SCALE: 1" = 5'

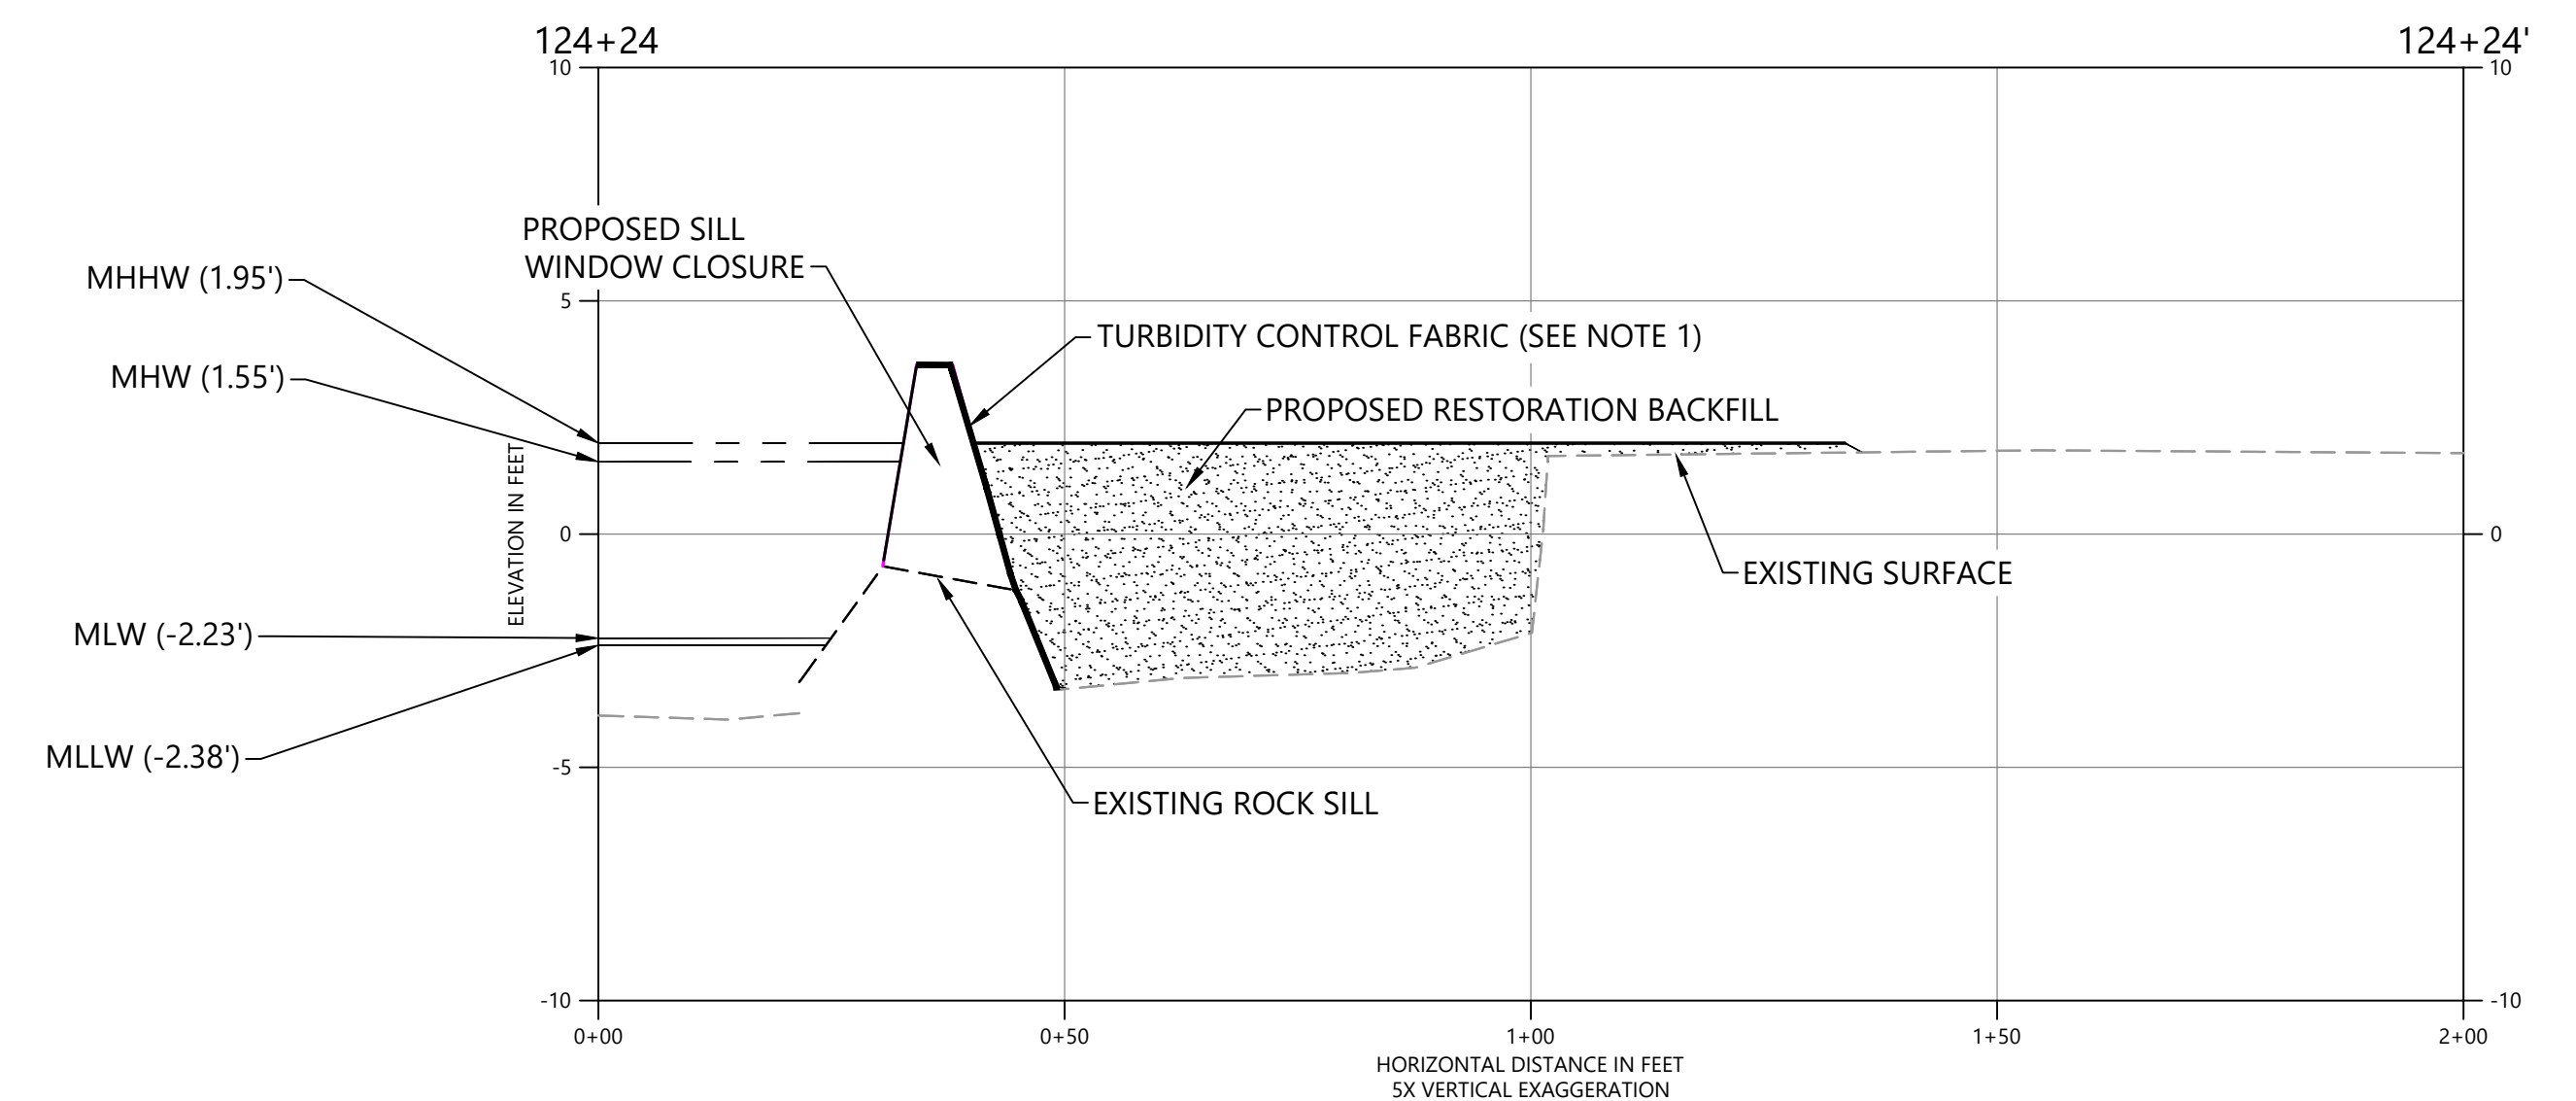

124+24
C-05

NOTE:
1. SECURE BIODEGRADABLE EROSION CONTROL BLANKET OVER SILL CREST AND AT INTERIOR TOE OF SLOPE.



REVISIONS				
REV	DATE	BY	APP'D	DESCRIPTION
	7/26/2018	BDH	RKM	ADDITION OF SILL VENTS
	9/27/2018	BDH	RKM	ADDITION OF SILL WINDOWS AND OYSTER HABITAT BLOCK MODIFICATIONS

DESIGNED BY: S. BAGNULL
DRAWN BY: B. HURRY
CHECKED BY: T. MERRITTS
APPROVED BY: R. MOHAN
SCALE: AS NOTED
DATE: NOVEMBER 2019

**SHOOTING ISLAND HABITAT RESTORATION AND
COASTAL RESILIENCY PROJECT- PHASES 2, 3, AND 4
CITY OF OCEAN CITY, NJ**


PHASE 2 BACKFILL- CROSS SECTIONS

C-08


SHEET NO. 11 OF 21

AT FULL SIZE, IF NOT ONE INCH SCALE ACCORDINGLY

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1 GRADING AND PLANTING DETAIL
C-09 SCALE: 1" = 2'

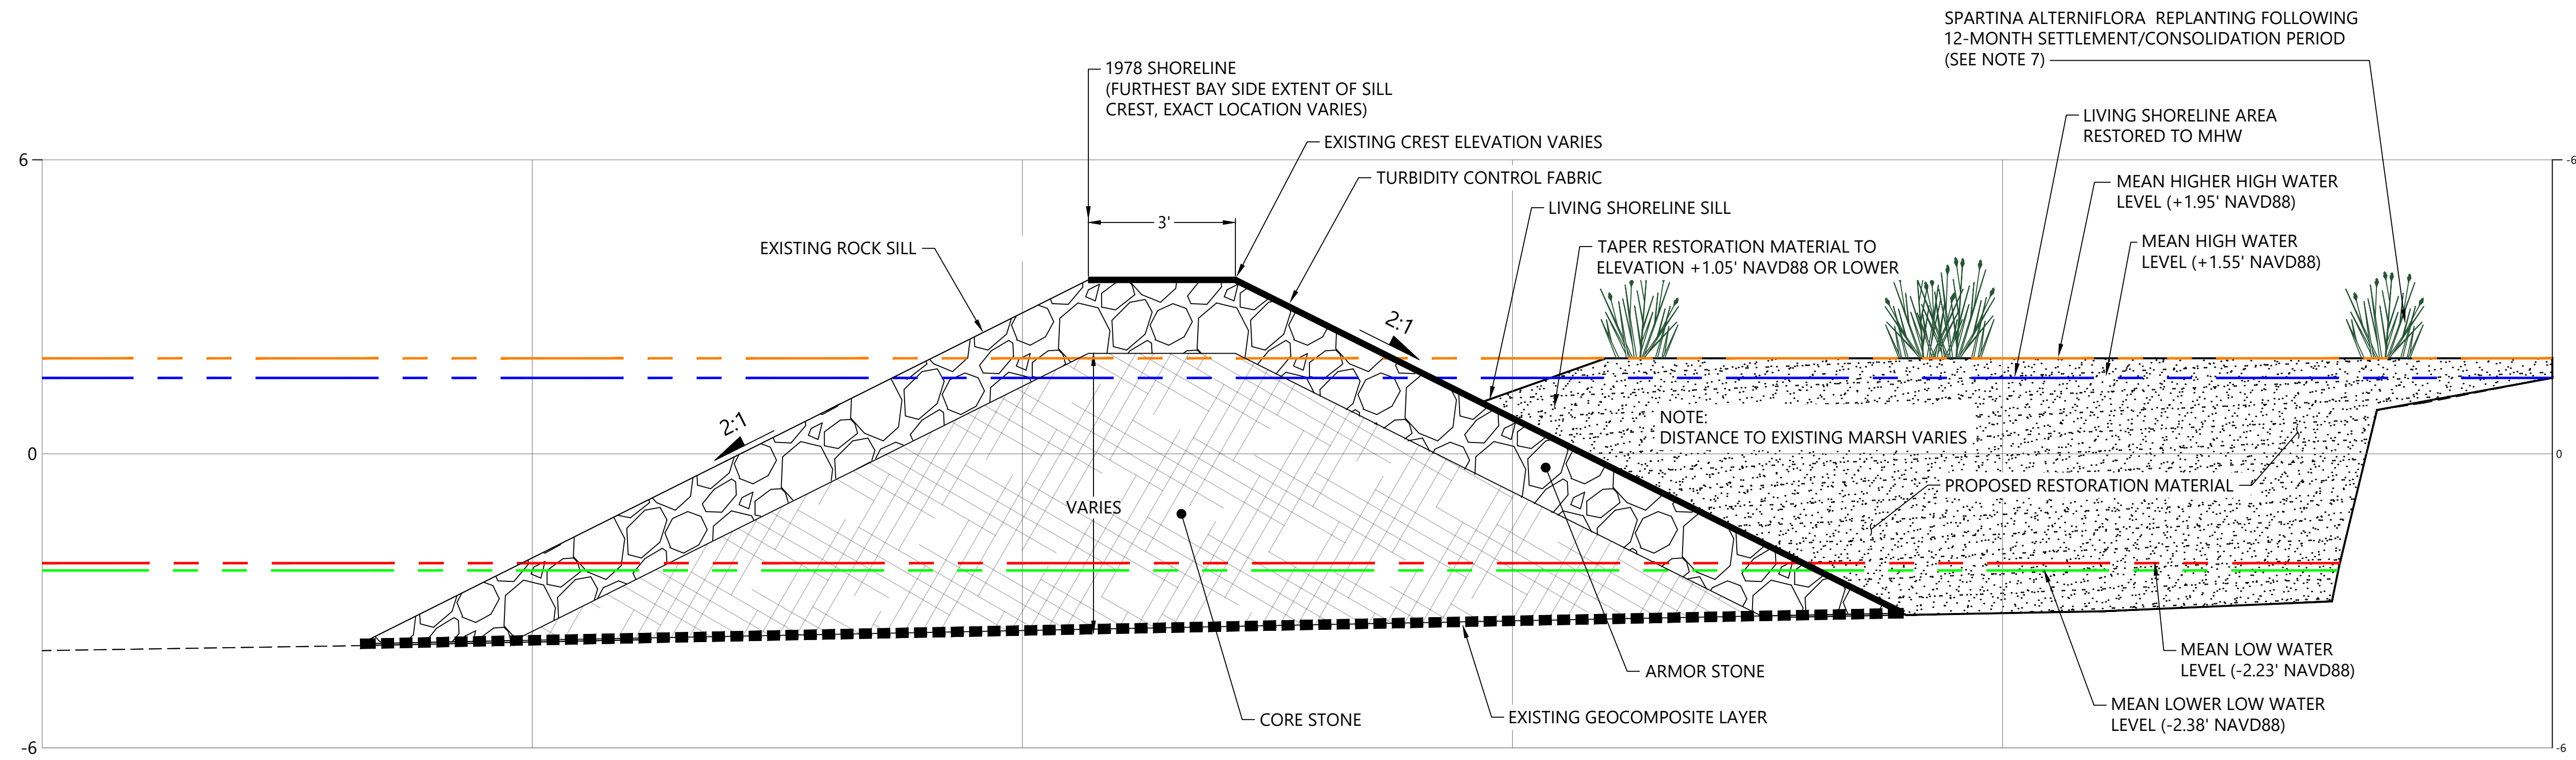

2 SILL WINDOW CLOSURE TYPICAL DETAIL
C-09 SCALE: 1" = 2'

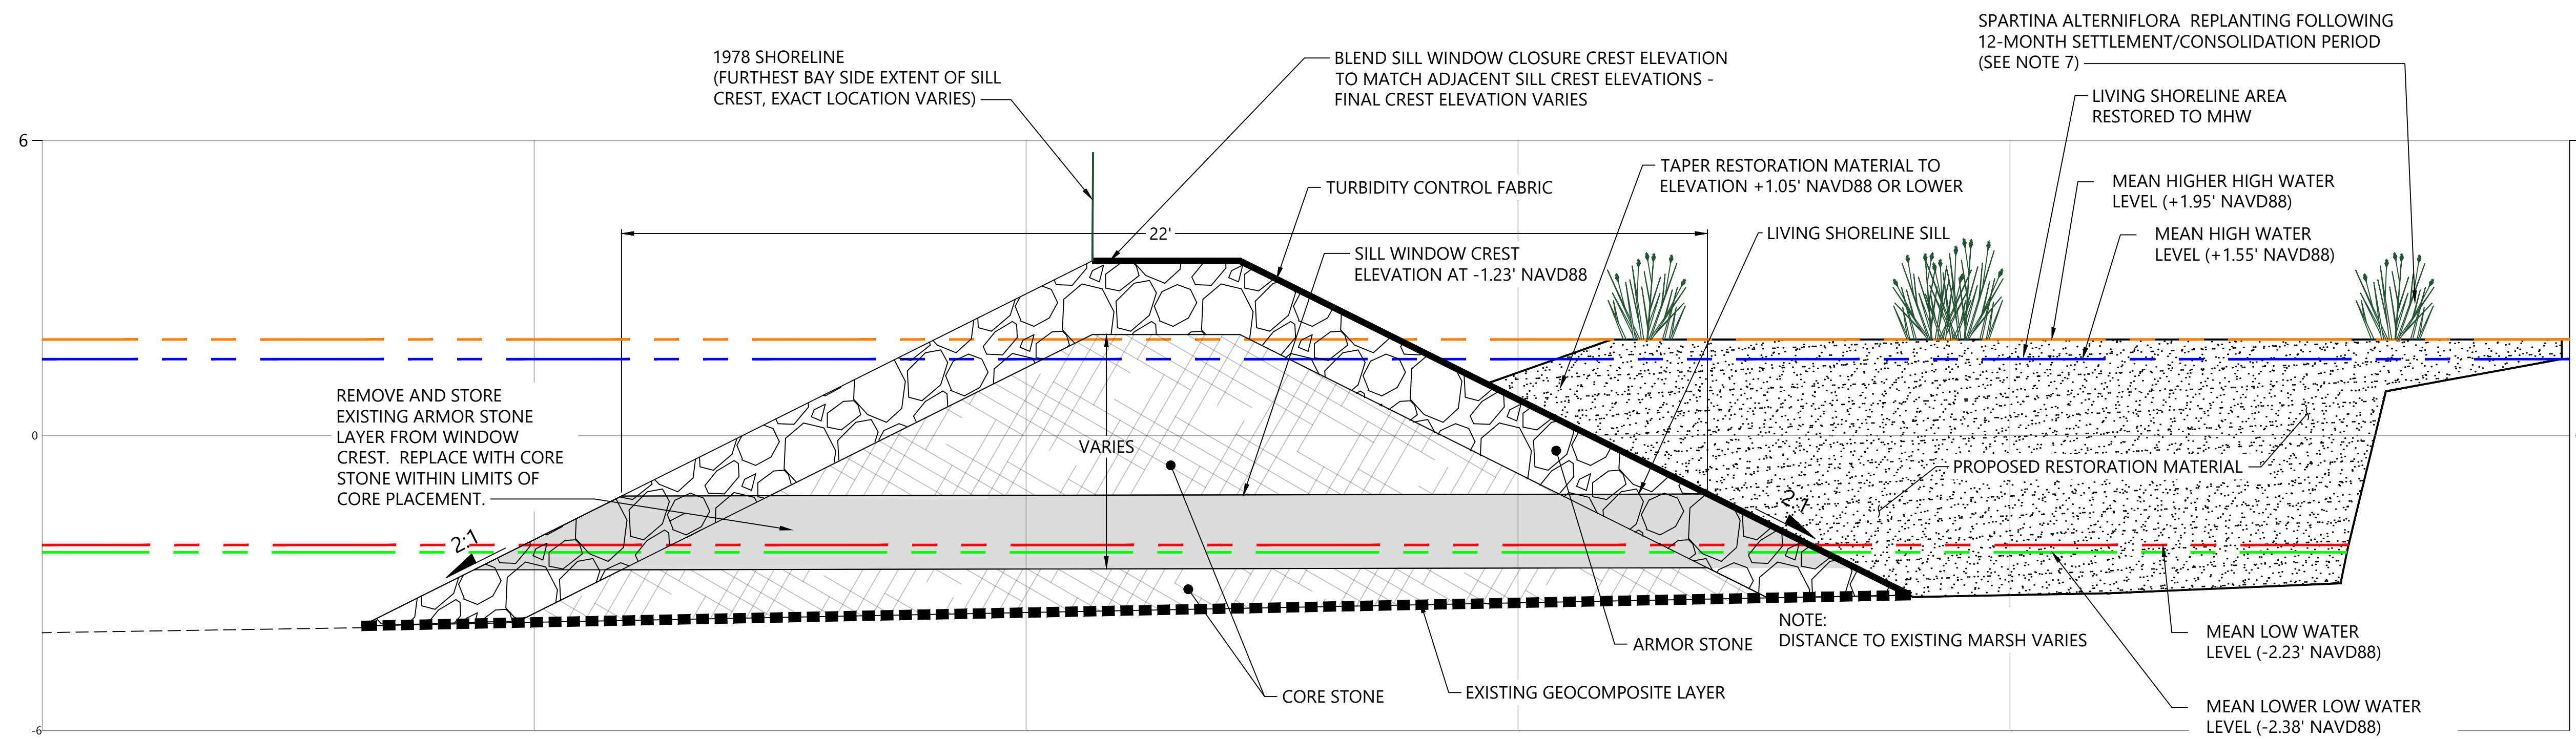NOTES

1. REMOVE AND TEMPORARILY STORE UPPER 18-INCHES OF ARMOR STONE FROM LIVING SHORELINE ROCK SILL FISH WINDOW CREST AND SLOPES TO ADJOINING SILL ALIGNMENT TO EXPOSE UNDERLYING CORE MATERIAL.
2. SUPPLEMENT CORE MATERIAL USING AASHTO #57 CORE STONE MATERIAL, OR APPROVED EQUAL, TO LIMITS AND GRADES SHOWN. CORE DIMENSIONS OF ADJOINING SILL ALIGNMENT MAY VARY, TAPER CORE STONE TO MATCH ADJACENT SILL.
3. REPLACE REMOVED ARMOR STONE AND SUPPLEMENT WITH R-4 RIP RAP, OR APPROVED EQUAL, TO THE LIMITS AND GRADES SHOWN.
4. ELEVATIONS OF ADJOINING SILL ALIGNMENT MAY VARY, BLEND FINAL PLACEMENT OF ARMOR STONE TO MATCH ADJACENT ALIGNMENT. MINIMUM 18-INCHES OF ARMOR STONE REQUIRED IN ALL AREAS.
5. INSTALL AND SECURE EROSION PROTECTION BLANKET OVER RECONSTRUCTED SILL CREST AND INTERIOR SLOPE AS SHOWN.
6. CONDUCT PLACEMENT OF 11,200 CY OF RESTORATION BACKFILL MATERIAL BETWEEN ROCK SILL AND ISLAND SHORELINE.
 - a. PLACEMENT SHALL BE CONDUCTED IN LIFTS NO GREATER THAN 48-INCHES OVER ANY 48-HOUR PERIOD.
 - b. ALLOW MINIMUM 24-HOUR CONSOLIDATION PERIOD FOLLOWING PLACEMENT OF LIFT.
 - c. CONTINUE PLACEMENT AND CONSOLIDATION UNTIL TOP ELEVATION OF RESTORATION BACKFILL IS WITHIN +/-0.5- FEET OF TARGETED FILL ELEVATION 30 DAYS FOLLOWING FINAL PLACEMENT.
 - d. 60 DAYS FOLLOWING FINAL PLACEMENT AND VERIFICATION OF ACCEPTABLE ELEVATION, UNSECURE EROSION CONTROL BLANKET FROM SILL CREST, FOLD EXCESS FABRIC ONTO RESTORATION BACKFILL SURFACE AND SECURE IN PLACE.
7. PLANTING TYPE AND DENSITY SHALL BE IN ACCORDANCE WITH PROJECT TECHNICAL SPECIFICATIONS.



ONE INCH
AT FULL SIZE, IF NOT ONE
INCH SCALE ACCORDINGLY



REVISIONS					
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SCALE: AS NOTED
DATE: NOVEMBER 2019

SHOOTING ISLAND HABITAT RESTORATION AND
COASTAL RESILIENCY PROJECT- PHASES 2, 3, AND 4
CITY OF OCEAN CITY, NJ

PHASE 2 BACKFILL- TYPICAL SECTION DETAIL

C-09


SHEET NO. 12 OF 21



A map of the study area in the northern Gulf of Mexico. The map shows the coastline of the United States and the Gulf of Mexico. A red line outlines the study area, which includes the northern Gulf of Mexico and the northern coast of the United States. A gray shaded area represents the location of Shooting Island. A dashed line indicates the boundary of the study area. A scale bar at the bottom indicates distances in feet (0, 1000, 2000). A north arrow is also present.

HORIZONTAL DATUM: NEW JERSEY STATE PLANE, NAD83,
U.S. FEET.

VERTICAL DATUM: VERTICAL DATUM OF 1988 (NAVD88).

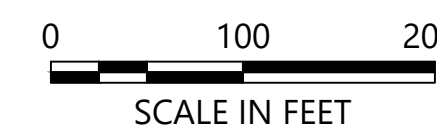

ONE INCH
AT FULL SIZE, IF NOT ONE INCH SCALE ACCORDINGLY


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SCALE: AS NOTED
DATE: NOVEMBER 2019


PHASE 3 - THIN LAYER PLACEMENT PLAN (1 OF 3)

SHEET NO. 14 OF 21



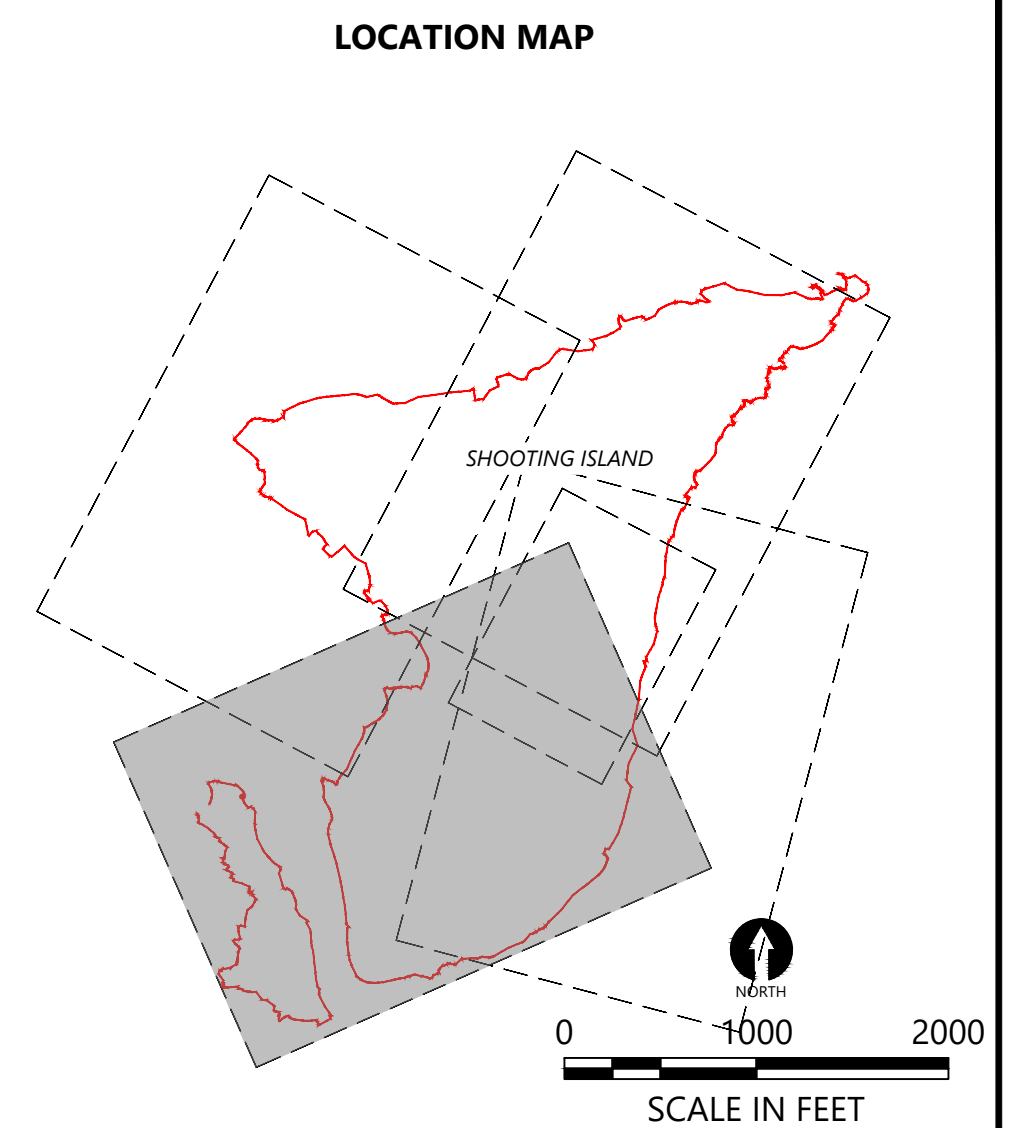

LEGEND:

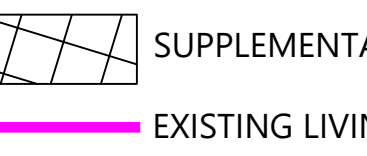


- EXISTING CONTOURS (1' AND 5')
- SUPPLEMENTAL RESTORATION AREA
- EXISTING LIVING SHORELINE SILL
- EXISTING CONCRETE HABITAT BLOCK SHORELINE
- 2017 SHORELINE
- THIN LAYER PLACEMENT CELL BOUNDARY
- TRANSITION ZONE
- COIR LOG PLACEMENT

SOURCE: BASE LINE WORK PREPARED BY ACT ENGINEERS, INC. BASED ON FIELD SURVEY CONDUCTED ON FEBRUARY 14, 2017 THROUGH MARCH 1, 2017 AND SUPPLEMENTED WITH NEARSHORE TOPOGRAPHY COLLECTED ON JULY 27, 2017. ADDITIONAL TOPOGRAPHIC SURVEY CONDUCTED IN MAY AND AUGUST 2019 BY ACT ENGINEERS, INC.

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VERTICAL DATUM: VERTICAL DATUM OF 1988 (NAVD88).

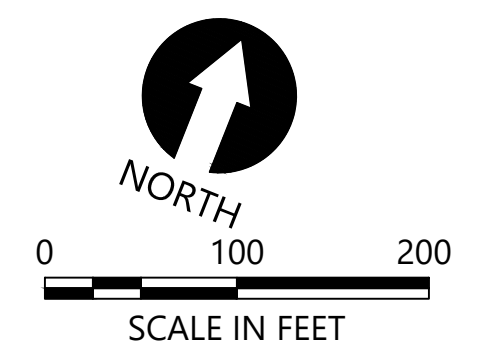

AT FULL SIZE, IF NOT ONE
INCH SCALE ACCORDINGLY

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APPROVED BY: R. MOHAN
SCALE: AS NOTED
DATE: NOVEMBER 2019


**SHOOTING ISLAND HABITAT RESTORATION AND
COASTAL RESILIENCY PROJECT- PHASES 2, 3, AND 4
CITY OF OCEAN CITY, NJ**

**PHASE 3 - THIN LAYER
PLACEMENT PLAN (3 OF 3)**


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SHEET NO. 16 OF 21


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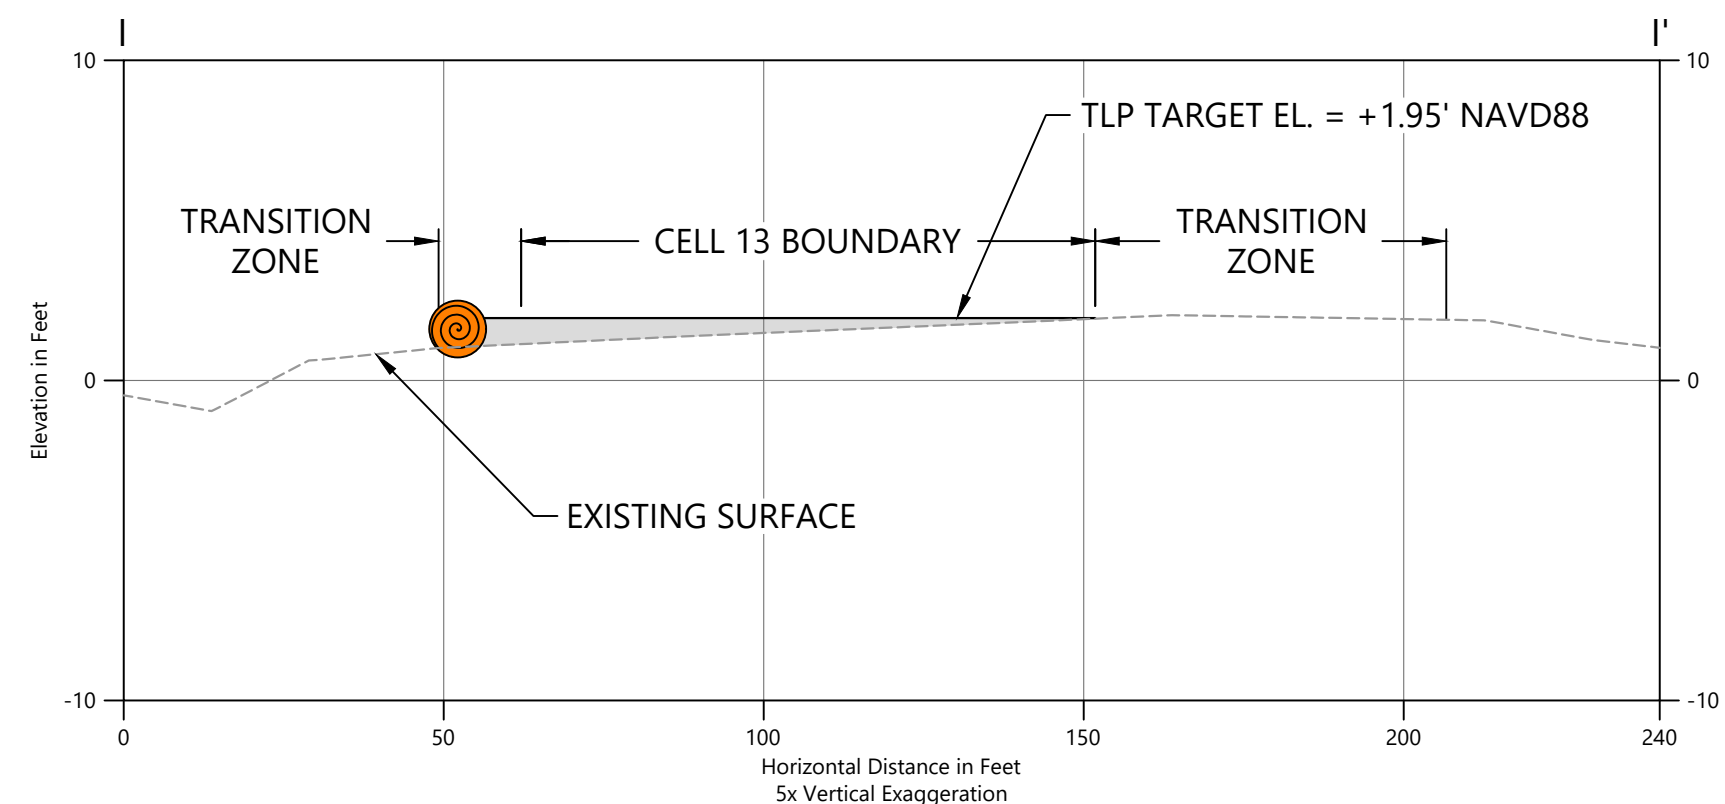
F SECTION
C-13 HORIZ. SCALE: 1" = 20'
VERT. SCALE: 1" = 4'

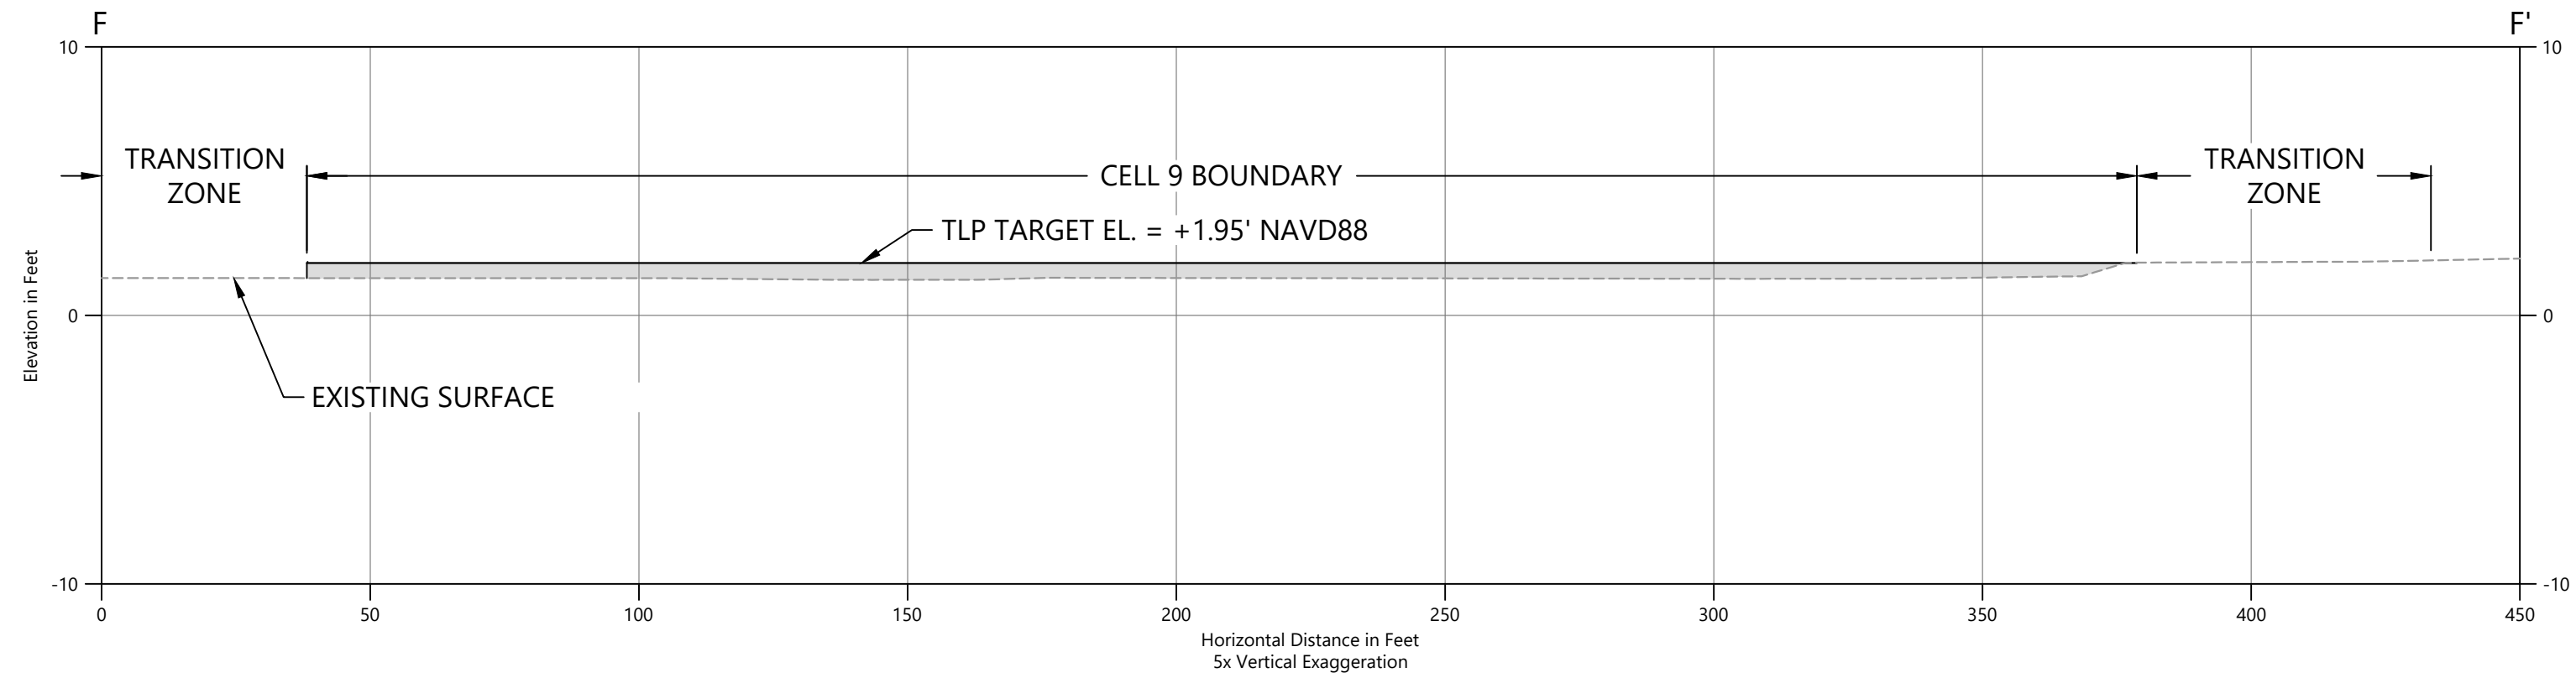

G SECTION
C-13 HORIZ. SCALE: 1" = 20'
VERT. SCALE: 1" = 4'

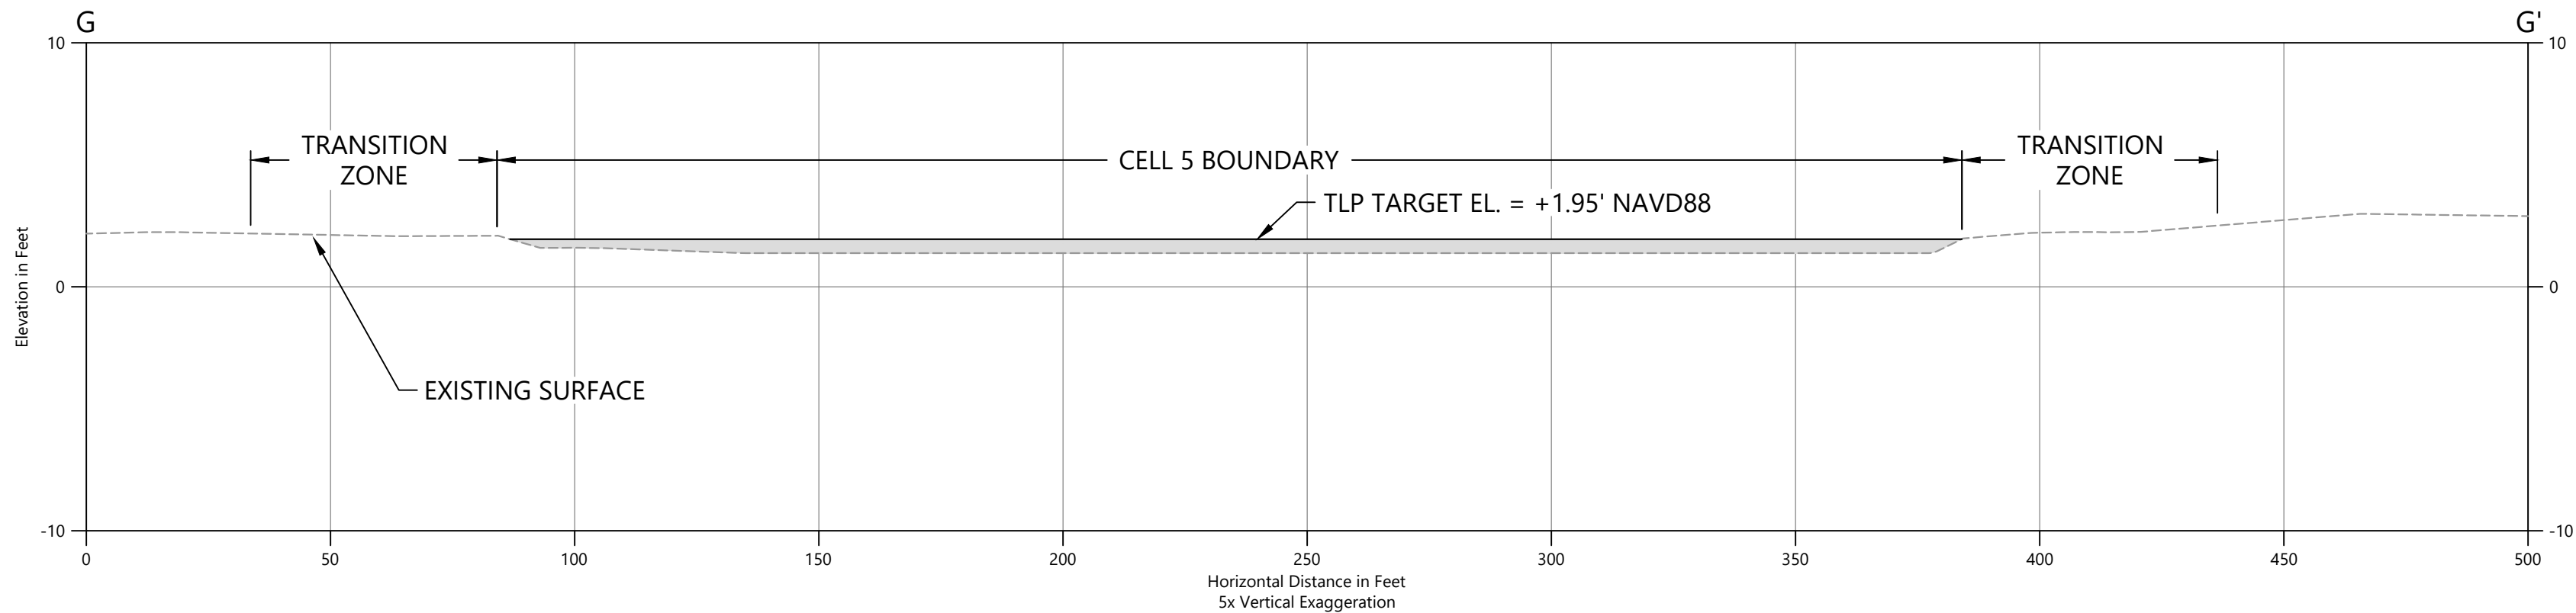

H SECTION
C-13 HORIZ. SCALE: 1" = 20'
VERT. SCALE: 1" = 4'

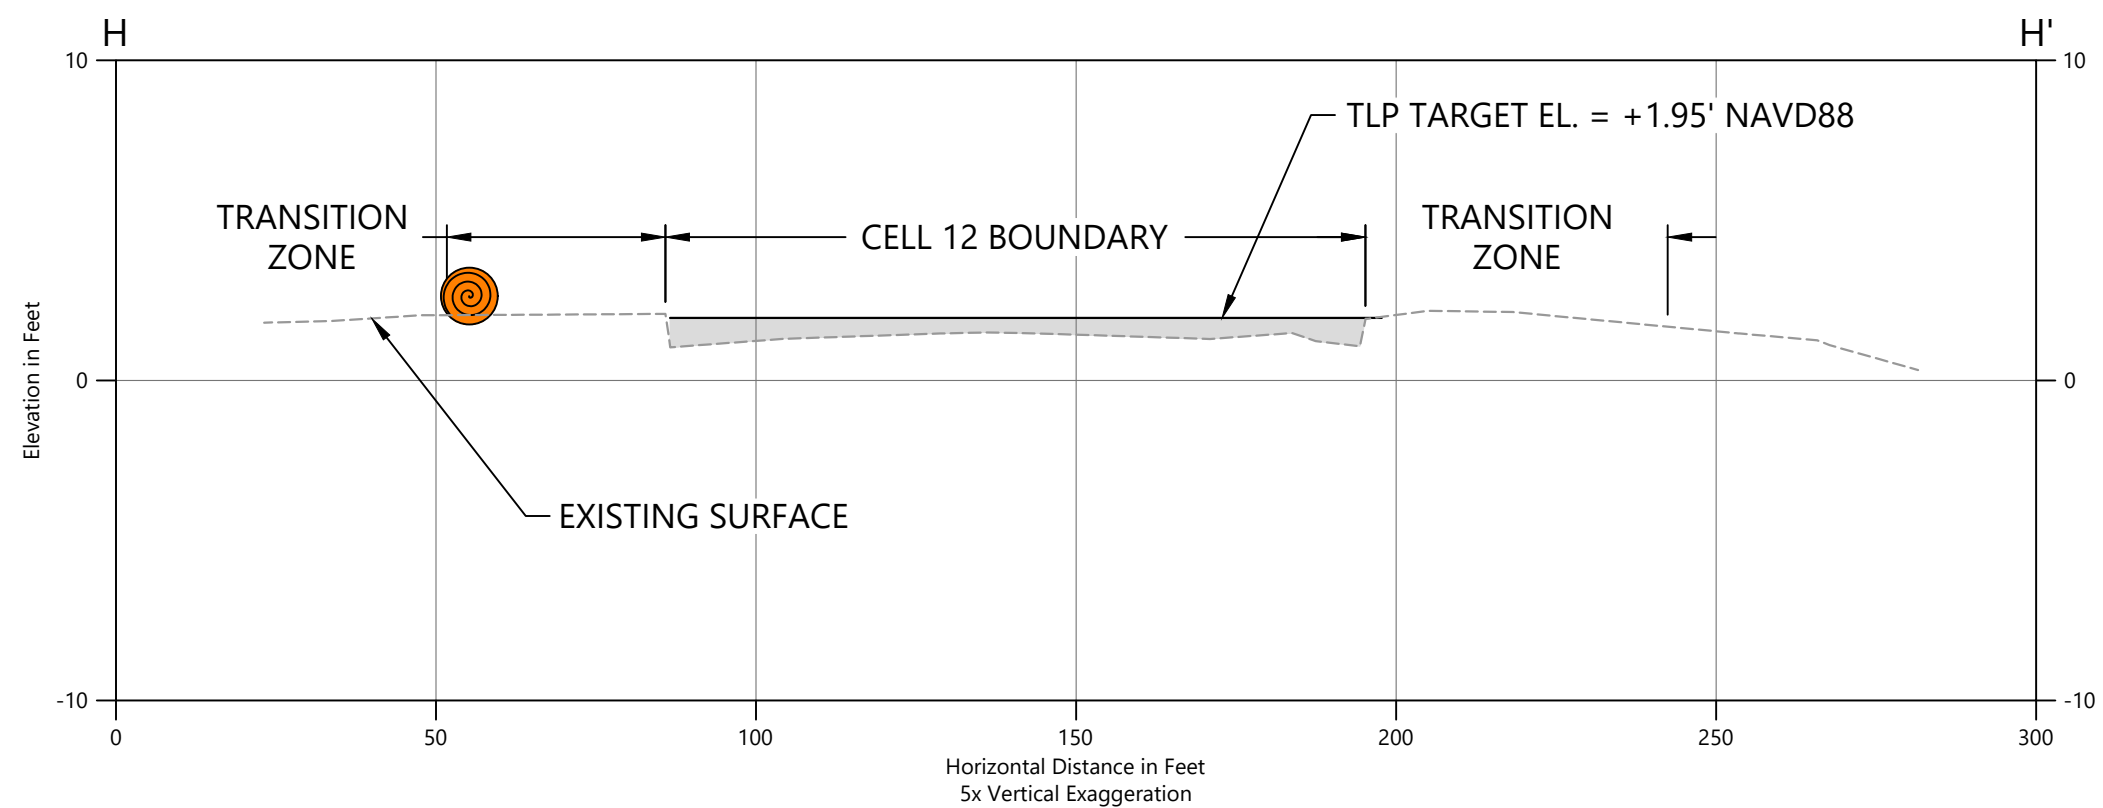

I SECTION
C-13 HORIZ. SCALE: 1" = 20'
VERT. SCALE: 1" = 4'

ONE INCH
↑
AT FULL SIZE, IF NOT ONE
↓
INCH SCALE ACCORDINGLY



REVISIONS					
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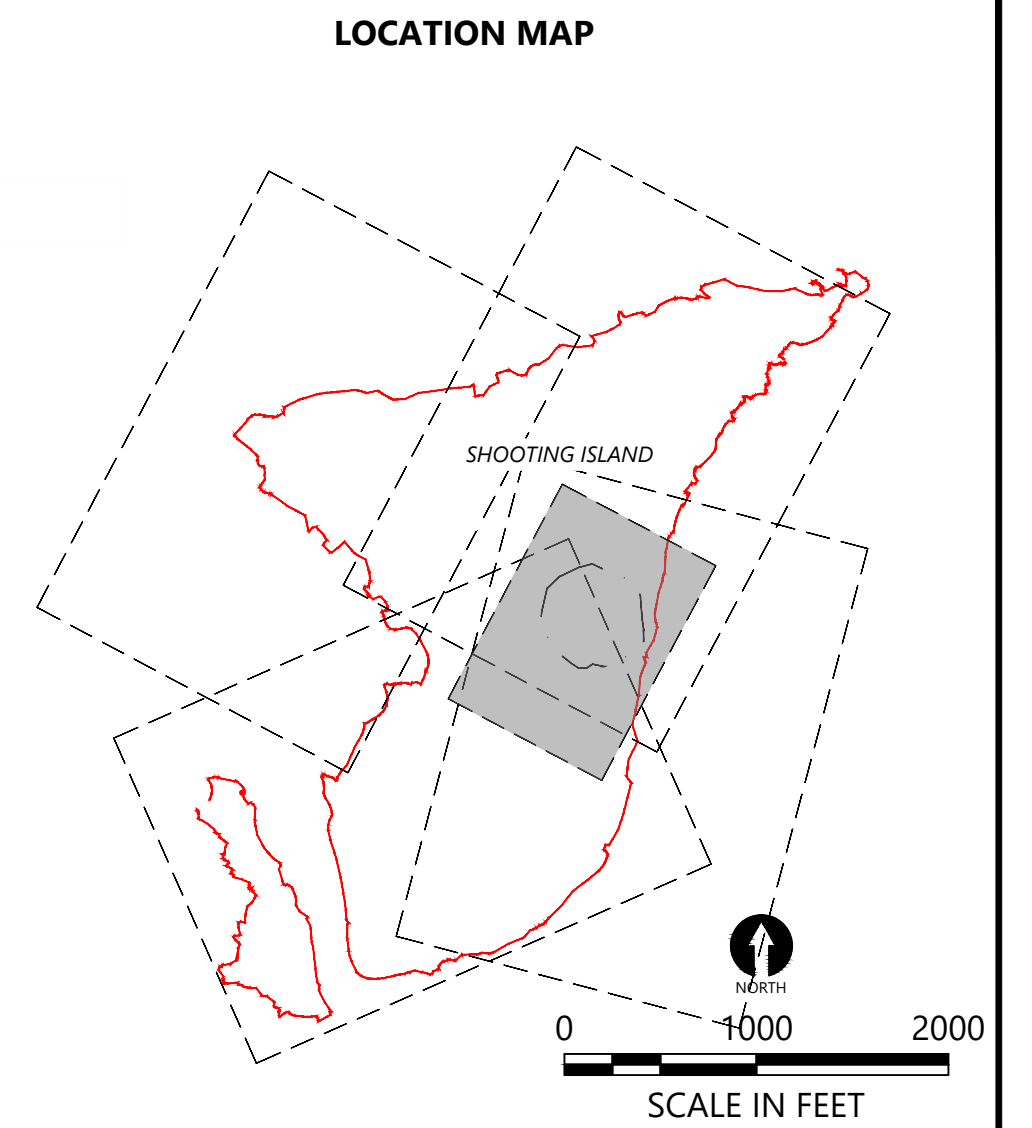
DESIGNED BY: S. BAGNULL
DRAWN BY: B. HURRY
CHECKED BY: T. MERRITTS
APPROVED BY: R. MOHAN
SCALE: AS NOTED
DATE: NOVEMBER 2019

**SHOOTING ISLAND HABITAT RESTORATION AND
COASTAL RESILIENCY PROJECT- PHASES 2, 3, AND 4
CITY OF OCEAN CITY, NJ**

**PHASE 3 - THIN LAYER PLACEMENT PLAN
CROSS SECTIONS (2 OF 2)**

C-15

SHEET NO. **18** OF **21**



LEGEND:

2017 SHORELINE

ABANDONED CDF APPROXIMATE LIMITS
OF REGRADING (PHASE 4)


NOTES:

1. PRIOR TO USE OF AREA, CONTRACTOR SHALL CLEAR AND PROPERLY DISPOSE OF INVASIVE VEGETATION AT APPROVED OFF-SITE FACILITY.
2. THE ABANDONED CDF AREA MAY BE UTILIZED BY THE CONTRACTOR FOR EQUIPMENT AND MATERIAL STAGING/STORAGE DURING IMPLEMENTATION, PRIOR TO THE START OF PHASE 4 OPERATIONS.

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HORIZONTAL DATUM: NEW JERSEY STATE PLANE, NAD83,
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AT FULL SIZE, IF NOT ONE
INCH SCALE ACCORDINGLY



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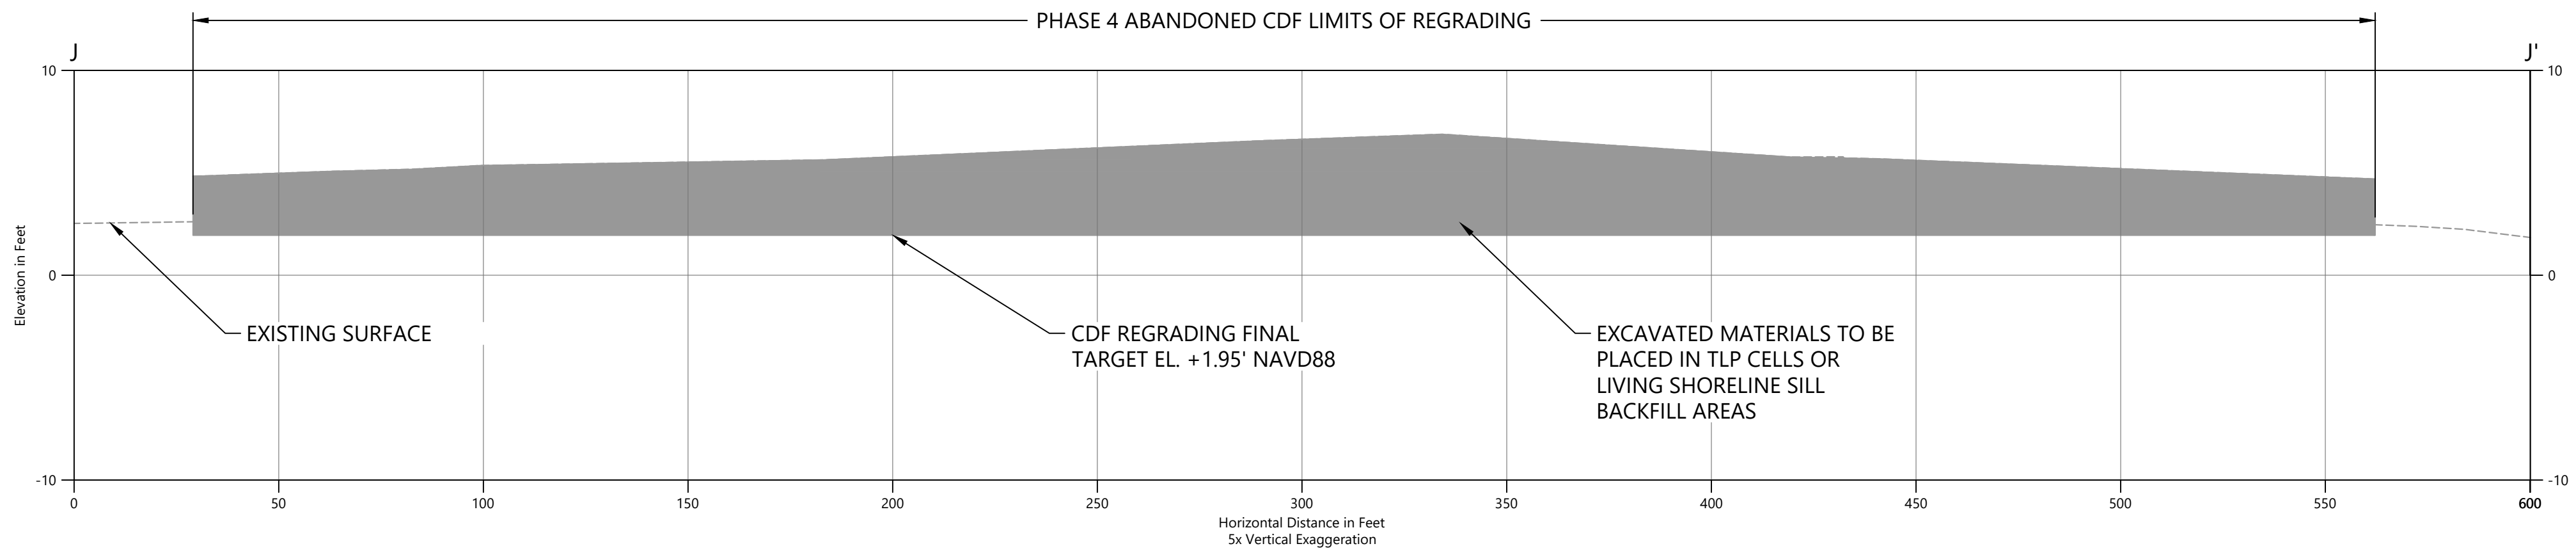
**SHOOTING ISLAND HABITAT RESTORATION AND
COASTAL RESILIENCY PROJECT- PHASES 2, 3, AND 4
CITY OF OCEAN CITY, NJ**

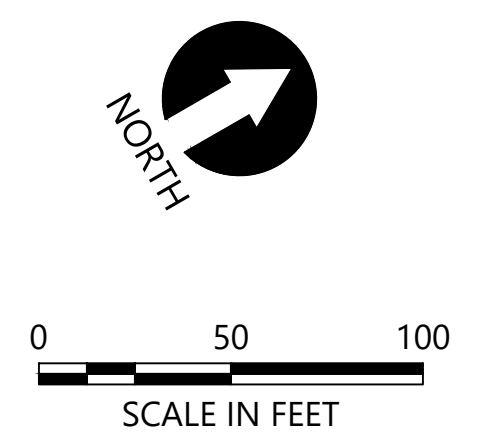PHASE 4 - CDF RESTORATION PLAN


C-16

SHEET NO. 19 OF 21

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J
SECTION
C-16
HORIZ. SCALE: 1" = 20'
VERT. SCALE: 1" = 4'



K
SECTION
C-16
HORIZ. SCALE: 1" = 20'
VERT. SCALE: 1" = 4'

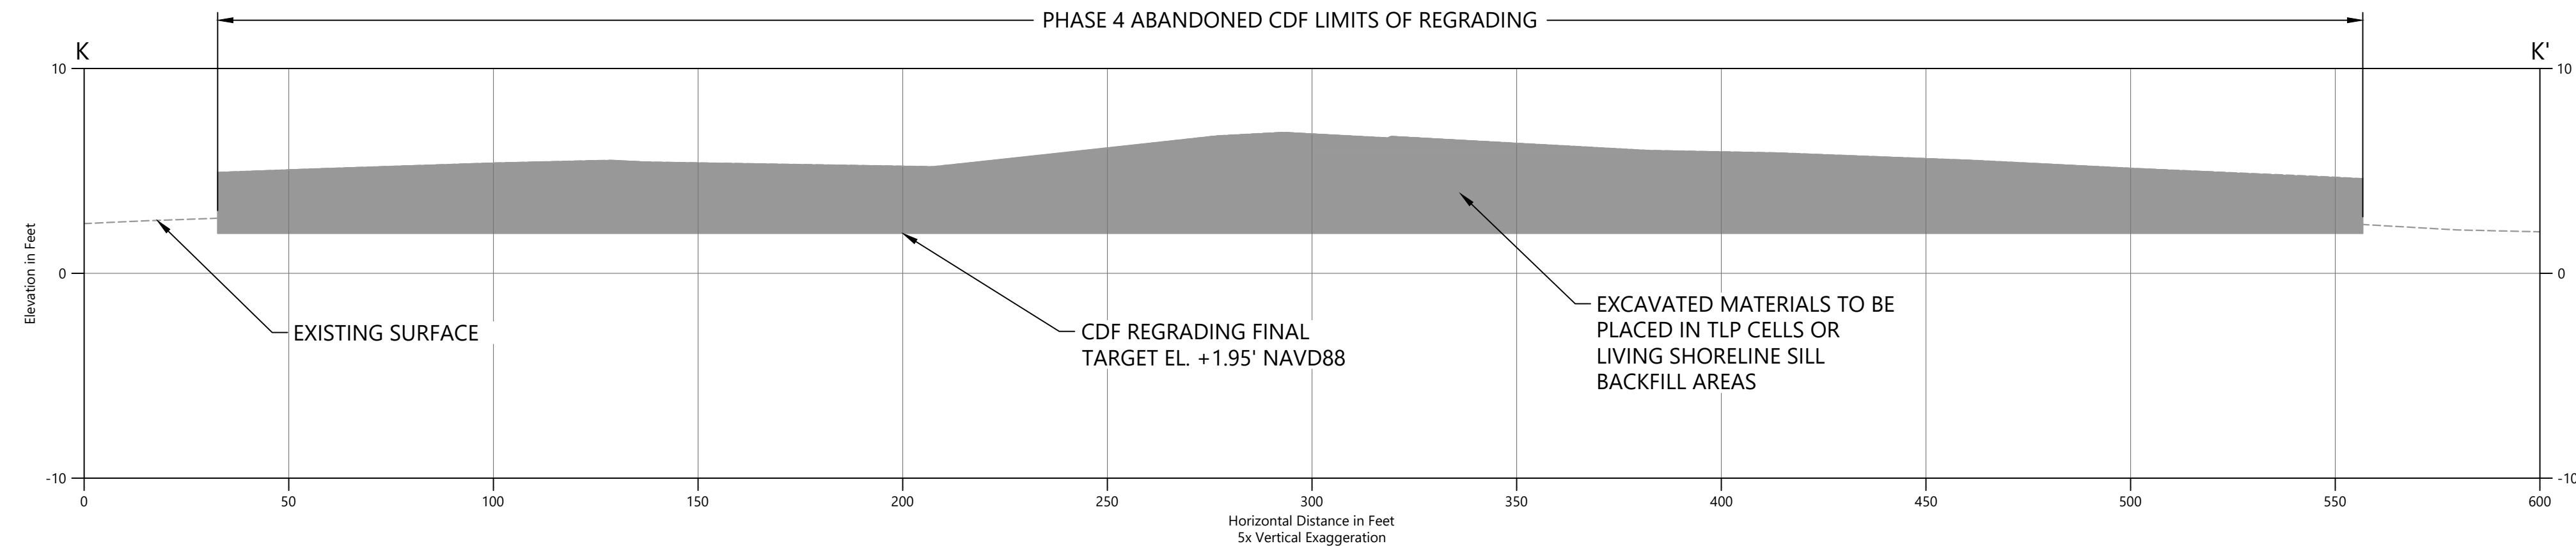ONE INCH
AT FULL SIZE, IF NOT ONE
INCH SCALE ACCORDINGLY



REVISIONS					
REV	DATE	BY	APP'D	DESCRIPTION	

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**SHOOTING ISLAND HABITAT RESTORATION AND
COASTAL RESILIENCY PROJECT- PHASES 2, 3, AND 4
CITY OF OCEAN CITY, NJ**

**PHASE 4 - CDF RESTORATION CROSS
SECTIONS**

C-17

SHEET NO. 20 OF 21

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Point Table		
Point #	Northing	Easting
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11	160949.97	462579.98
12	160944.42	462703.60
13	161012.93	462714.44
14	161053.17	462724.08
15	161061.16	462574.69
16	161093.09	462493.86

LOCATION MAP

LEGEND:

- 2017 SHORELINE
- THIN LAYER PLACEMENT CELL BOUNDARY
- ABANDONED CDF APPROXIMATE LIMITS OF REGRADING (PHASE 4)
- AUTHORIZED ON SHORE ACCESS FOOTPRINT. PROTECT EXISTING MARSH SURFACE
- AREA OF AUTHORIZED TEMPORARY PILING
- AREA OF AUTHORIZED ACCESS DREDGING TO -6' MLW
- CONTROL POINT

SOURCE: BASE LINE WORK PREPARED BY ACT ENGINEERS, INC. BASED ON FIELD SURVEY CONDUCTED ON FEBRUARY 14, 2017 THROUGH MARCH 1, 2017 AND SUPPLEMENTED WITH NEARSHORE TOPOGRAPHY COLLECTED ON JULY 27, 2017. ADDITIONAL TOPOGRAPHIC SURVEY CONDUCTED IN MAY AND AUGUST 2019 BY ACT ENGINEERS, INC.

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0 100 200
SCALE IN FEET

ONE INCH
AT FULL SIZE, IF NOT ONE
INCH SCALE ACCORDINGLY