

PREPARED BY <u>CENTURY</u> ■ ■ ■ ■ ENGINEERING A Kleinfelder Company THIS SEAL APPLIES TO ALL SHEETS BEARING THE "CE" SECTION DESIGNATION. SEAL PREPARED BY THIS SEAL APPLIES TO ALL SHEETS BEARING THE "GPI" SECTION DESIGNATION. SEAL PREPARED BY McCORMICK TAYLOR THIS SEAL APPLIES TO ALL SHEETS BEARING THE "McT" SECTION DESIGNATION. SEAL PREPARED BY THIS SEAL APPLIES TO ALL SHEETS BEARING THE "WM" SECTION DESIGNATION. SEAL PREPARED BY THIS SEAL APPLIES TO ALL SHEETS BEARING THE "RE" SECTION DESIGNATION.

SEAL

THE STATE OF DELAWARE DEPARTMENT OF TRANSPORTATION



FINAL PLANS

U.S. CUSTOMARY

UNITS


CONSTRUCTION PLANS FOR:

I-95 AND SR 896 INTERCHANGE

CONTRACT NUMBER: T201609002 FEDERAL AID PROJECT NUMBER: IM-N060(44)

COUNTY: NEW CASTLE

N056 M.R. #:

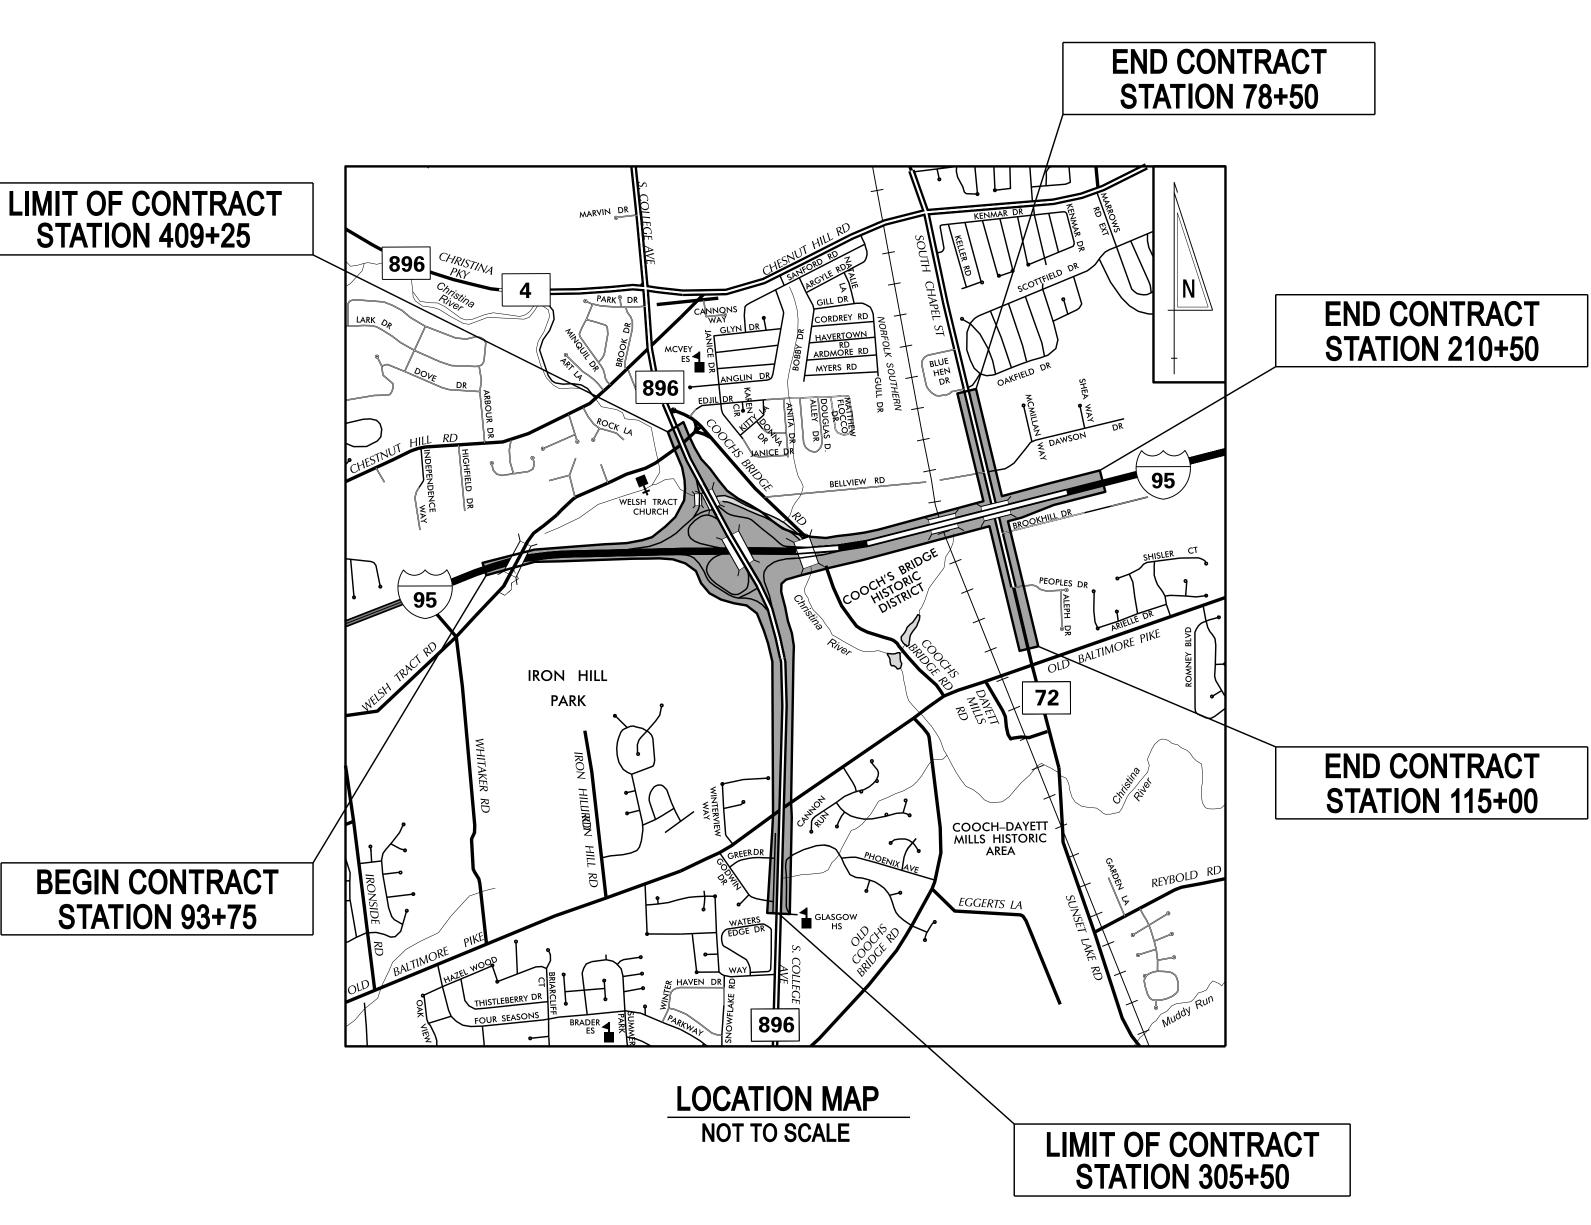


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	DE	SIGN DI	ESIGNATIO	N		
MRD #: N056		AD NAME: I-95	T			
FUNCTIONAL CLASS:			D.H.V. PROJECTI	·	YEAR:	2040
TYPE OF CONSTRUCT			DESIGN SPEED:	/0 M.P.H.		
A.A.D.T. CURRENT: A.A.D.T. PROJECTED		YEAR: 2016		ICTRIBUTION. FO 9/		
MRD #: N387	· · · · · · · · · · · · · · · · · · ·	YEAR: 2040	EGE AVENUE (SR 896)	ISTRIBUTION: 59 %		
FUNCTIONAL CLASS:				ID. 7 225	YEAR:	2040
TYPE OF CONSTRUCT			D.H.V. PROJECTI	55 M.P.H. / 40 M.P.H.	TEAK:	2040
A.A.D.T. CURRENT:		YEAR: 2016		33 M.P.H. / 40 M.P.H.		
A.A.D.T. PROJECTED	·			ISTRIBUTION: 62 %		
MRD #: 6011		AD NAME: RAMP A	DIRECTION OF E	1511(15011014) 02 //		
FUNCTIONAL CLASS:			D.H.V. PROJECTI	ED: 1.655	YEAR:	2040
TYPE OF CONSTRUCT			DESIGN SPEED:	·		
A.A.D.T. CURRENT:		YEAR: 2016	TRUCKS: 6 %			
A.A.D.T. PROJECTED		YEAR: 2040	DIRECTION OF D	ISTRIBUTION: N/A		
MRD #: 6018	RO	AD NAME: RAMP C		<u> </u>		
FUNCTIONAL CLASS:	INTERSTATE R	AMP	D.H.V. PROJECTI	ED: 2,255	YEAR:	2040
TYPE OF CONSTRUCT	TON: NEW CO	NSTRUCTION	DESIGN SPEED:	40 M.P.H.		
A.A.D.T. CURRENT:	13,995	YEAR: 2016	TRUCKS: 6 %			
A.A.D.T. PROJECTED	: 19,400	YEAR: 2040	DIRECTION OF D	ISTRIBUTION: N/A		
MRD #: 6017	RO	AD NAME: RAMP D				
FUNCTIONAL CLASS:	INTERSTATE R	AMP	D.H.V. PROJECTI	ED: 1,490	YEAR:	2040
TYPE OF CONSTRUCT	TON: NEW CO	NSTRUCTION	DESIGN SPEED:	50 M.P.H. / 35 M.P.H.		
A.A.D.T. CURRENT:	10,665	YEAR: 2016		·		
A.A.D.T. PROJECTED	<u> </u>			ISTRIBUTION: N/A		
MRD #: 6015						
FUNCTIONAL CLASS:			D.H.V. PROJECTI	ED: 290	YEAR:	2040
TYPE OF CONSTRUCT	TON: NEW CO	NSTRUCTION	DESIGN SPEED:	35 M.P.H.		
A.A.D.T. CURRENT:	2,015	YEAR: 2016	TRUCKS: 11 %			
A.A.D.T. PROJECTED	: 3,225	YEAR: 2040	DIRECTION OF D	ISTRIBUTION: N/A		
MRD #: 6013 & 601	6 RO	AD NAME: RAMP H	/I			
FUNCTIONAL CLASS:	INTERSTATE R	AMP	D.H.V. PROJECTI	ED: 250	YEAR:	2040
TYPE OF CONSTRUCT	TON: NEW CO	NSTRUCTION	DESIGN SPEED:	35 M.P.H.		
A.A.D.T. CURRENT:	1,460	YEAR: 2016	TRUCKS: 11 %			
A.A.D.T. PROJECTED	: 2,770	YEAR: 2040	DIRECTION OF D	ISTRIBUTION: N/A		
MRD #: 6012	RO	AD NAME: RAMP J				
FUNCTIONAL CLASS:	INTERSTATE R	AMP	D.H.V. PROJECTI	ED: 2,510	YEAR:	2040
TYPE OF CONSTRUCT	TON: NEW CO	NSTRUCTION	DESIGN SPEED:	40 M.P.H.		
A.A.D.T. CURRENT:	15,980	YEAR: 2016	TRUCKS: 6 %			
A.A.D.T. PROJECTED	: 22,050	YEAR: 2040	DIRECTION OF D	ISTRIBUTION: N/A		
MRD #: 0356	RO	AD NAME: SR 72				
FUNCTIONAL CLASS:	URBAN ARTER	IAL	D.H.V. PROJECTI	ED: 3,300	YEAR:	2040
TYPE OF CONSTRUCT	ION: RECONS	TRUCTION	DESIGN SPEED:	50 M.P.H.		
A.A.D.T. CURRENT:	30,800	YEAR: 2020	TRUCKS: 9 %			
A.A.D.T. PROJECTED	: 34,000	YEAR: 2040	DIRECTION OF D	ISTRIBUTION: 57 %		
Al	PPROV	ED DES	IGN EXCEF	PTIONS		
	PARAMETER		REQUIRED	PROVIDED	Т р	ATE
<u> </u>	TATOUNETER		TEGOTILES.	TROVIDED		
			PE\ // 4:4:4:	10	1	
	AD[JENDA/	REVISION	NS		
	1994	CIATER	CONTRAC	?TS		
OONTD 4 OT 110	700					
CONTRACT NO.			CONTRACT NAM			
7228	DELAWARE T	URNPIKE WIDENING	S AND IMPROVEMENT PRO	OGRAM ROUTE 896		
I-1(41)	INTERSTATE I	HIGHWAY ROUTE F.	A.II DELAWARE TURNPIK	Œ		

87-108-02 SR 896, I-95 TO SR 4 87-108-03 SR 896, NORTH OF 40 TO I-95 83-103-02 SR 72, (OLD BALTIMORE PIKE TO S.R. 4) 92-061-09CP RD. 367 WELSH TRACT ROAD FROM I-95 TO SOUTH COLLEGE ROAD 96-09-001 I-95 TOLL PLAZA REHABILITATION 20-015-03 SR 72 BIKEWAY EXTENSION, DAYETT MILLS TO I-95 T201207402 INTERSTATE BRIDGE MAINTENANCE, SOUTH

APPROVED FOR ADVERTISEMENT

DIRECTOR OF TRANSPORTATION SOLUTIONS DATE

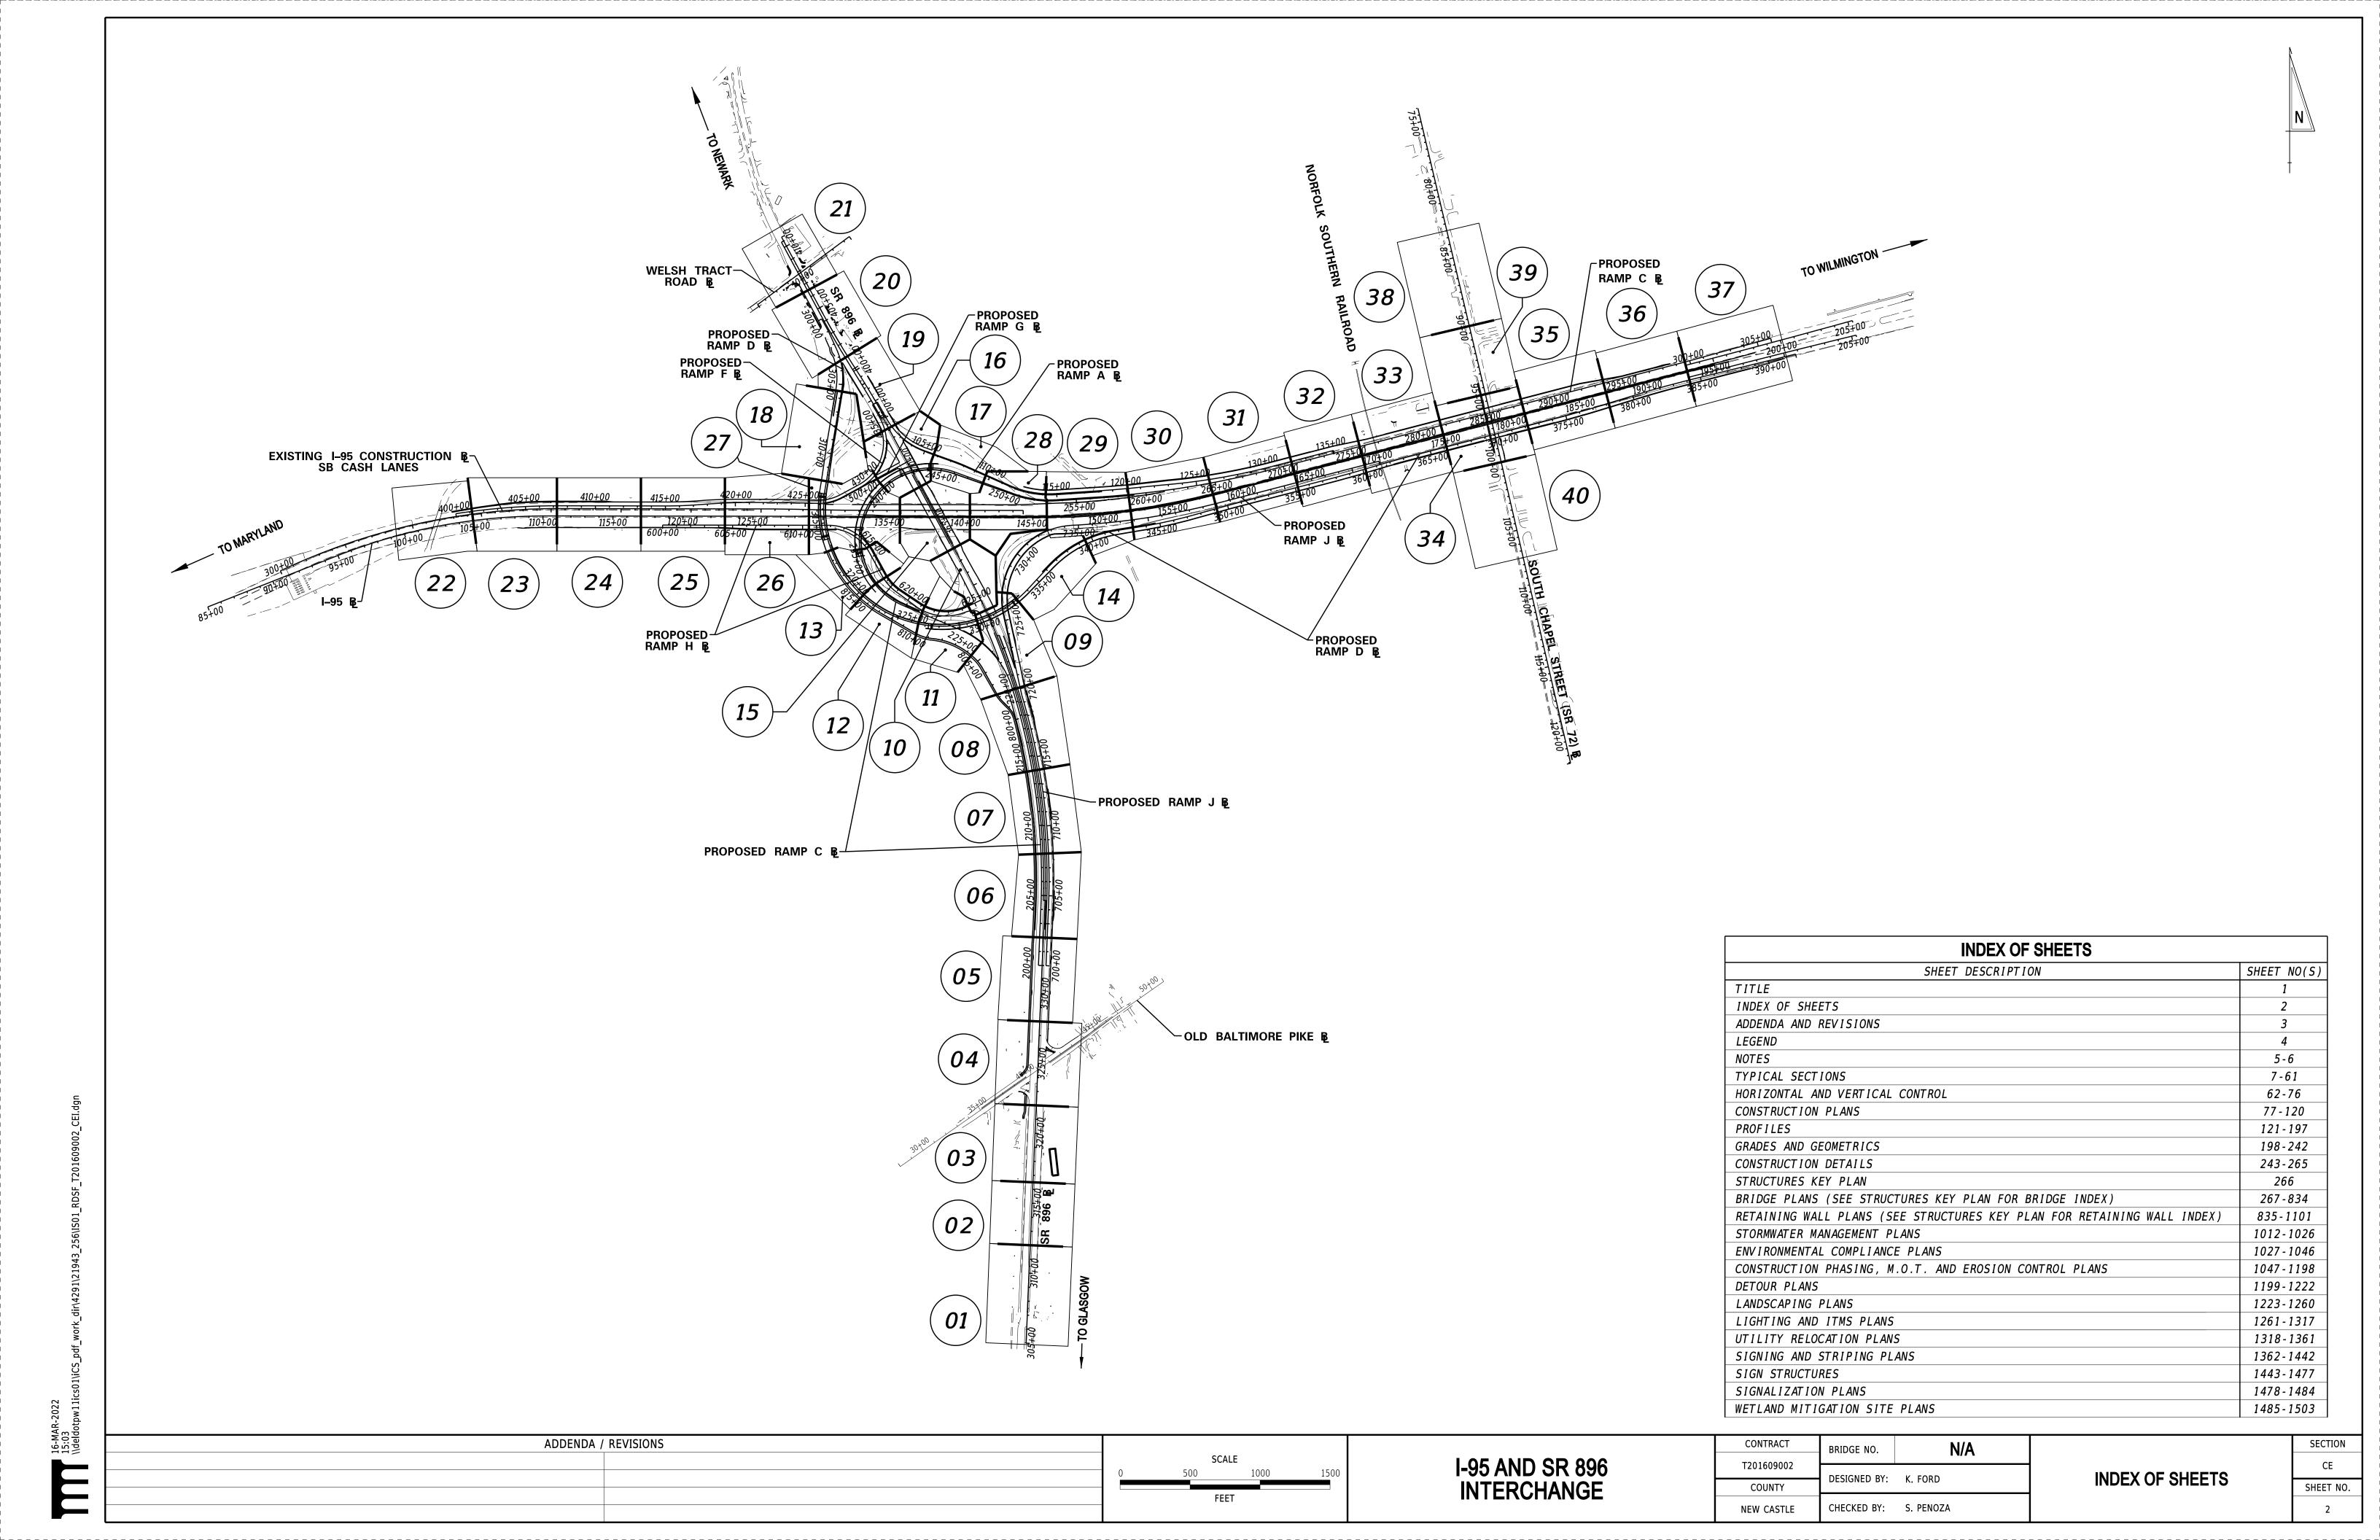

ADDENDA / REVISIONS I-95 AND SR 896 INTERCHANGE NOT TO SCALE

CONTRACT N/A BRIDGE NO. T201609002 DESIGNED BY: K. FORD COUNTY CHECKED BY: S. PENOZA NEW CASTLE

ADDENDA AND REVISIONS

SECTION

SHEET NO.

MANMADE ROADSIDE FEATURES	
©	BOLLARD - STEEL POLE
\boxtimes	BOLLARD - WOOD POST
(TYPE LABEL)	CURB
(TYPE LABEL)	CURB AND GUTTER
x	FENCE - CHAINLINK OR STRANDED
	FENCE - STOCKADE OR SPLIT RAIL
F.P. ⊕	FLAG POLE
_n	GUARDRAIL - STEEL BEAM
	GUARDRAIL - WIRE ROPE
LAMP ⊚	LAMP AND POST - RESIDENTIAL
МВ П	MAILBOX
P.M.	PARKING METER AND POST
	PAVEMENT - FLEXIBLE
	PAVEMENT - RIGID
	PILE - BRIDGE
0	PILLAR OR MISCELLANEOUS POST
7	TRAFFIC SIGN AND POST
0000	WALL - BRICK OR BLOCK
90999·	WALL - STONE

NATURAL ROADSIDE FEATURES	
######################################	HEDGEROW OR THICKET
	MARSH BOUNDARY LINE
X	TREE - CONIFEROUS
	TREE - DECIDUOUS
Д	TREE STUMP
(2)	SHRUBBERY
WL	DELINEATED WETLAND BOUNDARY LINE
	WOODS LINE BOUNDARY

RIGHT-OF-WAY SYMBOLS		
PROPERTY MARKER - CONCRETE MON.		
PROPERTY MARKER - IRON PIPE		
HISTORIC RIGHT-OF-WAY BASELINE		
EXISTING RIGHT-OF-WAY		
EXISTING PROPERTY LINE		
EXISTING EASEMENT		
EXISTING DENIAL OF ACCESS		
EXISTING R/W & DENIAL OF ACCESS		

SURVEY CONTROL & MONUMENTATION B.M. SURVEY BENCHMARK LOCATION SURVEY NGS POINT LOCATION T.P. SURVEY TIE POINT LOCATION SURVEY TRAVERSE POINT POINT OF CURVATURE OR TANGENCY

POINT OF INTERSECTING TANGENTS

0

UTILITY		
•	SOIL BORING LOCATION	
•	UTILITY TEST HOLE LOCATION	
TV	CABLE TV DISTRIBUTION BOX	
Ē	ELECTRIC MANHOLE	
EM	ELECTRIC METER	
E	ELECTRIC TRANSFORMER	
<u> </u>	POLE MOUNTED LUMINAIRE	
G	GAS MANHOLE	
G.M.	GAS METER	
G.V.	GAS VALVE	
G.P.	GAS PUMP - SERVICE STATION	
	RAILROAD TRACKS	
(\$)	SANITARY SEWER MANHOLE	
S.V.	SANITARY SEWER VALVE	
S.C.O.	SANITARY SEWER CLEANOUT OR VENT	
S.D.F.	SEPTIC DRAIN FIELD	
В	TELEPHONE BOOTH	
Ī	TELEPHONE MANHOLE	
Т	TELEPHONE TEST POINT	
J.W.	TRAFFIC - CONDUIT JUNCTION WELL	
(0)	TRAFFIC - LIGHT POLE AND BASE	
	TRAFFIC - PEDESTRIAN POLE & BASE	
, , , , , , , , , , , , , , , , , , ,	TRAFFIC - SIGNAL CABINET & BASE	
8	TRAFFIC - SIGNAL POLE AND BASE	
U	UTILITY BOX	
0->	UTILITY POLE GUY WIRE ANCHOR	
Ø	UTILITY POLE	
F.H.	WATER - FIRE HYDRANT	
W.M.	WATER METER	
WV °	WATER VALVE	
WELL	WELL HEAD	
?	MANHOLE - UNDETERMINED OWNER	

——————————————————————————————————————	CITY OF NEWARK - SEWER
CN-W (X)	CITY OF NEWARK - WATER
——————————————————————————————————————	CITY OF NEWARK - ELECTRIC
——— DP-E (X) ———	DELMARVA POWER - ELECTRIC
——————————————————————————————————————	DELMARVA POWER - GAS
—— NCC-S (X) ——	NEW CASTLE COUNTY - SEWER
—— SZ-W (X) ———	SUEZ - WATER
— DOT-EX-E (X) ——	DELDOT - ELECTRIC
— DOT-EX-FO (X) — ITMS(D)	DELDOT - FIBER OPTIC

	CONSTRUCTION
	CONCRETE SAFETY BARRIER - PERMANENT
×——BFS——×	BIOFILTRATION SWALE
	BRICK PATTERNED SURFACE
	BUTT JOINT
CZ	CLEAR ZONE
100+00	CONSTRUCTION BASELINE
	CURB, TYPE 1 & TYPE 3
	CURB, TYPE 2
	CURB & GUTTER, TYPE 1
	CURB & GUTTER, TYPE 2
	CURB & GUTTER, TYPE 3
	CURB & GUTTER, TYPE 4
4	CURB OPENING - SUMP / ON GRADE
	CURB OPENING WITH SIDEWALK
	DRAINAGE INLET
××	DITCH
>	FENCE - METAL / FENCE - WOOD
	FLARED END / SAFETY END SECTION
	GUARDRAIL, TYPE 1
<u> </u>	GUARDRAIL, TYPE 2
<u> </u>	GUARDRAIL, TYPE 3
Cn ñ ñ	GUARDRAIL END ANCHORAGE
	GUARDRAIL END TREATMENT, TYPE 1
	GUARDRAIL END TREATMENT, TYPE 2
	GUARDRAIL END TREATMENT, TYPE 3
	IMPACT ATTENUATOR
	JUNCTION BOX - DRAINAGE
	LATERAL OFFSET
LOC	LIMIT OF CONSTRUCTION
<i>MB</i> ■	MAILBOX
•	MANHOLE
	PAVEMENT PATCH
	PAVEMENT REMOVAL - TOPSOIL, SEED AND MULCH
	PIPE & DIRECTIONAL FLOW ARROW
7550 0000 0000 0000 00000	RIPRAP
	P.C.C. SIDEWALK - 4"
	RETAINING WALL

PROPOSED SYMBOLS

	P.C.C. SIDEWALK - 6" (USE 8" DEPTH FOR CHANNELIZATION ISLANDS.)
	UNDERDRAIN
	UNDERDRAIN OUTLET
	RIGHT-OF-WAY SYMBOLS
©	PROPOSED RIGHT-OF-WAY MONUMENT
——————————————————————————————————————	PROPOSED DENIAL OF ACCESS
PE	PROPOSED PERMANENT EASEMENT
R/W	PROPOSED RIGHT-OF-WAY
R/W-DA	PROPOSED R/W & DENIAL OF ACCESS
RTE	RIGHT-TO-ENTER
	TEMPORARY CONSTRUCTION EASEMENT
100+00	PROPOSED RIGHT-OF-WAY BASELINE

100+00	PROPOSED RIGHT-OF-WAY BASELINE	
IDENTIFIERS		
(AB)	ABANDON BY CONTRACTOR	
(AB)	ABANDON BY OTHERS	
$\frac{A}{C}$	ADJUST BY CONTRACTOR	
A	ADJUST BY OTHERS	
BMP	BEST MANAGEMENT PRACTICE	
BSP X	BUS STOP PAD / TYPE	
BSSP	BUS STOP WITH SHELTER PAD / TYPE	
B	CONCRETE SAFETY BARRIER	
C	CURB OR CURB & GUTTER	
CJB	CONVERT TO JUNCTION BOX	
CMH XXX	CONVERT TO DRAINAGE MANHOLE	
xxx)	CURB OPENING - SUMP / ON GRADE	
CO	CURB OPENING WITH SIDEWALK	
SW		
XXX	DRAINAGE INLET	
(DND)	DO NOT DISTURB	
XXX	ENERGY DISSIPATOR	
XXX	FENCE	
(FES XXX)	FLARED END SECTION	
C C C C C C C C C C C C C C C C C C C	FILL WITH FLOWABLE FILL	
GR	GUARDRAIL	
JB XXX	JUNCTION BOX	
MH	MANHOLE	
M XXX	MONUMENT - RIGHT-OF-WAY	
PC	PEDESTRIAN CONNECTION / TYPE	
PC-N XXX	PEDESTRIAN CONNECTION / TYPE WITHOUT SIDEWALK SURFACE DETECTABLE WARNING SYSTEM	
PXXX	PIPE	
RL C	RELOCATE BY CONTRACTOR	
RL 0	RELOCATE BY OTHERS	
RL PO	RELOCATE BY PROPERTY OWNER	
(RM)	REMOVE BY CONTRACTOR	
(RM)	REMOVE BY TRAFFIC CONTRACTOR	
(RM)	REMOVE BY OTHERS	
SES XXX	SAFETY END SECTION	
UD XXX	UNDERDRAIN / LENGTH	
UDO XXX	UNDERDRAIN OUTLET PIPE	
RR	RIPRAP	
XXX		

LANDSCAPING		
LS	LANDSCAPE PLANTINGS	
٤	SHRUBBERY	
\otimes	CONIFEROUS TREE	
$\overline{}$	DECIDUOUS TREE	

TRAFFIC		
ITMS CONDUIT		
SIGNAL CONDUIT		
CONDUIT JUNCTION WELL		
LUMINAIRE		
PAVEMENT MARKINGS		
PAVEMENT STRIPING		
TRAFFIC SIGN		

PAVEMENT SECTION(S)		
	MILL AND OVERLAY PAVEMENT - SEE TYPICAL SECTIONS FOR MATERIALS AND DEPTHS	
	RECONSTRUCTED PAVEMENT - SEE TYPICAL SECTIONS FOR MATERIALS AND DEPTHS	
	DRIVEWAY AND ENTRANCE PAVEMENT - SEE NOTES FOR MATERIALS AND DEPTHS	

	UTILITIES					
F.H.	PROPOSED FIRE HYDRANT					
•	PROPOSED GUY WIRE ANCHOR					
``	PROPOSED UTILITY POLE					
M.H. •	PROPOSED MANHOLE					
₩. V.	PROPOSED WATER VALVE					
———DE-P ———	DELMARVA POWER - ELECTRIC					
ITMS	DELDOT - ITMS COMMUNICATION CONDUIT					
——————————————————————————————————————	DELDOT - LIGHTING SERVICE RUN CONDUIT					
—— E ——	DELDOT - ELECTRIC					
—— G ——	DELMARVA POWER - GAS					
ES-F0	EVERSTREAM - FIBER					
SZ-W	SUEZ - WATER					

MISCELLANEOUS					
	UTILITY TURF TRAIL				
	STORMWATER MAINTENANCE ACCESS ROAD				

ADDENDA / REVISIONS

I-95 AND SR 896 INTERCHANGE CONTRACT
BRIDGE NO.

T201609002

COUNTY

NEW CASTLE

CHECKED BY: S. PENOZA

LEGEND CE
SHEET NO.

GENERAL NOTES

- 1. THIS PROJECT IS TO BE CONSTRUCTED IN ACCORDANCE WITH THE DELAWARE DEPARTMENT OF TRANSPORTATION "STANDARD SPECIFICATIONS", DATED JUNE 2021 AND THE DELAWARE DEPARTMENT OF TRANSPORTATION "STANDARD CONSTRUCTION DETAILS", DATED 2021.
- 2. ELECTRONIC DESIGN DATA FILES THAT WILL BE MADE AVAILABLE TO THE AWARDED CONTRACTOR. INCLUDE:

()	NONE
(X)	ASCII DATA FILES WITH COORDINATES AND ELEVATIONS FOR PROPOSED POINTS AS SELECTED BY THE ENGINEER.
(X)	EXISTING DIGITAL TERRAIN MODEL, IN .DTM FILE FORMAT, COMPATIBLE WITH SOFTWARE CURRENTLY USED BY DELDOT.
(X)	PROPOSED DIGITAL TERRAIN MODEL, IN .DTM FILE FORMAT, COMPATIBLE WITH SOFTWARE CURRENTLY USED BY DELDOT.
(X)	DESIGN FILE, IN .DGN FILE FORMAT, THAT CONTAINS 3D FEATURE LINES FOR THE PROPOSED DESIGN. 3D FEATURE LINES ARE FOR THE PROPOSED TOP SURFACE ELEVATION ONLY.

NOTE: THE DOCUMENT ENTITLED "RELEASE FOR DELIVERY OF DOCUMENTS IN ELECTRONIC FORM TO A CONTRACTOR" MUST BE SIGNED BY ALL PARTIES PRIOR TO THE DELIVERY OF ANY ELECTRONIC PROJECT FILES.

NOTE: THERE MAY BE SOME AREAS OF THE PROJECT NOT INCLUDED IN THE ELECTRONIC DESIGN DATA FILE(S). IT IS THE CONTRACTOR'S RESPONSIBILITY TO REVIEW THE DESIGN DATA FILE AND DETERMINE THE LIMITS OF THE PROJECT INCLUDED.

3. PROJECT FILES THAT WILL BE MADE AVAILABLE TO THE CONTRACTOR, INCLUDE:

(X)	CROSS SECTIONS
(X)	RIGHT-OF-WAY PLANS (WILL BE MADE AVAILABLE TO THE AWARDED CONTRACTOR)

ADDENDA / REVISIONS

PROJECT NOTES

SECTION 100

- ANY DAMAGE TO ITEMS NOTED TO BE RELOCATED OR RESET BY THE CONTRACTOR, AT THE DISCRETION OF THE ENGINEER, SHALL BE REPAIRED AND/OR REPLACED IN KIND AT THE CONTRACTOR'S EXPENSE.
- 2. THE CONTRACTOR WILL CONTACT THE DELAWARE TMC AT 302-659-4600 PRIOR TO ANY UNMANNED AIRCRAFT VEHICLE (UAV)
 FLIGHTS. THE CONTRACTOR WILL BE REQUIRED TO PROVIDE THE FOLLOWING INFORMATION: THE REGISTRATION NUMBER OF THE
 UAV, THE FLIGHT TIME, LOCATION OF THE FLIGHT, THE PILOT'S NAME AND THE PILOT'S CONTACT NUMBER DURING THE FLIGHT.
- 3. DELETE STANDARD SPEC 104.9 AND REPLACE WITH: THE CONTRACTOR, WITH THE APPROVAL OF THE ENGINEER, SHALL BE DIRECTED TO USE MATERIALS, AS MAY BE FOUND IN THE EXCAVATIONS, THAT ARE DETERMINED TO BE SUITABLE BY THE ENGINEER FOR USE IN AREAS REQUIRING BORROW TYPES A, B, C, OR F ELSEWHERE WITHIN THE PROJECT LIMITS. PAYMENT FOR PLACING THESE MATERIALS AT LOCATIONS AS DIRECTED BY THE ENGINEER SHALL BE INCIDENTAL TO THE ITEM THAT GENERATED THE MATERIAL. IT SHALL BE THE RESPONSIBILITY OF THE CONTRACTOR TO DRY OR WET THE MATERIALS, IF NEEDED, SO THAT THE MATERIALS WILL MEET THE REQUIREMENTS OF ITS INTENDED USE. THE CONTRACTOR MAY, WITH THE APPROVAL OF THE ENGINEER, STOCKPILE MATERIALS TO MEET THESE REQUIREMENTS, HOWEVER, MOVING THE MATERIAL FROM THE STOCKPILE AND THEN UTILIZING THE MATERIAL SHALL NOT BE MEASURED FOR PAYMENT. ALL MATERIALS ENCOUNTERED IN THE EXCAVATIONS OF THE PROJECT THAT ARE NOT USED ELSEWHERE ON THE PROJECT SHALL BE REMOVED AND DISPOSED OF BY THE CONTRACTOR. ALL COSTS ASSOCIATED WITH STOCKPILING THE MATERIAL, MOVING ANY MATERIALS FROM ANY STOCKPILES, WETTING AND/OR DRYING THE MATERIAL, OR REMOVAL AND FINAL DISPOSAL SHALL BE INCIDENTAL TO THE ITEM THAT GENERATED THE MATERIAL.

SECTION 200

- I. ITEMS TO BE REMOVED UNDER ITEM 211000 REMOVAL OF STRUCTURES AND OBSTRUCTIONS SHALL INCLUDE (UNLESS INDICATED ON THE PLANS AS DO NOT DISTURB), BUT NOT BE LIMITED TO THE FOLLOWING: SIGN STRUCTURES AND FOUNDATIONS, TRAFFIC STRUCTURES AND FOUNDATIONS, JUNCTION WELLS, CONDUIT, WIRE, CABINET BASES, LIGHT POLES AND FOUNDATIONS, ABANDONED SIGNAL POLES AND BASES, DRAINAGE INLETS, PIPES, MANHOLES, HEADWALLS, UNDERDRAINS, FLARED END SECTIONS, RIPRAP, PERMANENT BARRIER, AND UTILITY POLES. PARTIAL FOUNDATION REMOVAL IS ACCEPTABLE IF THE CONCRETE IS REMOVED TO A DEPTH OF AT LEAST ONE FOOT BELOW THE ROADWAY BOX WHEN LOCATED WITHIN A PROPOSED ROADWAY AREA. COST OF REMOVAL OF EXISTING TRAFFIC ITEMS SHALL BE INCLUDED IN THE LUMP SUM PRICE BID PRICE FOR ITEM 211000, REMOVAL OF STRUCTURES AND OBSTRUCTIONS. GUARDRAIL AND FENCE ITEMS ARE TO BE REMOVED UNDER ITEM 211002 REMOVAL OF GUARDRAIL AND FENCE, UNLESS OTHERWISE INDICATED ON THE PLANS AS DO NOT DISTURB.
- THE CONTRACTOR MAY ENCOUNTER RECESSED/RAISED PAVEMENT MARKERS (RPMS) IN EXISTING PAVEMENT THAT IS SPECIFIED TO BE OVERLAID, MILLED, EXCAVATED, OR OTHERWISE REMOVED. IN ALL OF THESE CASES, THE EXISTING RPM HOUSINGS AND/OR THE RPM LENSES SHALL BE REMOVED AS INDICATED ON THE PLANS AND DISPOSED OF BY THE CONTRACTOR. PAYMENT WILL BE MADE UNDER ITEMS 817029 AND 817030 AS APPLICABLE. IF THE LENSES AND HOUSING ARE REMOVED AS ONE OPERATION, PAYMENT FOR REMOVAL OF THE ENTIRE RPM AND LENSES WILL BE MADE ONLY UNDER ITEM 817030.
- 6. UNSUITABLE MATERIALS FROM ROADWAY AND UNDERCUT EXCAVATION SHALL NOT BE USED AS FILL AND SHALL BE DISPOSED OF OUTSIDE THE PROJECT AREA. ALL COSTS INCIDENTAL TO THE ITEM BEING REMOVED.
- 7. WHEN A PIPE IS TO BE PLACED EITHER PARTIALLY OR COMPLETELY IN A FILL, THE EMBANKMENT SHALL BE COMPACTED TO AN ELEVATION OF 12" PLUS THE OUTSIDE DIAMETER OF THE PIPE ABOVE THE DESIGN INVERT OF THE PIPE FOR A MINIMUM OF TWO PIPE DIAMETERS ON EACH SIDE OF THE CENTERLINE OF THE PIPE. THE TRENCH SHALL THEN BE EXCAVATED AND PAID FOR, AS SPECIFIED IN SUBSECTIONS 207.3 AND 207.4.
- 8. SR 273 STOCKPILE PROPER EROSION AND SEDIMENT CONTROL MEASURES AS DETERMINED BY THE ENGINEER SHALL BE INSTALLED AND PAID BY THE RESPECTIVE BID ITEMS. EXCAVATED STOCKPILE MATERIAL, MEETING BORROW TYPE F REQUIREMENTS, SHALL BE USED WHERE ITEM #209006 BORROW, TYPE F HAS BEEN CALLED OUT IN THE PLANS. COSTS TO EXCAVATE, HAUL, DRY, WET, DOUBLE HANDLE, ETC. ARE INCIDENTAL TO THE MATERIAL BE PLACED AND PAID AS ITEM #209006 BORROW, TYPE F. ALL AREAS USED BY THE CONTRACTOR FOR HANDLING THE SR273 STOCKPILE MATERIAL SHALL BE FULLY RESTORED BY THE CONTRACTOR UPON THE FINAL REMOVAL OF ALL MATERIAL AVAILABLE FOR EMBANKMENT TO THE SATISFACTION OF THE ENGINEER. THE SR 273 STOCKPILE AREA SHALL BE RE-GRADED, TOPSOILED, SEEDED AND MULCHED IN ACCORDANCE WITH DELAWARE STANDARD SPECIFICATIONS. ALL COSTS ASSOCIATED WITH RESTORATION OF THE SR 273 STOCKPILE AREA SHALL BE PAID BY THE RESPECTIVE BID ITEMS. TRAFFIC CONTROL DEVICES SHALL BE APPROVED BY THE ENGINEER AND PAID BY THE RESPECTIVE TRAFFIC CONTROL ITEM.
- ITEM 211002, GUARDRAIL REMOVAL, WILL INCLUDE REMOVAL AND DISPOSAL OF STANDARD GUARDRAIL, IMPACT ATTENUATORS, END ANCHORAGES, AND BRIDGE CONNECTIONS. MEASUREMENT WILL BE MADE ALONG THE LENGTH OF THE RAIL ELEMENT FOR ALL ITEMS REMOVED. PAYMENT INCLUDES REMOVAL AND DISPOSAL OF RAIL, POSTS, HARDWARE, ANCHOR BOLTS, AND CONCRETE ANCHORS.
- 10. BORROW REQUIRED FOR HAUL ROAD CONSTRUCTION WILL BE MEASURED AND PAID FOR UNDER ITEM 202000 (IF ONSITE MATERIAL IS USED) OR ITEM 209006 (IF IMPORTED MATERIAL IS REQUIRED). ANY REQUIRED ROADWAY MATERIALS SUCH AS GABC WILL BE INCIDENTAL TO THE HAUL ROAD CONSTRUCTION. EROSION CONTROL STABILIZATION MEASURES WILL BE PAID FOR UNDER THEIR RESPECTIVE ITEMS. REMOVAL AND FINAL GRADING OF THE HAUL ROAD AND ALL RELATED MATERIALS WHEN NO LONGER NEEDED IS INCIDENTAL TO ITEM 202000 AND WILL NOT BE MEASURED FOR PAYMENT.
- 11. WHERE INDICATED ON THE PLANS, EXCAVATE EXISTING RIP RAP. PAYMENT TO BE MADE UNDER ITEM 202000. SALVAGE AND STOCKPILE THE EXISTING RIP RAP FOR LATER USE ON THE PROJECT. PAYMENT WILL BE MADE UNDER THE APPLICABLE NEW RIP RAP ITEM WHEN THE MATERIAL IS PLACED IN ITS FINAL POSITION. EXISTING RIP RAP DETERMINED TO BE UNSUITABLE FOR RE-USE SHALL BE REMOVED AND DISPOSED OF WITH PAYMENT INCIDENTAL TO ITEM 202000.

SECTION 300

12. PLACE MATERIALS FOR GABC (CRUSHED STONE, ASPHALT MILLINGS, OR RECYCLED CONCRETE) CONTINUOUSLY FOR THE FULL PAVEMENT BOX WIDTH. LONGITUDINAL JOINTS CONSTRUCTED OF NON-MATCHING MATERIALS ARE NOT PERMITTED. TRANSVERSE JOINTS ARE PERMITTED WHERE MATERIAL TYPES CHANGE. NO MIXING OF DIFFERENT MATERIALS WITHIN THE SAME AREA IS PERMITTED.

SECTION 400

- 13. THE PAVEMENT SECTION FOR COMMERCIAL ENTRANCES ALONG SR 896 SHALL BE 2" ITEM 401029 SUPERPAVE TYPE C, PG 64-22, PATCHING OVER 3" ITEM 401030 SUPERPAVE TYPE B, PG 64-22, PATCHING OVER 8" ITEM 301002 GRADED AGGREGATE BASE COURSE, TYPE B, PATCHING.
- 14. ITEM 403000 (TRM) SHALL BE USED ONLY FOR MINOR REPAIRS TO ROADWAYS OR PAVED DRIVEWAYS ALREADY UNDER TRAFFIC.
 TRM SHALL NOT BE USED FOR CONSTRUCTION OF TEMPORARY ROADWAYS OR RAMPS INCLUDED IN THE CONSTRUCTION
 PHASING PLANS.

SECTION 500

- 15. THE CONTRACTOR IS RESPONSIBLE FOR PROVIDING STABILIZING BASE MATERIAL UNDER THE CONCRETE PAVER TRACKS WHEN PLACING CONCRETE FOR SHOULDERS, OUTERMOST TURNING LANES, OR RAMPS WHERE THE DESIGNED ROAD BOX TERMINATES AT THE PAVEMENT EDGE. COSTS FOR STABILIZING THE BASE OUTSIDE THE DESIGNED PAVEMENT BOX ARE INCIDENTAL TO THE CONCRETE PAVEMENT ITEM BEING PLACED. THE REQUIRED RIDEABILITY MUST BE MET, REGARDLESS OF THE CONTRACTOR'S CHOSEN METHOD TO SUPPORT THE PAVER.
- 16. WHEN LONGITUDINALLY TYING NEW PCC PAVEMENT INTO EXISTING PCC PAVEMENT, SPRAY THE EXISTING PAVEMENT EDGE THOROUGHLY WITH CURING COMPOUND TO ACT AS A BOND BREAKER. DO NOT TIE THE NEW AND OLD LANES TOGETHER WITH TIE BARS
- 17. WHEN TRANSVERSELY TYING NEW PCC PAVEMENT INTO EXISTING PCC PAVEMENT, DRILL AND PLACE DOWELS IN ACCORDANCE WITH STANDARD CONSTRUCTION DETAIL P-1. USE EPOXY GROUT MEETING STANDARD SPECIFICATION SECTION 1047. FOLLOW THE PROCEDURE DETAILED IN STANDARD SPECIFICATION SECTION 503.3.5. COSTS TO FURNISH AND INSTALL THE DOWELS ARE INCLUDED IN ITEM 503006.
- 18. ALL JOINTS IN PCC PAVEMENT SHALL BE SEALED. REFER TO STANDARD SPECIFICATION 501.3.9 FOR DETAILS. THE CONTRACTOR MAY CHOOSE TO SAW THE TRANSVERSE AND LONGITUDINAL JOINTS IN STAGES, BEGINNING WITH AN INITIAL SAWCUT NO SMALLER THAN 1/8" IN WIDTH AND TO THE SPECIFIED DEPTH. THE JOINTS WILL THEN BE WIDENED IN A SECOND STAGE TO THE DIMENSIONS SHOWN ON THE APPLICABLE STANDARD DETAIL SHEET, JUST PRIOR TO SEALING WITH HOT-POURED JOINT SEALANT MATERIAL. ALL COSTS FOR SAWING AND SEALING ARE INCIDENTAL TO THE PCC PAVEMENT BEING CONSTRUCTED.

SECTION 600

- 19. DRAINAGE INLET GRATES ADJACENT TO THE CURB OR EDGE PAVING, WITHIN THE PROJECT LIMITS, WHICH ARE NOT TYPE 1 OR TYPE 4, SHALL BE REPLACED WITH TYPE 4 ON GRADE AND TYPE 1 IN SUMPS. INLET GRATES WITHIN THE PAVING, NOT ADJACENT TO THE CURB OR EDGE OF PAVING SHALL BE REPLACED WITH TYPE 3. THE ACTUAL LOCATIONS, THE NEED FOR ANY GRATE MODIFICATIONS OR FOR NEW FRAMES SHALL BE DETERMINED BY THE ENGINEER. ALL REPLACED GRATES/FRAMES SHALL BE DELIVERED TO THE NEAREST DISTRICT MAINTENANCE YARD WITH THE COST OF DELIVERY INCIDENTAL TO ITEM 602100 REPLACING DRAINAGE INLET GRATE(S) & ITEM 602101 REPLACING DRAINAGE INLET FRAME(S). FINAL PAYMENT FOR REPLACED GRATES/FRAMES SHALL NOT BE MADE UNTIL RECEIPT OF DELIVERED MATERIALS IS PRODUCED, SIGNED BY A DELDOT MAINTENANCE YARD SUPERVISOR.
- 20. STATION AND ELEVATION DATA WHERE NECESSARY, GIVEN FOR DRAINAGE STRUCTURES ARE TO BE APPLIED TO THE CENTER OF THE GRATE FOR INLETS AND TO THE CENTER OF THE STRUCTURE FOR JUNCTION BOXES AND MANHOLES.

SECTION 700

- 21. IN AREAS WHERE PROPOSED CURB MEETS EXISTING CURB AND THE TWO CURB TYPES ARE NOT SIMILAR, THE PROPOSED CURB SHALL BE TRANSITIONED IN 10 LINEAR FEET, UNLESS OTHERWISE DIRECTED BY THE ENGINEER. PAYMENT FOR THIS WORK, INCLUDING SAW CUTTING EXISTING CURB SHALL BE INCIDENTAL TO THE PROPOSED CURB ITEM.
- 22. WHERE PROPOSED CONCRETE SIDEWALK IS CONSTRUCTED TO MEET EXISTING SIDEWALK, THE EXISTING SIDEWALK SHALL BE SAWCUT AT THE TIE-IN POINT OR MEET THE NEAREST EXISTING SIDEWALK JOINT. ALL SAW CUTTING SHALL BE FULL DEPTH, UNLESS OTHERWISE NOTED ON THE PLANS OR DIRECTED BY THE ENGINEER AND SHALL BE PAID FOR UNDER ITEM 762001 SAWCUTTING. CONCRETE. FULL DEPTH.
- 23. PORTLAND CEMENT CONCRETE CHANNELIZING ISLANDS THAT ARE LESS THAN 75 SQ FT MAY BE POURED MONOLITHICALLY, OR AS DIRECTED BY THE ENGINEER.
- 24. THE NEW CASTLE COUNTY DEPARTMENT OF PUBLIC WORKS SHALL SUPPLY AND THE STATE'S CONTRACTOR SHALL INSTALL NEW SELF SEALING MANHOLE FRAMES AND COVERS ON ALL COUNTY SEWER MANHOLES THAT ARE NOT BEING RELOCATED, WITHIN THE PROJECT LIMITS IN ACCORDANCE WITH THE COUNTY'S STANDARD SPECIFICATIONS. THE EXISTING MANHOLE FRAMES AND COVERS THAT ARE REMOVED SHALL BECOME THE PROPERTY OF THE STATE'S CONTRACTOR. PAYMENT SHALL BE INCIDENTAL TO ITEM 711500 ADJUST AND REPAIR EXISTING SANITARY SEWER MANHOLE.
- 25. THE CONTRACTOR SHALL DELIVER ALL EXCESS MILLED MATERIAL TO THE DELAWARE DEPARTMENT OF TRANSPORTATION'S TURNPIKE MAINTENANCE YARD. THE MATERIAL SHALL BE NEATLY STOCKPILED AT THE YARD. COSTS FOR THIS WORK SHALL BE INCIDENTAL TO THE MILLING ITEM UTILIZED FOR PAYMENT ON THE CONTRACT.
- 26. ALL PAVED AREAS TO BE RECONSTRUCTED OR WIDENED SHALL BE SAWCUT AT THE POINT WHERE THE NEW PAVEMENT IS TO TIE INTO THE EXISTING PAVEMENT.
- 27. THE CONTRACTOR SHALL SUBMIT A LOCATION FOR A FIELD OFFICE TO THE ENGINEER FOR APPROVAL. THE FIELD OFFICE SHALL BE COMPLETE AND IN PLACE PRIOR TO BEGINNING CONSTRUCTION. ALL COSTS TO BE INCLUDED IN ITEM 763598 -FIELD OFFICE, SPECIAL I.
- 28. CONNECTION TO AN EXISTING UNDERDRAIN SYSTEM (IF ONE IS ENCOUNTERED) SHALL BE INCIDENTAL TO ITEM 709001.
- 29. THIS PROJECT WILL EXTEND OVER WINTER PERIODS AND ALL SNOW REMOVAL ALONG THE STATE MAINTAINED ROADWAYS WILL BE HANDLED BY STATE FORCES. FOLLOWING THE SNOW REMOVAL OPERATION, REPAIRS TO ANY MAINTENANCE OF TRAFFIC CONTROL DEVICES SHALL BE PERFORMED BY THE CONTRACTOR. COSTS FOR REPAIRS ARE INCIDENTAL TO ITEM 801000. DEVICES REQUIRING REPLACEMENT WILL BE PAID FOR UNDER THE APPLICABLE BID ITEM.
- 30. SAWCUTTING OF HOT-MIX ON TOP OF CONCRETE PAVEMENT SHALL BE INCIDENTAL TO ITEM 762001 SAW CUTTING CONCRETE, FULL DEPTH.
- 31. CASINGS IF REQUIRED FOR INSTALLATION OF POLE BASES SHALL BE INCIDENTAL TO THE ITEM BEING INSTALLED. THE CASING SHALL BE STEEL, PVC, OR OTHER PERMANENT MATERIAL CAPABLE OF SUPPORTING THE AUGERED HOLE TO ITS FULL DEPTH. THE CASING SHALL BE ADVANCED AS THE EXCAVATION PROGRESSES TO ELIMINATE ANY VOID BETWEEN THE CASING AND THE SURROUNDING SOIL. ANY RESULTING VOIDS BETWEEN THE CASING AND ORIGINAL GROUND SHALL BE PRESSURE GROUTED PRIOR TO PLACING CONCRETE FOR THE POLE BASE. THE CASING SHALL BE INSTALLED OR CUT OFF IF REQUIRED SO THAT THE TOP OF THE CASING IS AT OR SLIGHTLY BELOW THE FINISHED GROUND ELEVATION SURROUNDING THE POLE BASE. THE CASING SHALL REMAIN IN PLACE. JUST PRIOR TO CONCRETE PLACEMENT, THE EXCAVATION SHALL BE INSPECTED AND ANY EXCESS WATER SHALL BE PUMPED SO THAT THE CONCRETE IS PLACED IN A DRY HOLE. COSTS TO FURNISH AND INSTALL THE CASING, PRESSURE GROUT IF REQUIRED, CUT OFF IF REQUIRED AND PUMP OUT ANY EXCESS WATER SHALL BE INCIDENTAL TO THE UNIT PRICE BID PER EACH POLE BASE.

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NOT TO SCALE

I-95 AND SR 896
INTERCHANGE

NOTES

SECTION

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SHEET NO.

PROJECT NOTES

- 32. CONTRACTOR SHALL OMIT GUARDRAIL POSTS IF THERE IS A CONFLICT IN ACCORDANCE WITH DELDOT STANDARD CONSTRUCTION DETAILS. COSTS ASSOCIATED WITH DETERMINING IF THERE IS A CONFLICT, OMITTING THE POST, AND ADDED NESTED W-BEAM RAIL SHALL BE INCIDENTAL TO THE GUARDRAIL ITEM BEING CONSTRUCTED.
- 33. CONTRACTOR SHALL LOCATE UTILITIES, STORM DRAIN, UNDERDRAIN, AND ANY OTHER MISCELLANEOUS APPURTENANCES INCIDENTAL TO GUARDRAIL ITEM BEING CONSTRUCTED PRIOR TO GUARDRAIL INSTALLATION.
- 34. PAYMENT FOR THE SUPPLY OF 4" SCHEDULE 40 PVC WEEPHOLES AND METAL SCREENS SHALL BE INCIDENTAL TO ITEM 723013.
- 35. PLACE EXPANSION MATERIAL IN ACCORDANCE WITH STANDARD SPECIFICATION 701.3G AT ALL LOCATIONS WHERE CURB, CURB AND GUTTER, OR BARRIER WALLS ARE CONSTRUCTED AGAINST PCC PAVEMENT. COSTS ARE INCIDENTAL TO THE CURB, CURB AND GUTTER, OR BARRIER BEING CONSTRUCTED.

SECTION 800

- 36. HIGHWAY LIGHTING SHALL BE PROVIDED ALONG ALL PERMANENT RAMPS AND GORE AREAS PRIOR TO OPENING THE ROADWAYS TO TRAFFIC. IF THE PERMANENT LIGHTING IS NOT INSTALLED AND ENERGIZED PRIOR TO OPENING THE VARIOUS PHASES OF THE PROJECT TO TRAFFIC, THEN TEMPORARY LIGHT PLANTS AS DIRECTED BY THE ENGINEER MUST BE PROVIDED BY THE CONTRACTOR UNTIL THE PERMANENT FACILITIES ARE ENERGIZED. UNLESS OTHERWISE APPROVED BY THE ENGINEER, COSTS TO PROVIDE LIGHT PLANTS FOR THIS PURPOSE WILL NOT BE PAID SEPARATELY AND ARE INCIDENTAL TO ITEM 801000, MAINTENANCE OF TRAFFIC.
- 37. PRIOR TO OPENING ANY PORTIONS OF TEMPORARY PAVEMENT, PERMANENT MAINLINE PAVEMENT, OR RAMP PAVEMENT, DELDOT WILL CONDUCT A SAFETY INSPECTION. ANY PUNCHLIST ITEMS GENERATED BY THIS INSPECTION MUST BE COMPLETED BY THE CONTRACTOR PRIOR TO OPENING THE APPLICABLE PORTION OF ROADWAY TO TRAFFIC. AT LEAST 2 WEEKS NOTICE PRIOR TO THE SCHEDULED ROADWAY OPENING SHALL BE PROVIDED TO THE PROJECT RESIDENT BY THE CONTRACTOR IN ORDER TO SCHEDULE THE SAFETY INSPECTION.
- 38. THE CONTRACTOR SHALL MAKE AVAILABLE AT LEAST ONE EMPLOYEE TO ATTEND AND REPRESENT THE FIRM AT ALL SCHEDULED JOB PROGRESS MEETINGS, PROJECT WORKING GROUP MEETINGS, OR OTHER INFORMATIONAL MEETINGS AS REQUESTED BY THE ENGINEER. THE PERSON ATTENDING SHALL BE KNOWLEDGEABLE OF CURRENT JOB PROGRESS, THE ANTICIPATED CONSTRUCTION SCHEDULE, AND ANY ONGOING OR POTENTIAL CONTRACT ISSUES. COSTS ARE INCIDENTAL TO ITEM 801000, MAINTENANCE OF TRAFFIC.

SECTION 900

- 39. THIS PROJECT IS COVERED UNDER AN NPDES GENERAL PERMIT FOR CONSTRUCTION. UNDER THE GENERAL PERMIT, COMPLIANCE WITH DELDOT'S APPROVED SEDIMENT AND STORMWATER MANAGEMENT PLANS WILL CONSTITUTE COMPLIANCE WITH THE NPDES INDUSTRIAL PERMITTING REQUIREMENTS FOR THIS CONSTRUCTION PROJECT. A COPY OF THE NPDES GENERAL PERMIT AND NOI IS KEPT ON FILE IN EACH OF THE CONSTRUCTION OFFICES AND THE DEPARTMENT'S STORMWATER SECTION. A COPY OF THE GENERAL PERMIT OR THE NOI CAN BE OBTAINED UPON REQUEST FROM EITHER THE DEPARTMENT'S STORMWATER ENGINEER OR THE APPROPRIATE CONSTRUCTION ENGINEER.
- 40. STOCKPILE AREAS MAY BE OBTAINED BY THE CONTRACTOR, IN ACCORDANCE WITH SECTION 908 OF THE STANDARD SPECIFICATIONS, SUBJECT TO THE APPROVAL OF THE ENGINEER. THESE STOCKPILE AREAS MAY BE LOCATED OUTSIDE THE PROJECT LIMITS, IF NECESSARY. COSTS FOR SECONDARY MOVEMENTS OF STOCKPILED MATERIALS (EXCEPT TOPSOIL) TO BE INCORPORATED PERMANENTLY INTO THE PROJECT, OR TAKEN TO OFFSITE DISPOSAL SITES, WILL BE INCIDENTAL TO THE EXCAVATION ITEMS THAT GENERATED THE MATERIAL. PAYMENT WILL BE MADE ONLY ONE TIME, THAT BEING WHEN THE MATERIAL IS ORIGINALLY EXCAVATED. STOCKPILED TOPSOIL THAT CAN BE INCORPORATED INTO THE PERMANENT PROJECT WILL BE PAID FOR UNDER ITEM 908010, TOPSOILING 6" DEPTH. NO ADDITIONAL PAYMENT WILL BE MADE FOR OFF-SITE STOCKPILING.
- 41. PAYMENT FOR EROSION CONTROL BLANKET MULCH (ITEM 908020) WILL BE MADE ONLY FOR AREAS SPECIFICALLY IDENTIFIED ON THE PLANS FOR USE OF THIS ITEM. FOR ALL TOPSOIL AREAS NOT GETTING EROSION CONTROL BLANKET MULCH, THE CONTRACTOR SHALL UTILIZE EROSION CONTROL MULCH (ITEM 908026).

SECTION 1000

42. DELETE STANDARD SPECIFICATION 1005.2.3. BITUMINOUS MILLINGS ARE NOT PERMITTED FOR USE AS GABC.

MISCELLANEOUS

- 43. THE CONTRACTOR SHALL NOTIFY DART FIRST STATE AT DOT DETOURS@DELAWARE.GOV AT LEAST 14 DAYS PRIOR TO THE START OF ANY DETOURS OR CONSTRUCTION, AND DOT DTC PROJECTDEVELOPMENT@DELAWARE.GOV AT SUCH TIME THE FACILITY IS COMPLETED AND OPERABLE FOR TRANSIT OFERATIONS. FOR EMERGENCY DETOUR INFORMATION ONLY, PLEASE CONTACT DTC'S CHIEF SCHEDULER AT 302-576-6019.
- 44. ALL DART SIGNS HAVE BEEN UPDATED TO A NEW DESIGN. ALL REQUESTS FOR FABRICATION OF THESE SIGNS MUST BE MADE THROUGH DART TRANSIT AT (302) 576-6132.
- 45. THE CONTRACTOR SHALL SAWCUT 1' (+/-) INTO THE EXISTING TRAVEL LANE FOR CONSTRUCTION OF THE PROPOSED FULL DEPTH PAVEMENT OR AS DIRECTED BY THE ENGINEER IN THE FIELD. WHERE PCC PAVEMENT IS IDENTIFIED, THE CONTRACTOR SHALL NOT DAMAGE THE EXISTING EDGE OF THE CONCRETE PAVEMENT DURING EXCAVATION OF THE ADJACENT PAVEMENT BOX AND CONSTRUCT THE PROPOSED PAVEMENT BOX ADJACENT TO THE EDGE. SHOULD THE EXISTING CONCRETE EDGE BE DAMAGED. THE CONTRACTOR SHALL SAWCUT THE EDGE AS NECESSARY AT NO COST TO DELDOT. ALL COSTS TO IDENTIFY EXISTING CONCRETE ARE INCIDENTAL TO THE PROJECT.
- 46. PROPOSED DRAINAGE PIPE LENGTHS, PROVIDED IN THE SCHEDULES, INCLUDE FLARED END SECTIONS.
- 47. VERTICAL ADJUSTMENTS AND REPAIRS OF COMMUNICATION AND ELECTRIC MANHOLES PERFORMED BY THE STATE'S CONTRACTOR SHALL BE PAID FOR UNDER ITEM 711500 - ADJUST AND REPAIR SANITARY MANHOLE.
- 48. ADJUSTMENTS AND RELOCATIONS OF GAS VALVES, GAS MANHOLES, GAS MARKERS, AND GAS VENTS PERFORMED BY THE STATE'S CONTRACTOR SHALL BE PAID UNDER ITEM 710503 - ADJUST GAS VALVE BOXES.

43. A DETAILED EARTHWORK SUMMARY BROKEN DOWN BY CONSTRUCTION PHASE WILL BE DEVELOPED ONCE THE CONSTRUCTION PHASING IS FURTHER DEVELOPED WITH THE CM/GC TEAM.

EARTHWORK SUMMARY				
	PROJECT TOTAL			
EXCAVATION				
EXCAVATION FROM CROSS SECTIONS	187,501 C.Y.			
MITIGATION SITE	43,521 C.Y.			
TOPSOIL STRIPPING	28,692 C.Y.			
TOPSOIL STRIPPING (MITIGATION SITE)	8,015 C.Y.			
PCC REMOVAL	10,904 C.Y.			
TOTAL EXCAVATION	256,825 C.Y.			
STORMWATER POND EXCAVATION	28,376 C.Y.			
TOTAL ROCK EXCAVATION FOR ROADWAY AND TRENCHES	25,038 C.Y.			
EXCAVATION AVAILABLE FOR EMBANKMENT				
EXCAVATION MEETING BORROW TYPE 'A'	0 C.Y.			
EXCAVATION MEETING BORROW TYPE 'F'	186,510 C.Y.			
EXCAVATION MEETING BORROW TYPE 'F' (MITIGATION SITE)	43,521 C.Y.			
EXCAVATION MEETING TOPSOIL	27,257 C.Y.			
EXCAVATION MEETING TOPSOIL (MITIGATION SITE)	8,015 C.Y.			
UNSUITABLE MATERIAL	29,367 C.Y.			
UNSUITABLE MATERIAL FROM ROCK EXCAVATION	25,038 C.Y.			
EMBANKMENT REQUIREMENTS				
BORROW TYPE 'A' REQUIRED (ADJUSTED 12%)	34,224 C.Y.			
BORROW TYPE 'B' REQUIRED (ADJUSTED 12%)	5,000 C.Y.			
BORROW TYPE 'C' REQUIRED (ADJUSTED 12%)	48,490 C.Y.			
BORROW TYPE 'F' REQUIRED (ADJUSTED 12%)	323,755 C.Y.			
SELECT BACKFILL FOR MSE WALL REQUIRED (ADJUSTED 12%)	109,529 C.Y.			
CLAY BORROW REQUIRED (ADJUSTED 20%)	2,154 C.Y.			
TOPSOIL REQUIRED	48,115 C.Y.			
TOPSOIL REQUIRED (MITIGATION SITE)	8,015 C.Y.			
MATERIAL BALANCE ("+"= EXCESS, "-"= NEED)				
BORROW TYPE 'A'	-34,224 C.Y.			
BORROW TYPE 'B'	-5,000 C.Y.			
BORROW TYPE 'C'	-48,490 C.Y.			
BORROW TYPE 'F'	-93,724 C.Y.			
BORROW TYPE 'F' (SR273 STOCKPILE)	12,039 C.Y.			
TOTAL BORROW TYPE 'F' OFFSITE	-81,685 C.Y.			
SELECT BACKFILL FOR MSE WALL	-109,529 C.Y.			
CLAY BORROW	-2,154 C.Y.			
TOPSOIL	-20,858 C.Y.			
TOTAL UNSUITABLE MATERIAL	54,405 C.Y.			

- 1) THE VALUES LISTED IN THE EARTHWORK SUMMARY ARE APPROXIMATE AND ARE NOT TO BE USED AS A BASIS OF PAYMENT. THE EARTHWORK SUMMARY IS CONSIDERED FOR INFORMATIONAL PURPOSES ONLY.
- 2) OTHER SOURCES OF EXCAVATION MAY INCLUDE STRUCTURE EXCAVATION, UNDERCUT EXCAVATION, ROCK OVER EXCAVATION, MAINTENANCE OF TRAFFIC EXCAVATION. ETC.
- 3) UNSUITABLE MATERIALS INCLUDE UNDERCUT SOILS, BITUMINOUS PAVEMENT, PCC PAVEMENT, ETC.

ENVIRONMENTAL COMPLIANCE NOTES

- 1. GENERAL NOTES:
 - A. THE PURPOSE OF THESE SHEETS ARE TO IDENTIFY THOSE ITEMS ASSOCIATED WITH ENVIRONMENTAL COMPLIANCE. IMPACT CALCULATIONS ARE FOR THE AGENCY PERMIT REPORTING PURPOSES ONLY AND ARE NOT TO BE USED FOR BIDDING PURPOSES.
 - B. IF A DEPARTURE FROM THE APPROVED PLANS (WHICH WOULD AFFECT ANY NATURAL AND/OR CULTURAL RESOURCES) IS NECESSARY, CONTACT THE ENVIRONMENTAL STUDIES SECTION AT (302-760-2259 OR DOT_ENVIRONMENTALSTUDIES@DELAWARE.GOV) TO ALLOW FOR COORDINATION WITH THE APPROPRIATE RESOURCE AGENCIES AND APPROVAL.
 - C. USE OF THIS SHEET DOES NOT ALLEVIATE THE CONTRACTOR'S RESPONSIBILITY TO COMPLY WITH ALL CONDITIONS SET FORTH IN THE ENVIRONMENTAL STATEMENT AND PERMITS.
- 2. NATURAL RESOURCE ISSUES:
 - A. PERMIT REQUIREMENTS/APPROVALS *:
 U.S. ARMY CORPS OF ENGINEERS (COE): PENDING
 DNREC WETLANDS & SUBAQUEOUS LANDS (WLSL): PENDING
 DNREC WATER QUALITY (WQC) & COASTAL ZONE CONSISTENCY (CZM): PENDING
 NCC DEPT. OF LAND USE (NCC): PENDING
 CITY OF NEWARK DEPT. OF LAND USE: PENDING
 - * THE PERMITS/APPROVALS LISTED ARE THOSE REQUIRED FOR THIS PROJECT. THE ENVIRONMENTAL STUDIES SECTION IS
 - RESPONSIBLE FOR COORDINATING AND/OR OBTAINING THESE APPROVALS.
 THE CONTRACTOR MUST ENSURE THAT THESE PERMITS/APPROVALS ARE IN THEIR POSSESSION PRIOR TO BEGINNING
 CONSTRUCTION IN THE PERMITTED AREA(S) AND ENSURE THEY ARE DISPLAYED ON-SITE DURING THE ENTIRE CONSTRUCTION
 PERIOD
 - CONSTRUCTION RESTRICTIONS:

FISHERIES - NONE, DOWNSTREAM BARRIERS ENDANGERED SPECIES - PENDING

MIGRATORY BIRDS - THE BRIDGES WITHIN THE PROJECT SCOPE HAVE NOT BEEN SURVEYED FOR THE PRESENCE OF NESTING MIGRATORY BIRDS, WHICH ARE PROTECTED BY TITLE 7, DELAWARE CODE, CHAPTER 7, SECTIONS 734 AND 735. IT IS POSSIBLE THAT ONE OR MORE PAIRS OF BARN SWALLOW (HIRUNDO RUSTICA) AND/OR EASTERN PHOEBE (SAYORNIS PHOEBE) NEST UNDER THE BRIDGE(S). IF WORK IS PROPOSED DURING THE BREEDING SEASON (APRIL 15 - AUGUST 1), A SURVEY SHOULD BE COMPLETED PRIOR TO THE START OF WORK TO DETERMINE IF NESTS ARE PRESENT. IF A SURVEY DETECTS NESTING ACTIVITY, THE FOLLOWING STEPS SHOULD BE TAKEN TO AVOID NEST DESTRUCTION AND TAKE, WHICH IS A VIOLATION OF STATE LAW:

- 1. PERFORM CONSTRUCTION ACTIVITIES FROM AUGUST 1 TO APRIL 15.
- IF CONSTRUCTION CANNOT BE PERFORMED IN THIS TIME PERIOD, A DETERRENT SUCH AS MESH NETTING SHOULD BE USED TO BLOCK ACCESS TO NESTING SITES ON THE UNDERSIDE OF THE BRIDGE(S). THE MATERIAL WOULD NEED TO BE IN PLACE NO LATER THAN APRIL 15, THE UNDERSIDE OF THE BRIDGE(S) WOULD NEED TO BE FULLY ENCAPSULATED, AND THE MATERIAL SHOULD BE LEFT IN PLACE UNTIL CONSTRUCTION BEGINS.

IF ACTIVE NESTS ARE DISCOVERED DURING THE COURSE OF WORK, ACTIVITIES SHOULD BE HALTED IMMEDIATELY AND SCRP CONTACTED FOR FURTHER GUIDANCE.

- 3. CULTURAL RESOURCE ISSUES:
 - A. PENDING B. PENDING
- 4. STREAM RESTORATION AND RIPRAP TREATMENT.
- A. FOLLOW THE SPECIAL PROVISION FOR ITEM 707500 CHANNEL BED FILL IN REGARDS TO THE SALVAGING OF ON-SITE NATURAL STREAM BOTTOM MATERIAL OR THE FURNISHING OF OFFSITE MATERIAL. IF SUFFICIENT SOURCES FOR CHANNEL BED FILL DO NOT EXIST ON-SITE, ANY NEW MATERIAL MUST CONFORM TO THE REQUIREMENTS OF ITEM 707500 CHANNEL BED FILL. RECESS ALL RIPRAP IN THE CHANNEL BOTTOM (I.E. BELOW THE WATER LINE) ONE FOOT BELOW STREAM BED ELEVATION AND CHOKE WITH BORROW TYPE 'B' SO THAT ALL OF THE VOIDS IN THE RIPRAP ARE FILLED WITH SPECIFIED MATERIAL. PAYMENT UNDER ITEM 209002 BORROW, TYPE B. COVER THE RIPRAP WITH A MINIMUM OF 12" CHANNEL BED FILL. MATCH THE FINAL CHANNEL ELEVATIONS WITH EXISTING ELEVATIONS AT THE UPSTREAM AND DOWNSTREAM PROJECT LIMITS. THROUGH THE STRUCTURE, ELEVATIONS WILL BE AS NOTED ON THE PLANS. PAYMENT UNDER ITEM 707500 CHANNEL BED FILL.
- B. RESTORE OTHER AREAS OF THE CHANNEL BOTTOM AFFECTED BY CONSTRUCTION (INCLUDING, BUT NOT LIMITED TO, THE LOCATION OF SUMP PITS, STABILIZED OUTFALLS, TEMPORARY PIPES AND/OR SANDBAG DIKES AND DIVERSIONS) TO EXISTING CONDITIONS. FILL ANY CAVITIES OR SCOUR HOLES RESULTING FROM CONSTRUCTION ACTIVITIES WITH CHANNEL BED FILL. PAYMENT UNDER ITEM 707500 CHANNEL BED FILL.
- C. WHEN ALL EROSION AND SEDIMENT CONTROL MEASURES ARE REMOVED AND THE STREAM RETURNS TO ITS NATURAL FLOW CONDITIONS, THE FLOW MUST REMAIN ABOVE GROUND AND ABOVE THE RIPRAP (I.E. THE FLOW CANNOT BE "LOST" IN THE RIPRAP OR BENEATH THE STRUCTURE). IF THIS IS NOT ACHIEVED, THE CONTRACTOR WILL BE REQUIRED TO TAKE CORRECTIVE ACTION AT THE CONTRACTOR'S EXPENSE.
- D. CHOKE ALL RIPRAP ON THE STREAM BANK, OUTSIDE THE CHANNEL BED, WITH DELAWARE #57 STONE. PLACE JUST ENOUGH CHOKE MATERIAL TO PREVENT THE LOSS OF CHANNEL BED FILL OR TOPSOIL (DEPENDING ON LOCATION AS INDICATED BELOW) THROUGH THE RIPRAP.
 - 1. BENEATH THE BRIDGE: AFTER PLACING DELAWARE #57 STONE, PEFORM A FINAL CHOKE OF CHANNEL BED FILL SO THAT THE RIPRAP PEAKS ARE BARELY VISIBLE.


 PAYMENT UNDER ITEM 707500 CHANNEL BED FILL. DELAWARE #57 STONE IS INCIDENTAL TO THE RIPRAP ITEM.
 - 2. ALL OTHER LOCATIONS: FINISH FILLING THE VOIDS WITH TOPSOIL SO THAT THE RIPRAP PEAKS ARE BARELY VISIBLE. PLACE AN ADDITIONAL 6-INCH TOPSOIL LAYER ON TOP OF THE RIPRAP. SLOPE SEEDING WILL BE DONE WITH ITEM 908019 STREAMBANK SEED MIX, SEEDING. FOLLOWING THE SEEDING OPERATION, INSTALL ITEM 908020 EROSION CONTROL BLACKENT (ECB) MULCH, OR OTHER BLANKET AS SHOWN ON THE PLANS. ECB AT TOE OF SLOPE CAN BE EITHER TRENCHED IN OR STAPLED AT 6" ON CENTER. COMPLETE ALL WORK, STARTING WITH THE INITIAL CHOKING WITH TOPSOIL THROUGH THE SEEDING AND MULCHING PRIOR TO ANY RAIN EVENT. DELAWARE #57 STONE IS INCIDENTAL TO THE RIPRAP ITEM. ALL OTHER ITEMS WILL BE PAID FOR UNDER THEIR RESPECTIVE ITEMS.
- E. THE TOPSOIL/SEED/MULCH CAN BE PLACED BEFORE OR AFTER THE REMOVAL OF THE STREAM DIVERSION. IF THE PLACEMENT OCCURS AFTER STREAM DIVERSION REMOVAL, USE A TURBIDITY CURTAIN TO MINIMIZE IN-STREAM SEDIMENTATION. PAYMENT WILL BE INCIDENTAL TO ITEM 909005 STREAM DIVERSION.
- 5. PROTECTION OF RESOURCES:
 - A. KEEP CLEARING IN WETLAND AREAS TO A MINIMUM ABSOLUTELY NECESSARY FOR CONSTRUCTION ACCESS. SUPPORT ALL EQUIPMENT TRAVERSING WETLANDS AND SUBAQUEOUS LAND ON MATS. PAYMENT FOR MATS WILL BE MADE UNDER ITEM 621500 TEMPORARY TIMBER MAT. IN WETLAND AREAS THAT ARE CLEARED, NO GRUBBING EXCEPT WHERE NECESSARY TO CONSTRUCT PROJECT COMPONENTS SUCH AS FOUNDATIONS AND RIPRAP PROTECTION IS PERMITTED. CUT VEGETATION FLUSH WITH THE GROUND (I.E. NO DISTURBANCE OF THE ROOT MAT). RESTORE TEMPORARILY DISTURBED WETLAND AREAS TO GRADE AND SEED WITH ITEM 908017 TEMPORARY GRASS SEEDING (ANNUAL RYEGRASS).
 - B. USE SILT FENCE OR CONSTRUCTION SAFETY FENCE ALONG THE LIMITS OF CONSTRUCTION IN ALL AREAS WHERE WATER/WETLANDS ARE BEING IMPACTED (AS SHOWN ON ENVIRONMENTAL COMPLIANCE SHEETS), AND ALSO IN ANY AREA WHERE WATER/WETLANDS EXIST WITHIN 20 FEET OF THE LIMIT OF CONSTRUCTION (AS SHOWN ON CONSTRUCTION PLAN SHEETS). ANY CONTRACTOR ACCESS BEYOND THE LIMIT OF CONSTRUCTION IS STRICTLY PROHIBITED.
 - C. USE SANDBAGS OR COMPOST FILTER LOG (CFL) TO SECURE SILT FENCE AT AREAS ADJACENT TO WOODED UPLANDS/ ALL WETLANDS IN LIEU OF TRENCHING UNLESS PROPER EROSION AND SEDIMENT CONTROL CANNOT BE MAINTAINED. REMOVE SANDBAGS AND CFLS (AND CONTENTS) IN THEIR ENTIRETY WHEN NO LONGER NEEDED. SANDBAGS/CFLS USED TO SECURE THE SILT FENCE IS INCIDENTAL TO ITEM 905001 SILT FENCE. THE ENVIRONMENTAL STUDIES SECTION (302-760-2259 or DOT ENVIRONMENTALSTUDIES@DELAWARE.GOV) CAN PROVIDE FURTHER GUIDANCE REGARDING THIS METHOD OF INSTALLATION.
 - D. CLEARLY MARK ALL TREES TO BE REMOVED WITH PAINT PRIOR TO THE EROSION AND SEDIMENT CONTROL MEETING.

ORIGINAL SHEET PREPARED BY MCCORMICK TAYLOR, INC. ON 09-27-2019. SHEET LAST UPDATED ON 02/14/2022.

WETLANDS DELINEATED BY MCCORMICK TAYLOR, INC. IN SEPTEMBER 2019; UPDATED BY CEI IN AUGUST 2020 IN ACCORDANCE WITH THE US ARMY CORPS OF ENGINEERS "CORPS OF ENGINEERS WETLAND DELINEATION MANUAL (1987)" AND EASTERN MOUNTAINS AND PIEDMONT REGIONAL SUPPLEMENT V 2.0 (2012).

	PERMANENT OPEN WATER IMPACT AREA SCHEDULE							
SHEET	IMPACT DESCRIPTION	AREA (SF)	AREA (AC)	VOLUME (CY)	LOSS AREA (AC)	JURISDICTION		
2	TOTAL FOR SHEET 2	210.96	0.0048	8.53	0.0048	USACE/DNREC		
4	TOTAL FOR SHEET 4	102.06	0.0023	4.06	0.0023	USACE/DNREC		
5	TOTAL FOR SHEET 5	508.63	0.0117	30.20	0.0117	USACE/DNREC		
6	TOTAL FOR SHEET 6	661.32	0.0152	34.82	0.0152	USACE/DNREC		
9	TOTAL FOR SHEET 9	1208.94	0.0277	-13.91	0.0277	USACE/DNREC		
10	TOTAL FOR SHEET 10	1412.60	0.0324	29.28	0.0324	USACE/DNREC		
11	TOTAL FOR SHEET 11	2082.69	0.0478	14.23	0.0478	USACE/DNREC		
12	TOTAL FOR SHEET 12	1381.03	0.0317	140.96	0.0317	USACE/DNREC		
13	TOTAL FOR SHEET 13	8134.14	0.1868	201.00	0.1868	USACE/DNREC		
14	TOTAL FOR SHEET 14	4605.13	0.1057	7.34	0.1057	USACE/DNREC		
18	TOTAL FOR SHEET 18	15918.86	0.3654	1453.87	0.3654	USACE/DNREC		
20	TOTAL FOR SHEET 20	4503.20	0.1034	221.22	0.1034	USACE/DNREC		
TOTAL FOR	R THIS PROJECT	40729.56	0.9349	2131.42	0.9349	USACE/DNREC		

TEMPORARY OPEN WATER IMPACT AREA SCHEDULE							
ID	IMPACT DESCRIPTION	AREA (SF)	AREA (AC)	VOLUME (CY)	JURISDICTION		
13-0T-1	TEMPORARY DIVERSION	87.74	0.0020	ı	USACE/DNREC		
TOTAL FOR THIS PROJECT 87.74 0.0020 - USACE/DNREC							

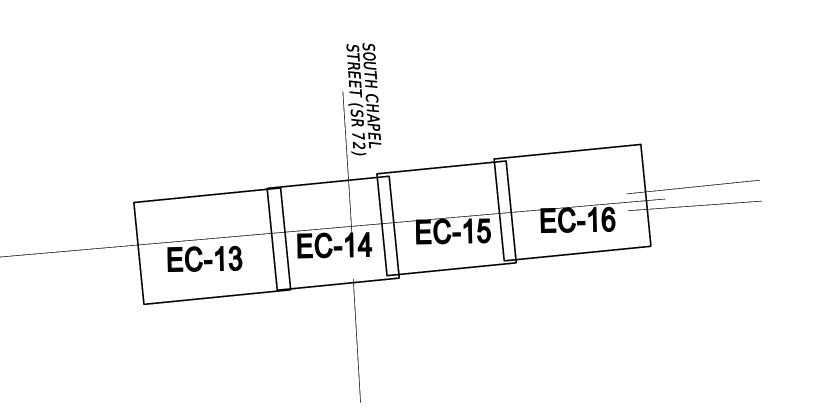

	TEMPORARY WETLAND IMPACT AREA SCHEDULE							
I D	IMPACT DESCRIPTION	AREA (SF)	AREA (AC)	VOLUME (CY)	JURISDICTION			
4	TOTAL FOR SHEET 4	194.28	0.0045	-	USACE			
8	TOTAL FOR SHEET 8	989.72	0.0227	-	USACE			
9	TOTAL FOR SHEET 9	13590.18	0.3120	-	USACE			
10	TOTAL FOR SHEET 10	5366.50	0.1232	-	USACE			
11	TOTAL FOR SHEET 11	6847.38	0.1572	-	USACE			
12	TOTAL FOR SHEET 12	8117.11	0.1863	-	USACE			
13	TOTAL FOR SHEET 13	161.44	0.0037	-	USACE			
15	TOTAL FOR SHEET 15	19.51	0.0004	-	USACE			
17	TOTAL FOR SHEET 17	4547.69	0.1044	-	USACE			
18	TOTAL FOR SHEET 18	17499.42	0.4017	-	USACE			
19	TOTAL FOR SHEET 19	4312.67	0.0990	-	USACE			
TOTAL FOR	THIS PROJECT	61645.90	1.4151	-	USACE			

PERMANENT WETLAND IMPACT AREA SCHEDULE						
ID	IMPACT DESCRIPTION	AREA (SF)	AREA (AC)	VOLUME (CY)	LOSS AREA (AC)	JURISDICTION
3	TOTAL FOR SHEET 3	2937.97	0.0675	-	0.0675	USACE
4	TOTAL FOR SHEET 4	12576.65	0.2887	-	0.2887	USACE
5	TOTAL FOR SHEET 5	7718.95	0.1772	-	0.1772	USACE
6	TOTAL FOR SHEET 6	2431.44	0.0558	-	0.0558	USACE
7	TOTAL FOR SHEET 7	772.75	0.0177	-	0.0177	USACE
9	TOTAL FOR SHEET 9	5390.29	0.1237	-	0.0900	USACE
10	TOTAL FOR SHEET 10	10837.62	0.2488	-	0.1819	USACE
11	TOTAL FOR SHEET 11	7495.99	0.1721	-	0.1721	USACE
12	TOTAL FOR SHEET 12	3283.13	0.0754	-	0.0754	USACE
13	TOTAL FOR SHEET 13	214.64	0.0049	-	0.0049	USACE
14	TOTAL FOR SHEET 14	5484.99	0.1259	-	0.0960	USACE
15	TOTAL FOR SHEET 15	7450.71	0.1711	-	0.0812	USACE
16	TOTAL FOR SHEET 16	4257.92	0.0978	-	0.0537	USACE
17	TOTAL FOR SHEET 17	2309.82	0.0530	-	0.0437	USACE
18	TOTAL FOR SHEET 18	10394.07	0.2386	-	0.2386	USACE
19	TOTAL FOR SHEET 19	4067.26	0.0933	-	0.0933	USACE
20	TOTAL FOR SHEET 20	13358.16	0.3067	-	0.3067	USACE
TOTAL FO	R THIS PROJECT	98928.87	2.2711	-	1.9973	USACE

ADDENDA / REVISIONS

NOT TO SCALE

I-95 AND SR 896
INTERCHANGE

EC-20

EC-09

EC-10

EC-08

EC-19

EC-18

EC-03

EC-02

EC-12

1-95

CONTRACT
BRIDGE NO.

T201609002

COUNTY

NEW CASTLE

CHECKED BY: S. PENOZA

ENVIRONMENTAL COMPLIANCE PLAN


SECTION


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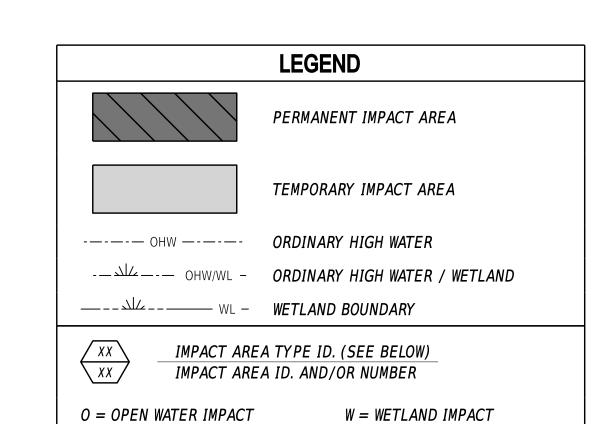
SHEET NO.

1027

16-MAR-2022 17:53 Videldetwillicollife adf work diskappy apprecent



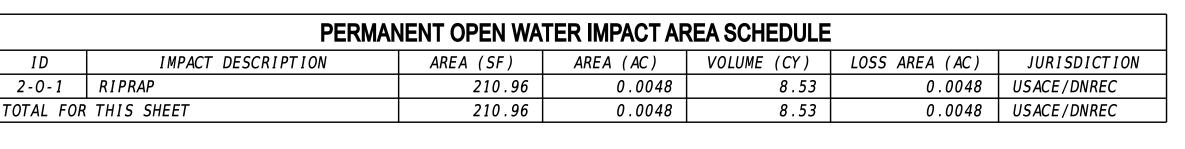

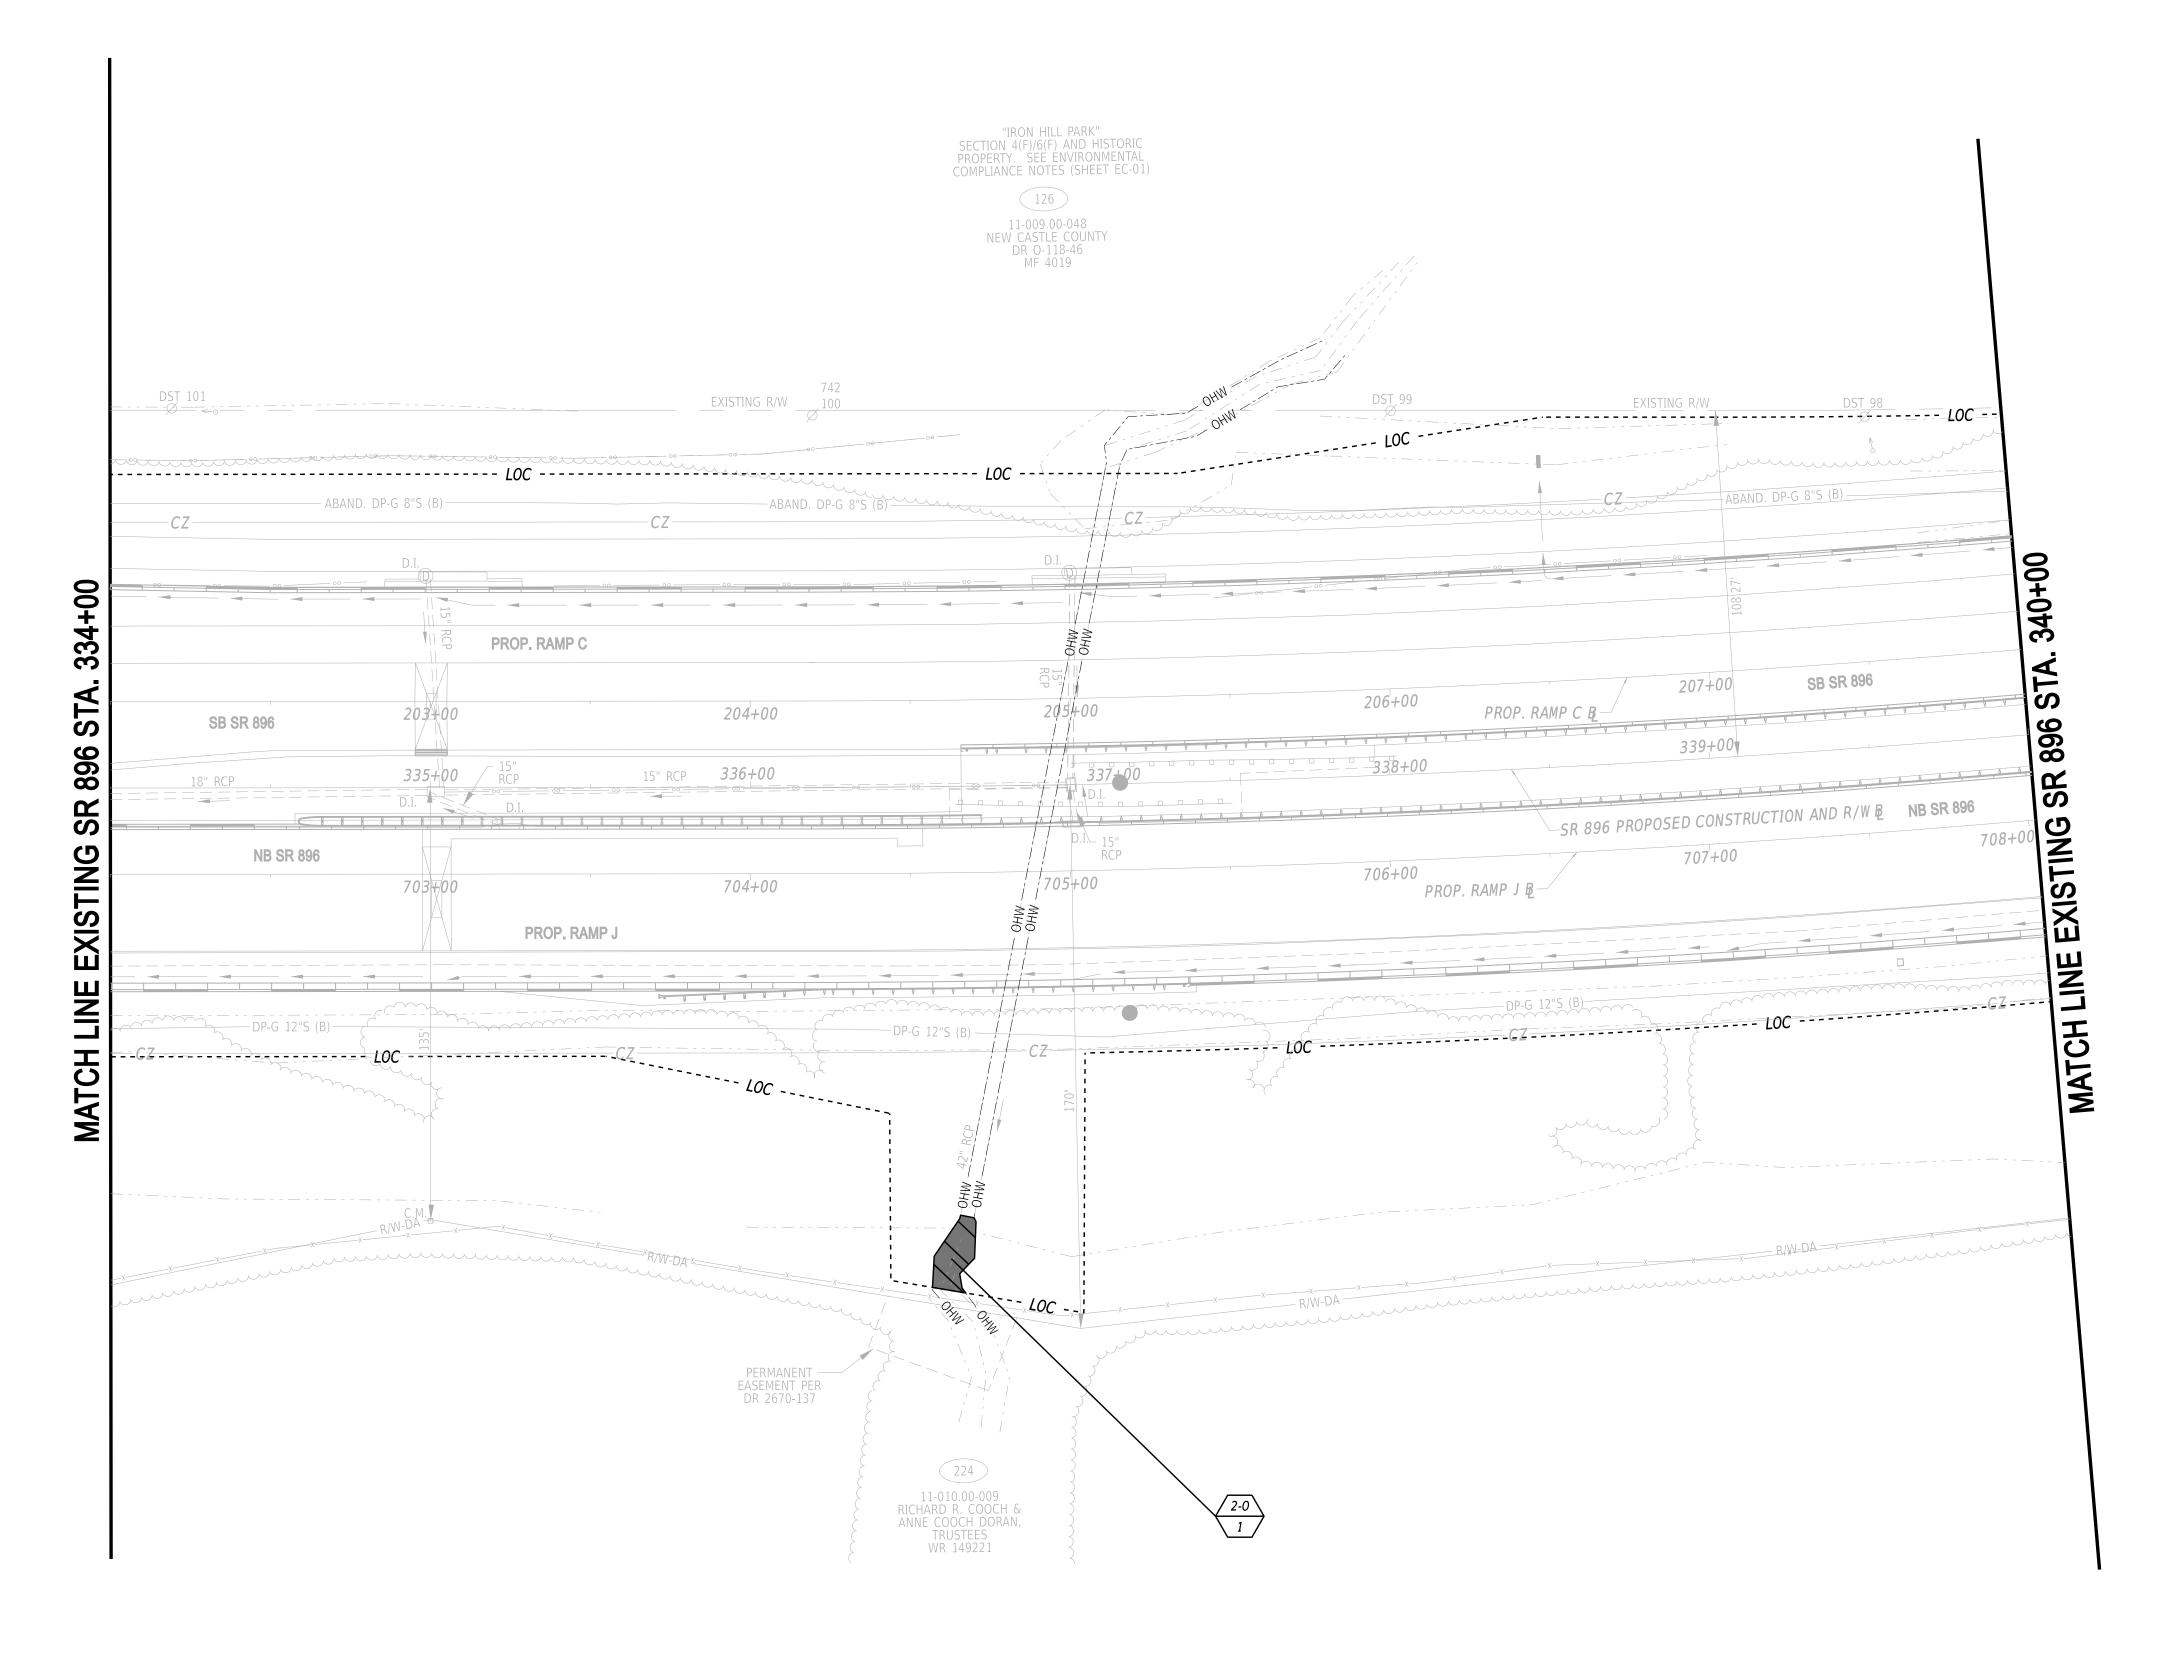

ADDENDA / REVISIONS


I-95 AND SR 896 INTERCHANGE

CONTRACT N/A BRIDGE NO. T201609002 DESIGNED BY: K. FORD COUNTY CHECKED BY: S. PENOZA NEW CASTLE

T = TEMPORARY IMPACT

ENVIRONMENTAL COMPLIANCE PLAN

EC-02 SECTION CE SHEET NO. 1028

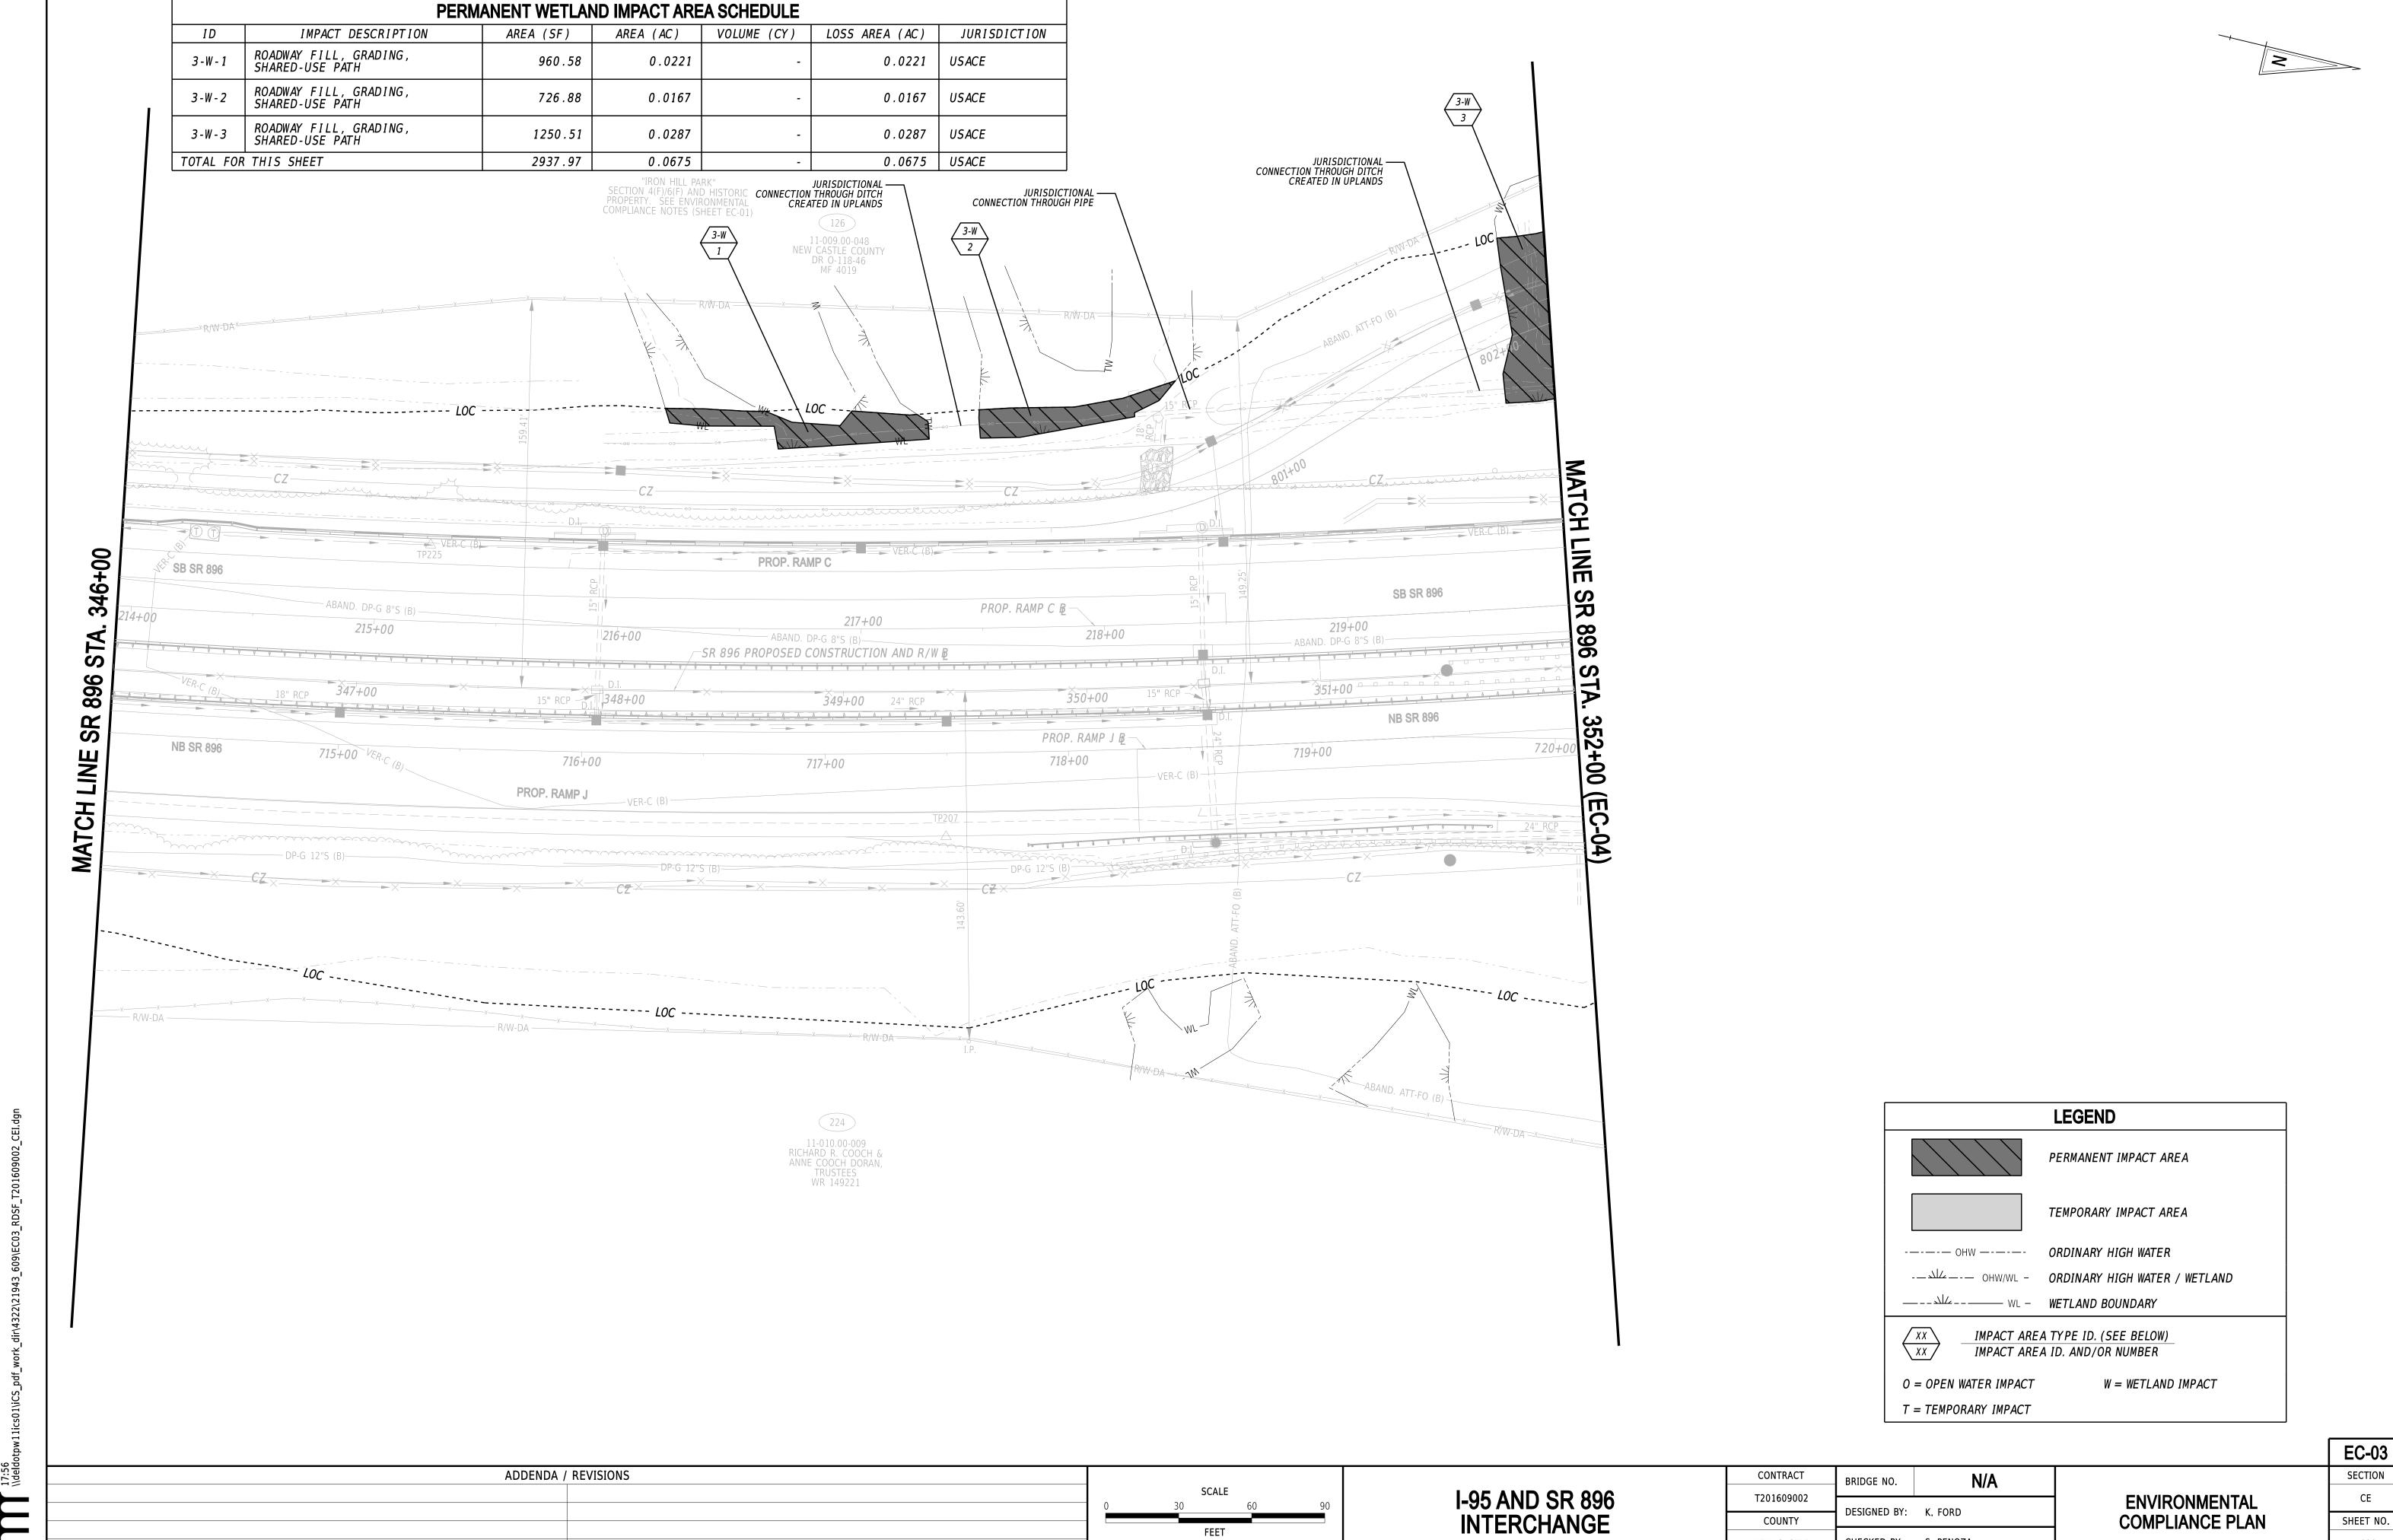


SHEET NO.

1029

COUNTY NEW CASTLE


COMPLIANCE PLAN CHECKED BY: S. PENOZA

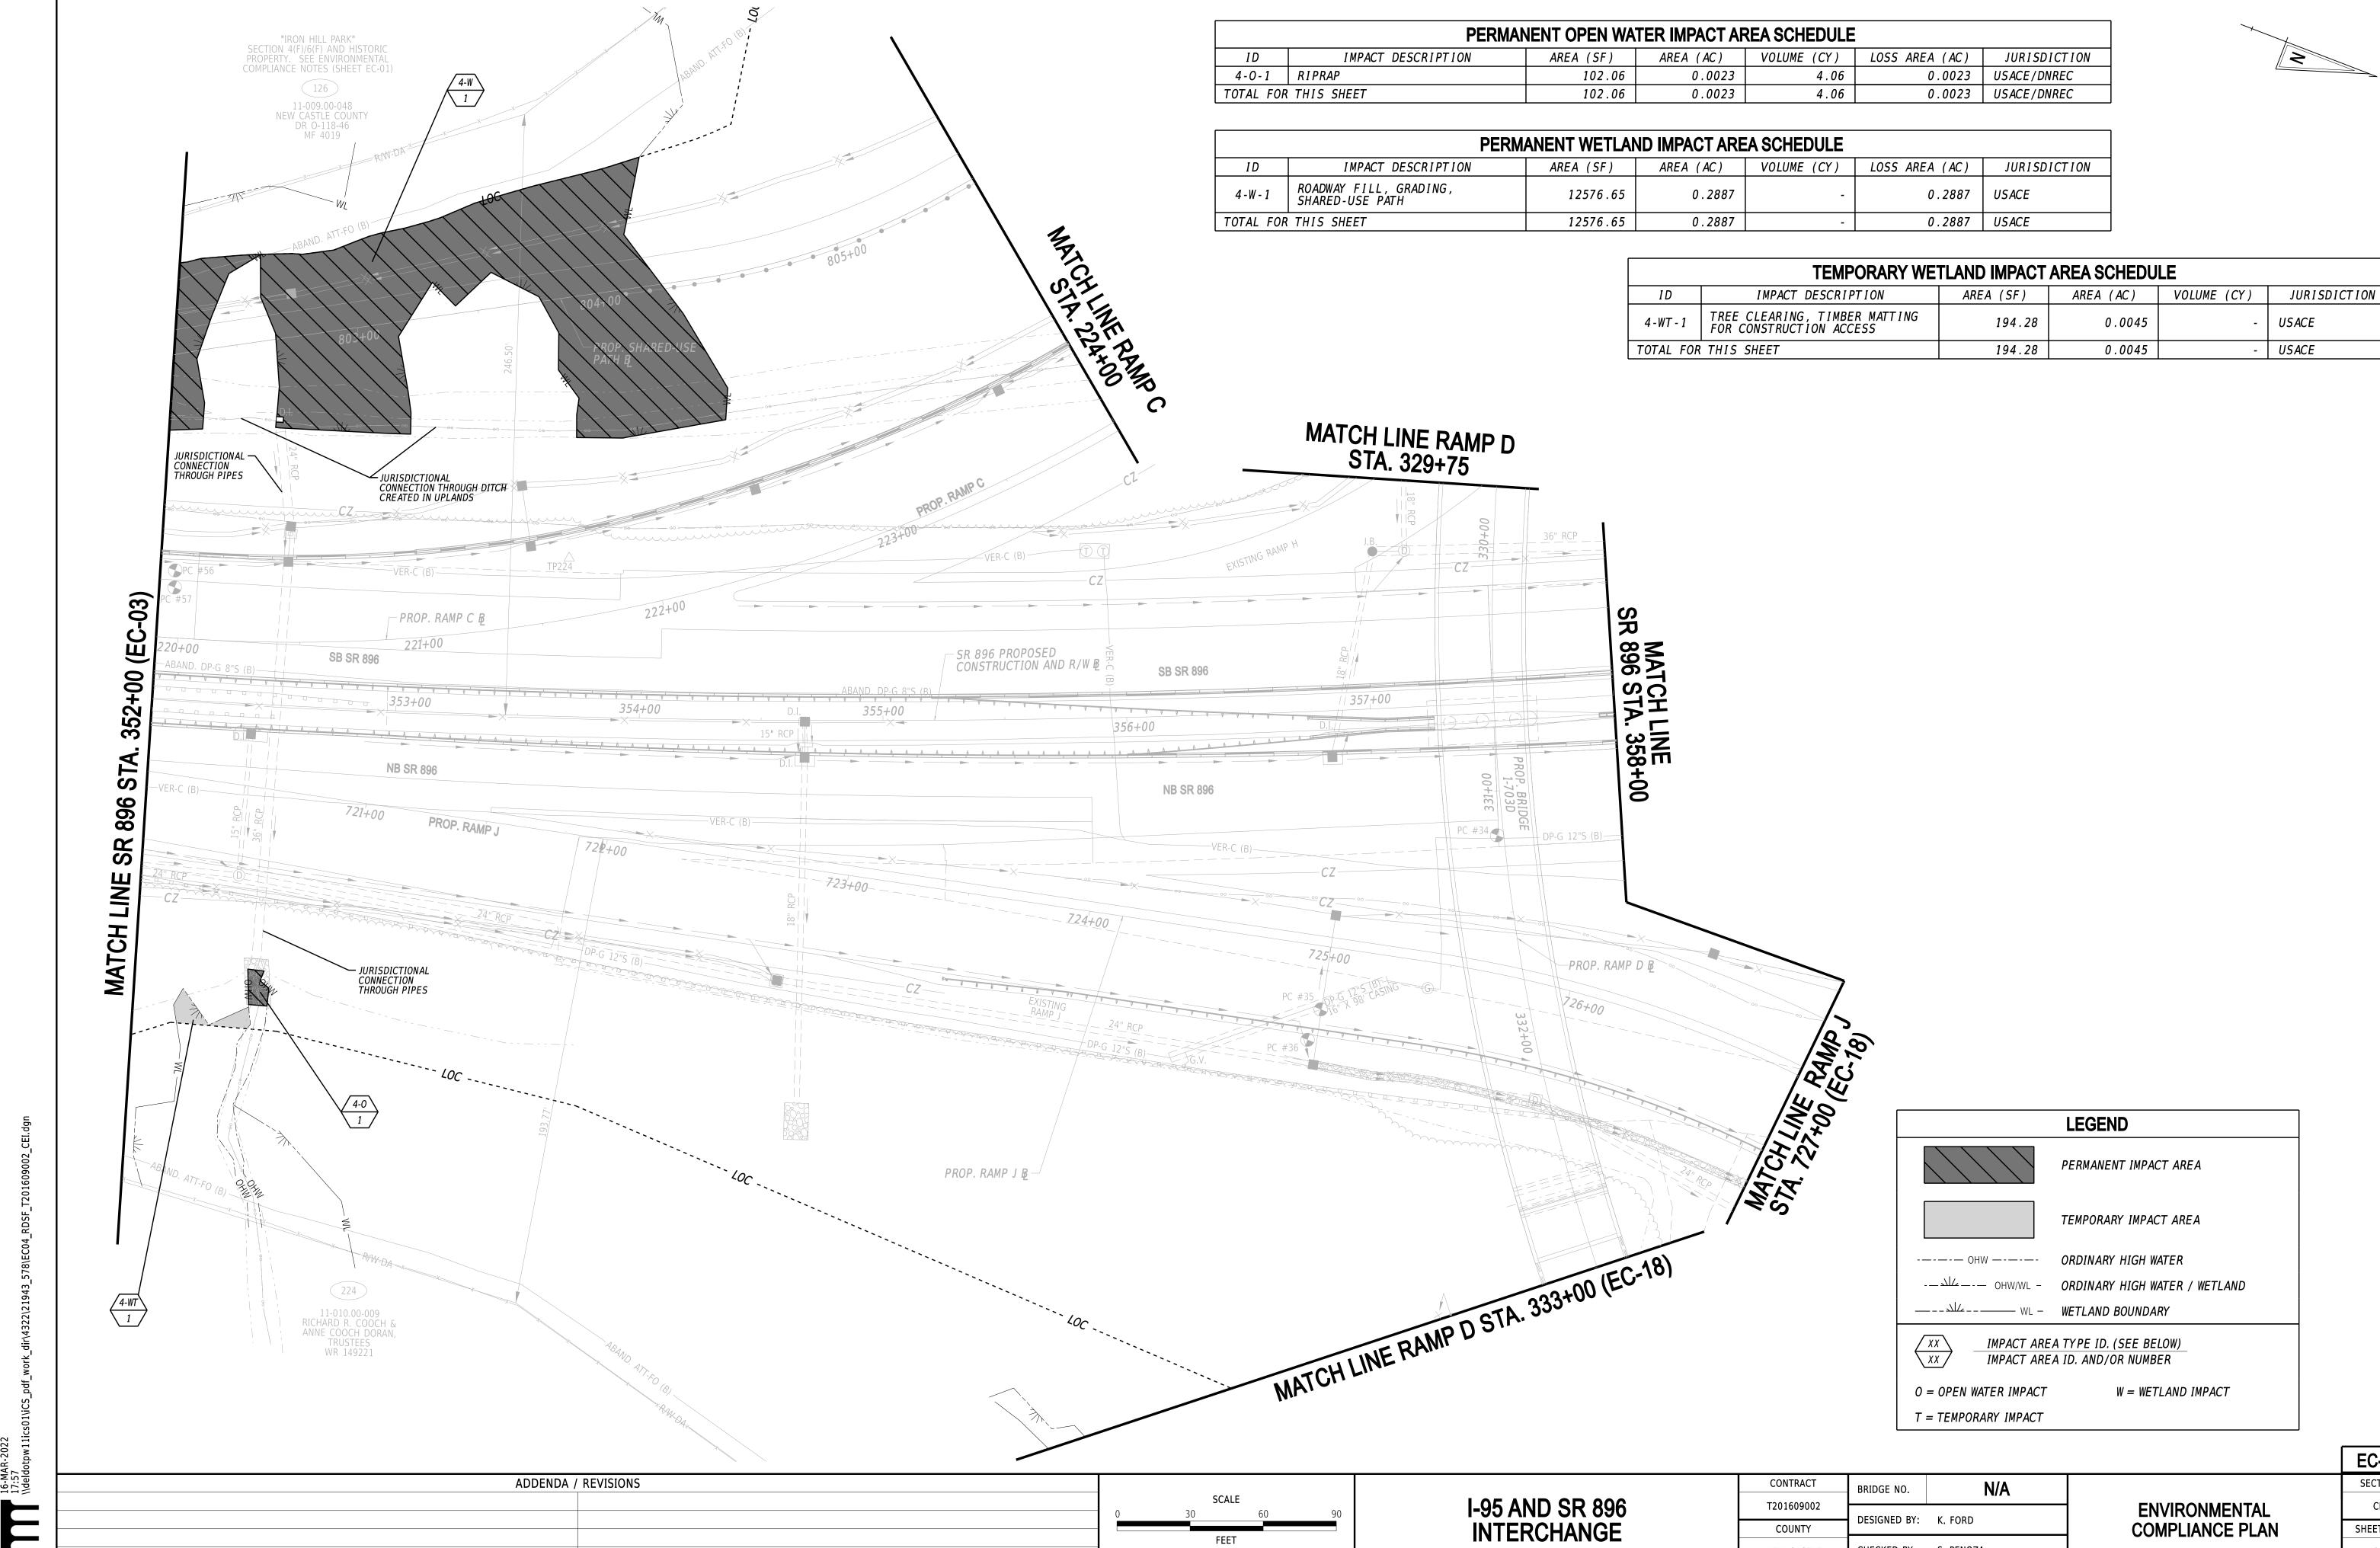


EC-04 SECTION CE SHEET NO. 1030

CHECKED BY: S. PENOZA

NEW CASTLE

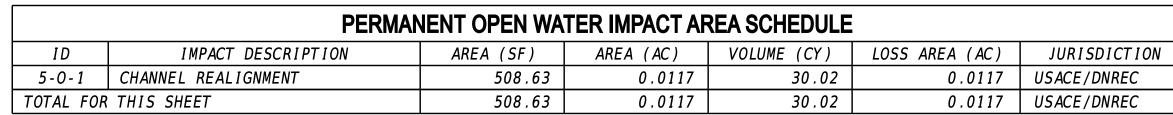

	PERMANENT WETLAND IMPACT AREA SCHEDULE							
I D	IMPACT DESCRIPTION	AREA (SF)	AREA (AC)	VOLUME (CY)	LOSS AREA (AC)	JURISDICTION		
5 - W - 1	ROADWAY FILL, POND GRADING, DRAINAGE PIPES, FLARED END SECTIONS, RIPRAP, CHANNEL REALIGNMENT	7718.95	0.1772	,	0.1772	USACE		
TOTAL FOR	THIS SHEET	7718.95	0.1772	-	0.1772	USACE		

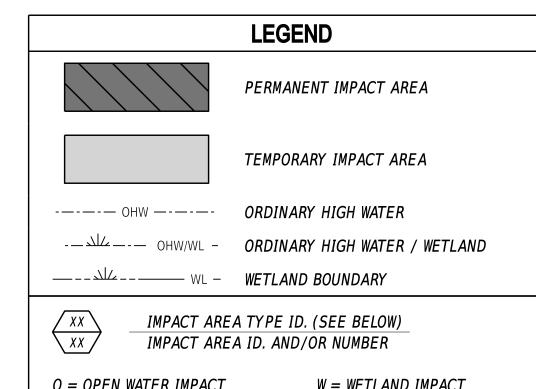

O = OPEN WATER IMPACT

W = WETLAND IMPACT

T = TEMPORARY IMPACT

CONTRACT N/A BRIDGE NO. T201609002 DESIGNED BY: K. FORD COUNTY


NEW CASTLE


ENVIRONMENTAL **COMPLIANCE PLAN** **EC-05** CE


I-95 AND SR 896 INTERCHANGE

CHECKED BY: S. PENOZA


SHEET NO. 1031

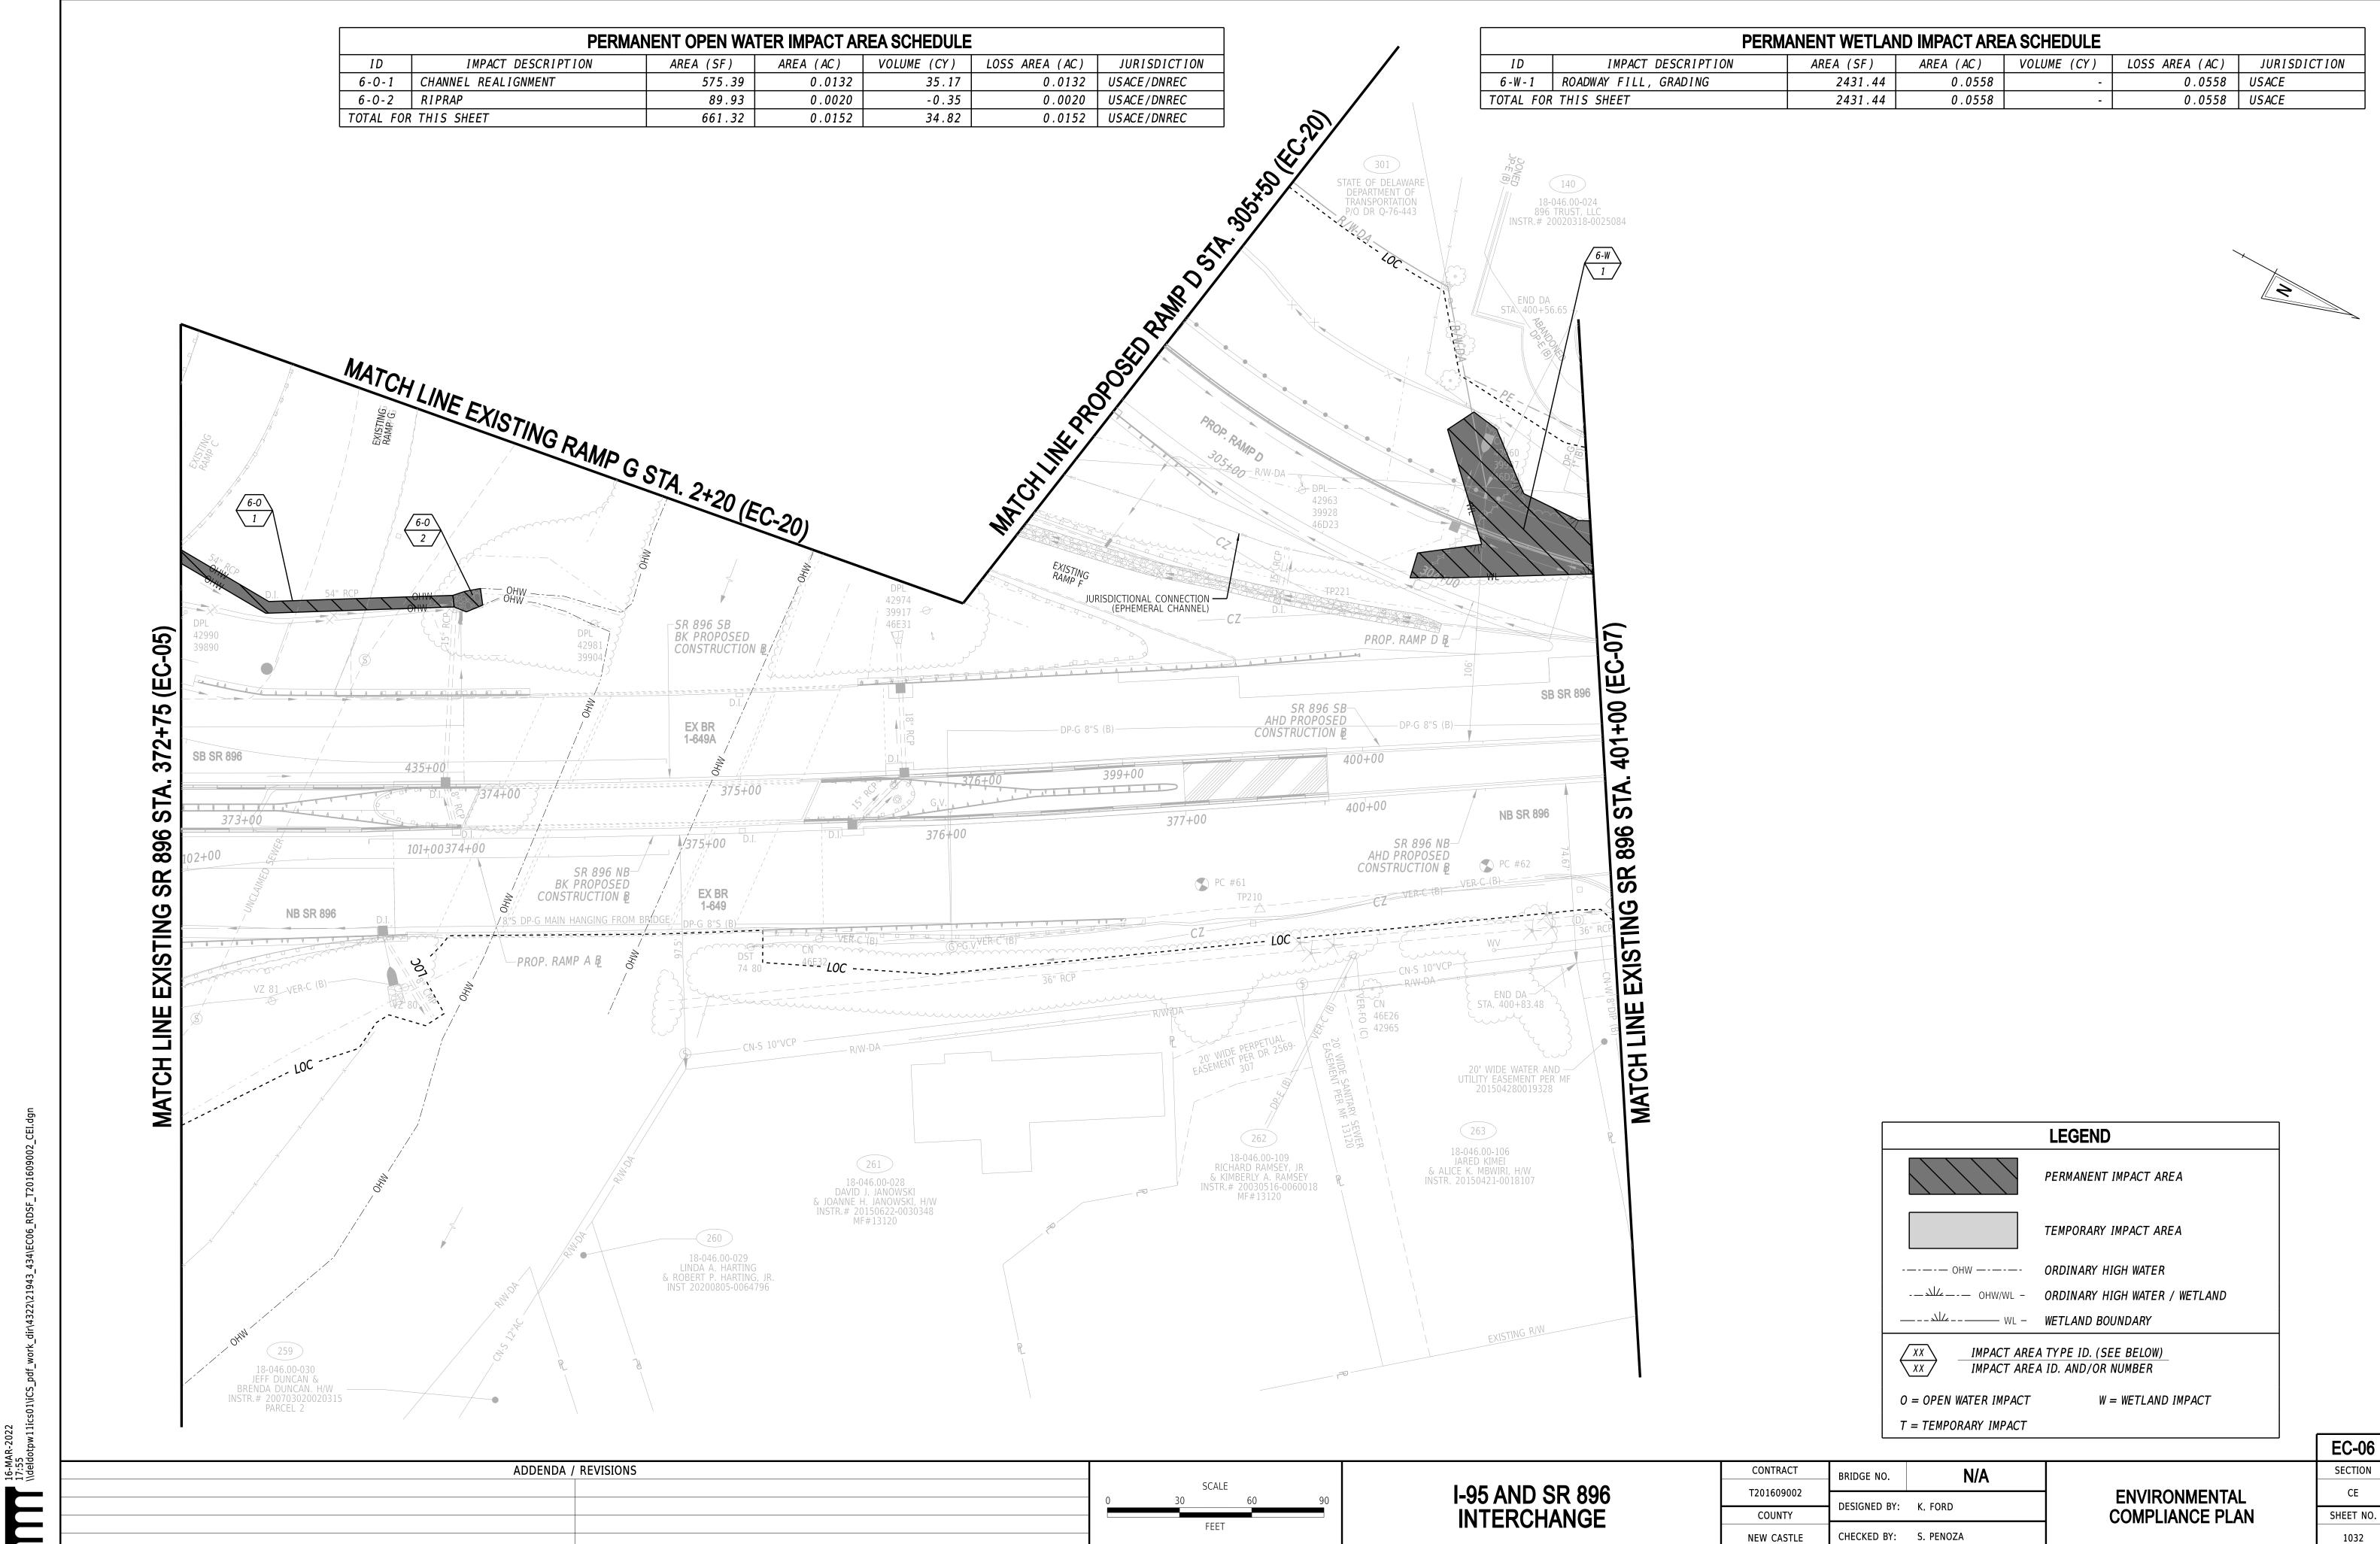

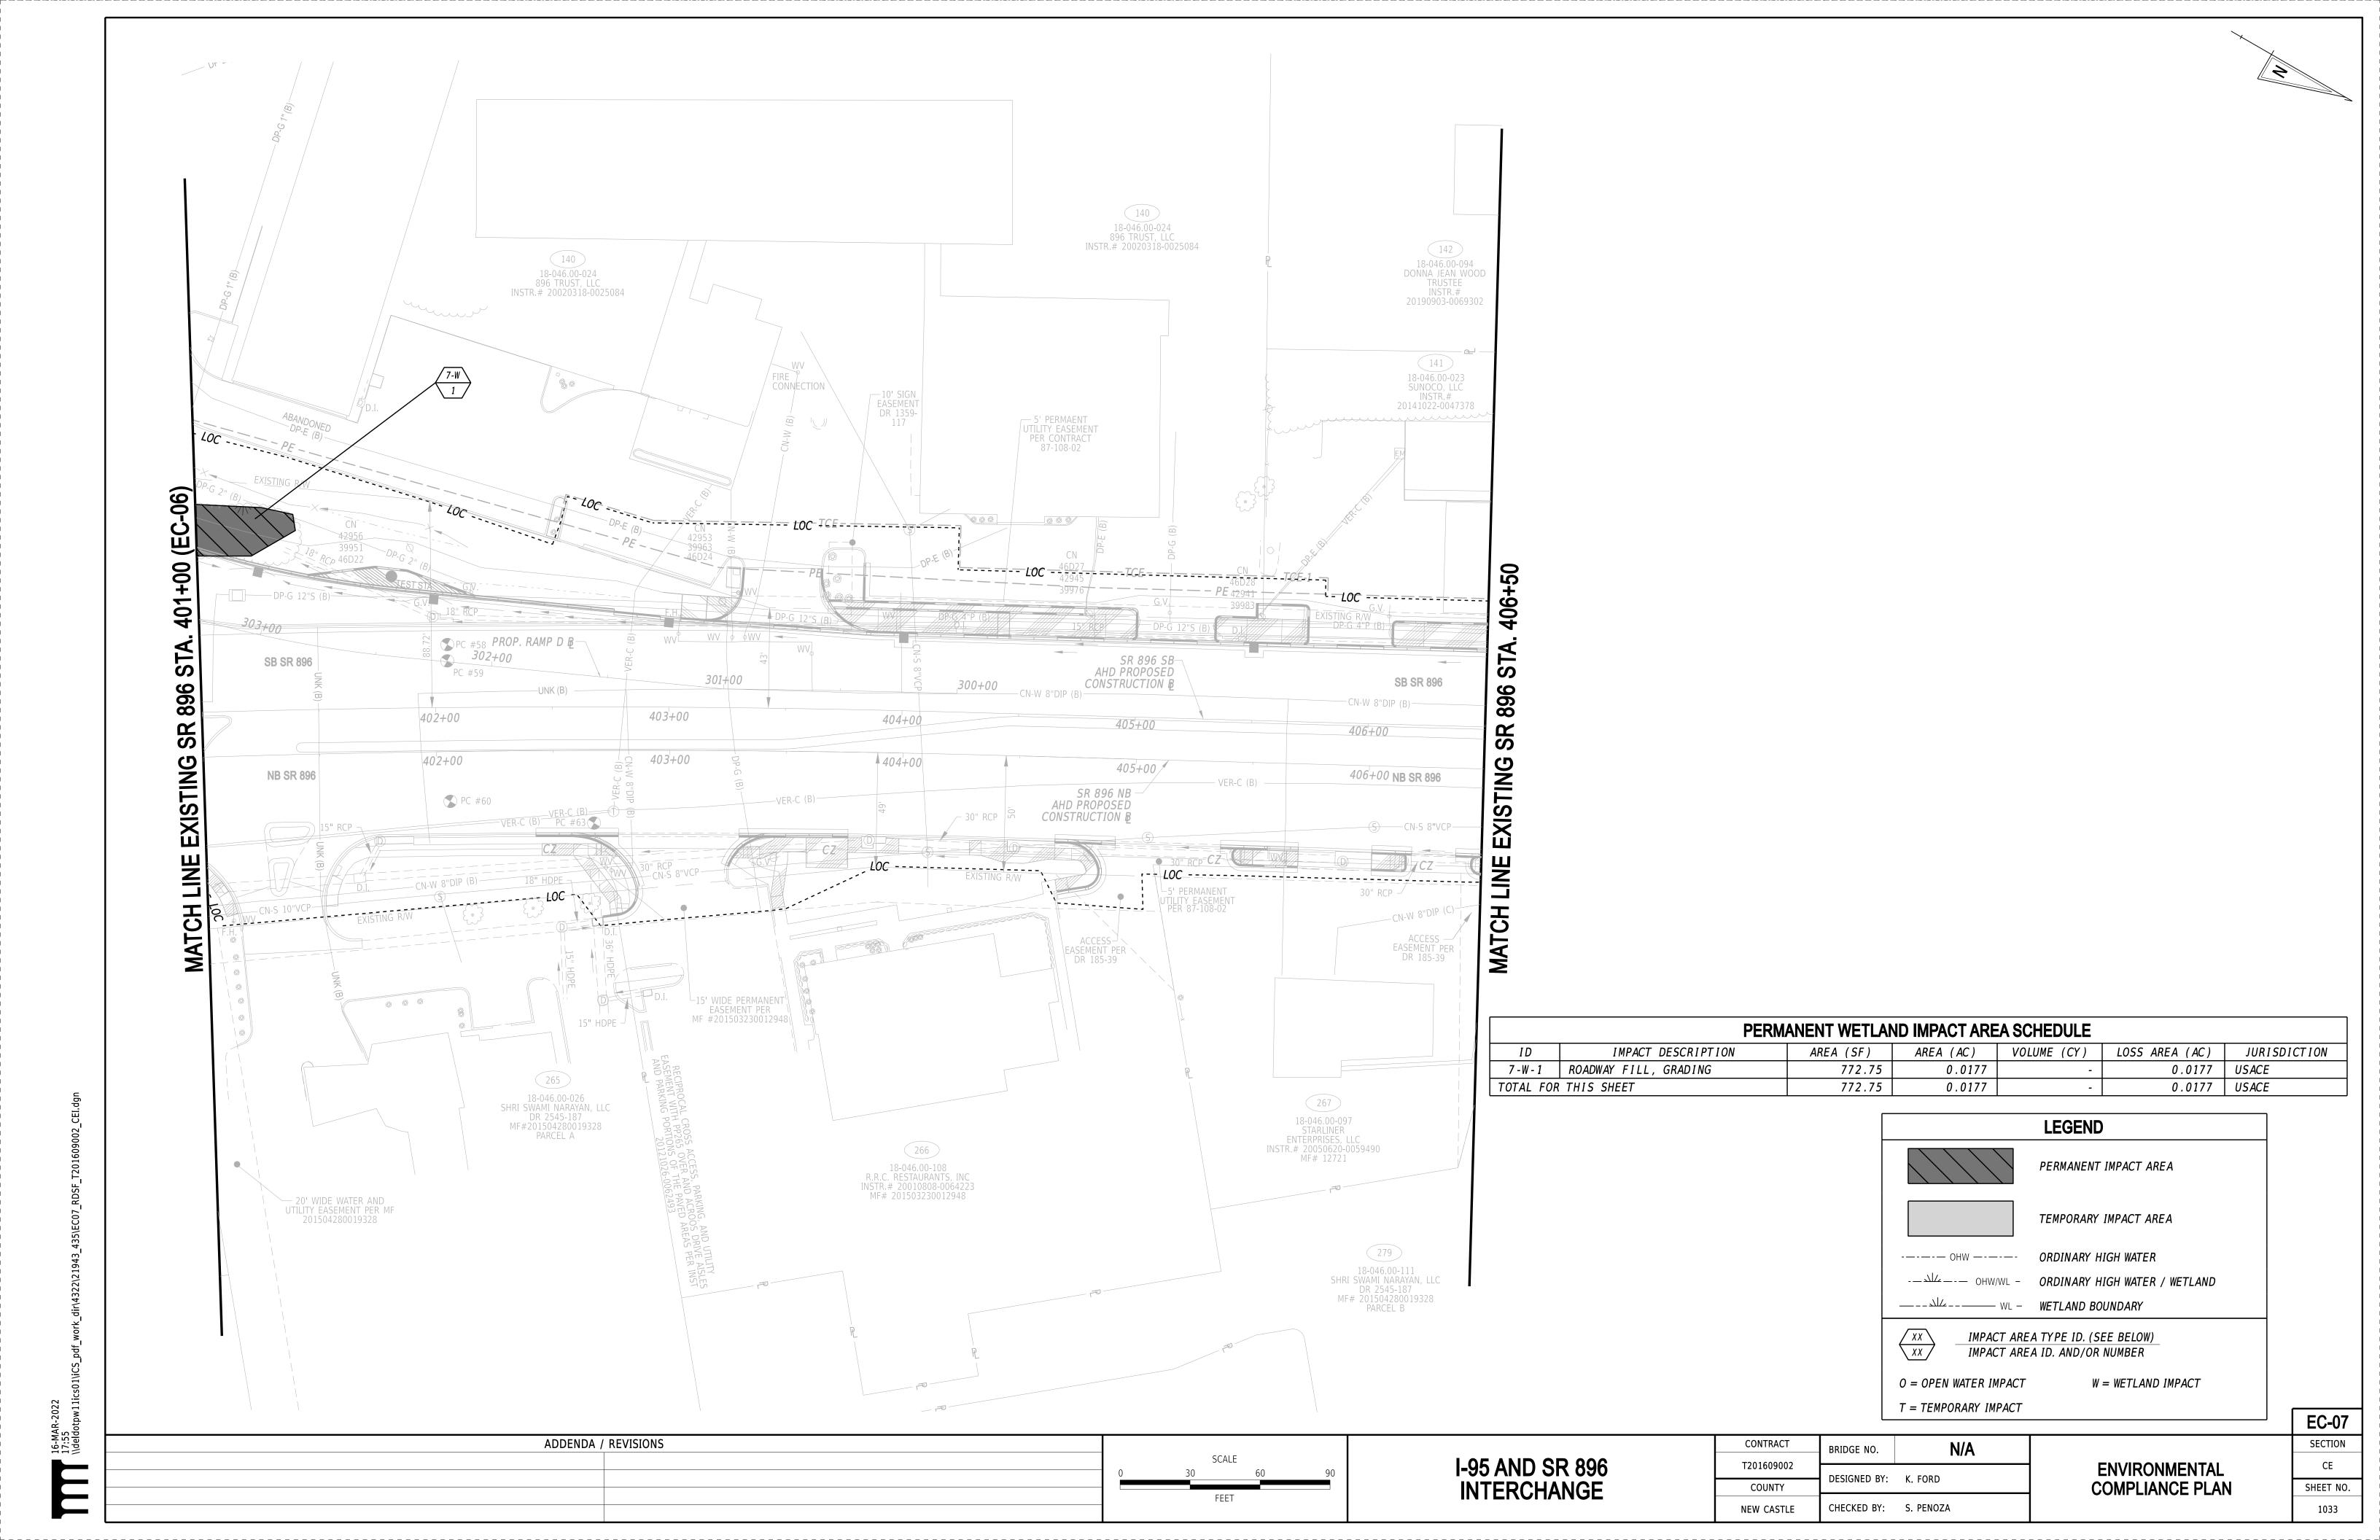

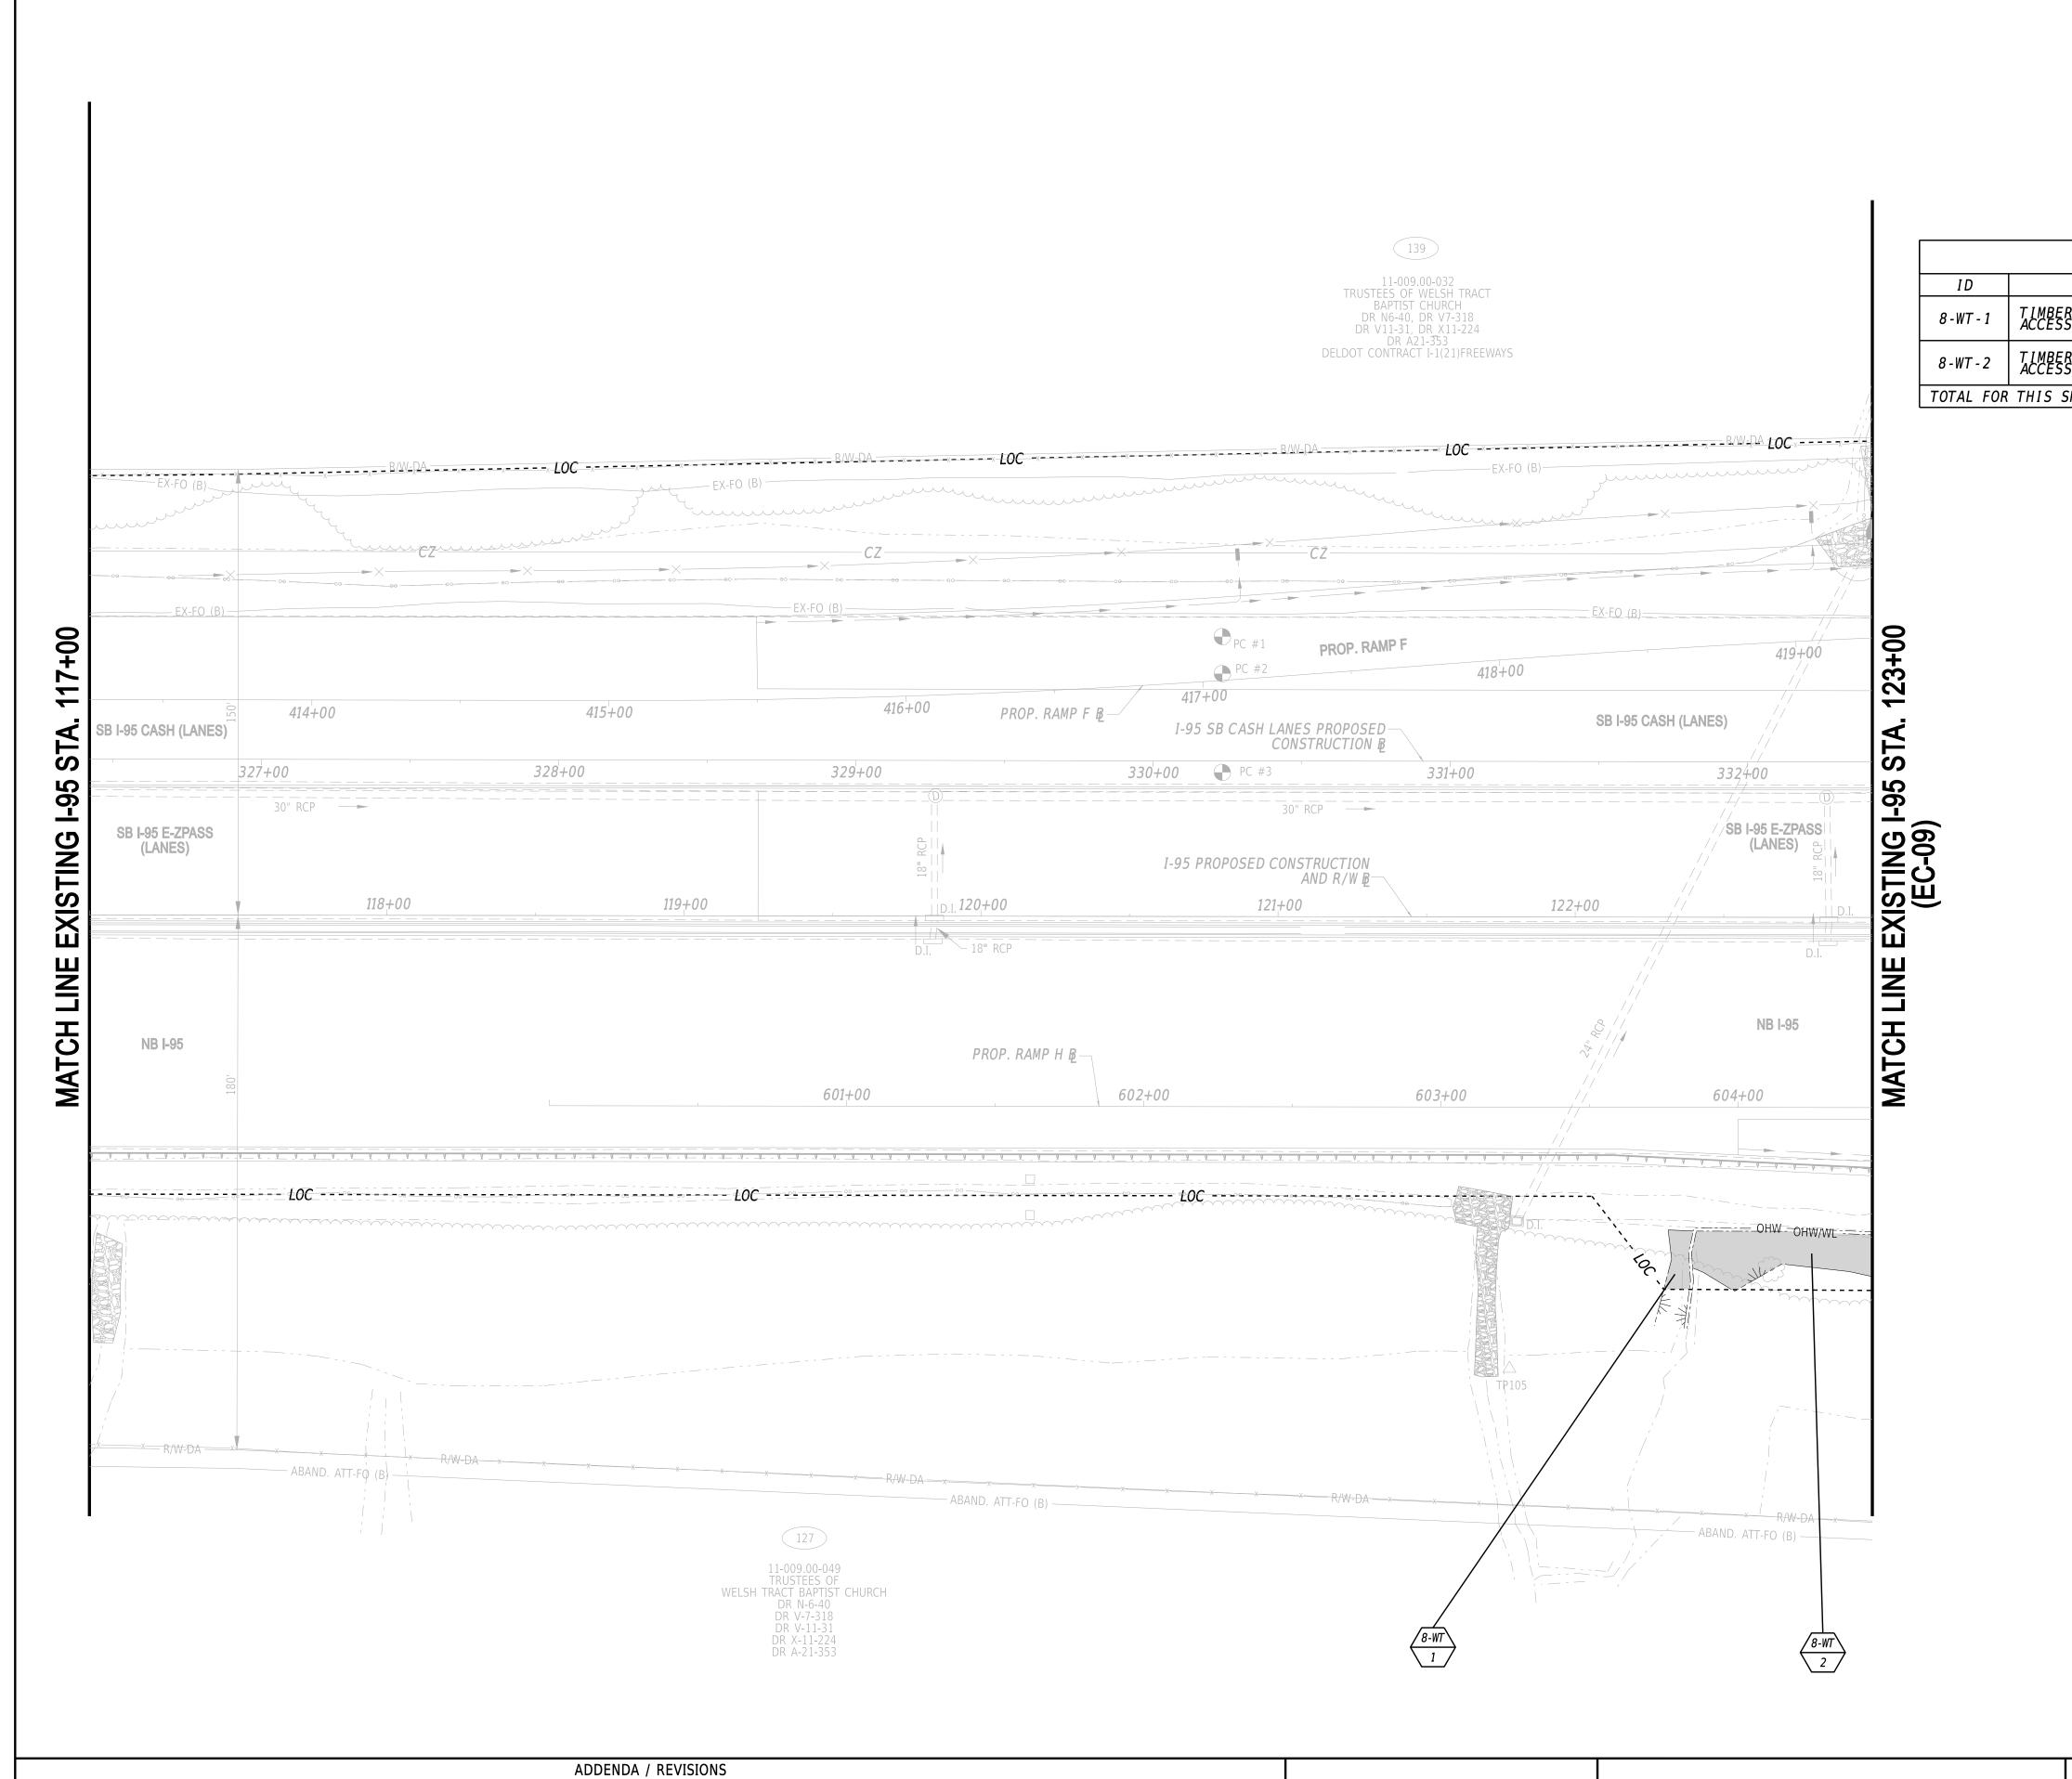

TEMPORARY WETLAND IMPACT AREA SCHEDULE IMPACT DESCRIPTION AREA (SF) AREA (AC) VOLUME (CY) JURISDICTION TIMBER MATTING FOR CONSTRUCTION ACCESS USACE 0.0033 143.86 845.86 0.0194 USACE 989.72 0.0227 TOTAL FOR THIS SHEET USACE

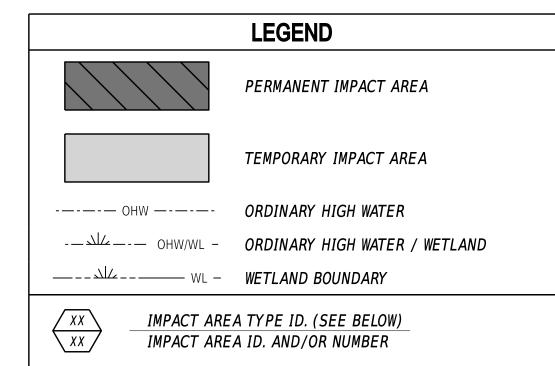

CONTRACT

T201609002

COUNTY

NEW CASTLE

I-95 AND SR 896 INTERCHANGE

W = WETLAND IMPACT

T = TEMPORARY IMPACT


O = OPEN WATER IMPACT

N/A BRIDGE NO. DESIGNED BY: K. FORD

CHECKED BY: S. PENOZA


EC-08 CE SHEET NO.

ENVIRONMENTAL COMPLIANCE PLAN

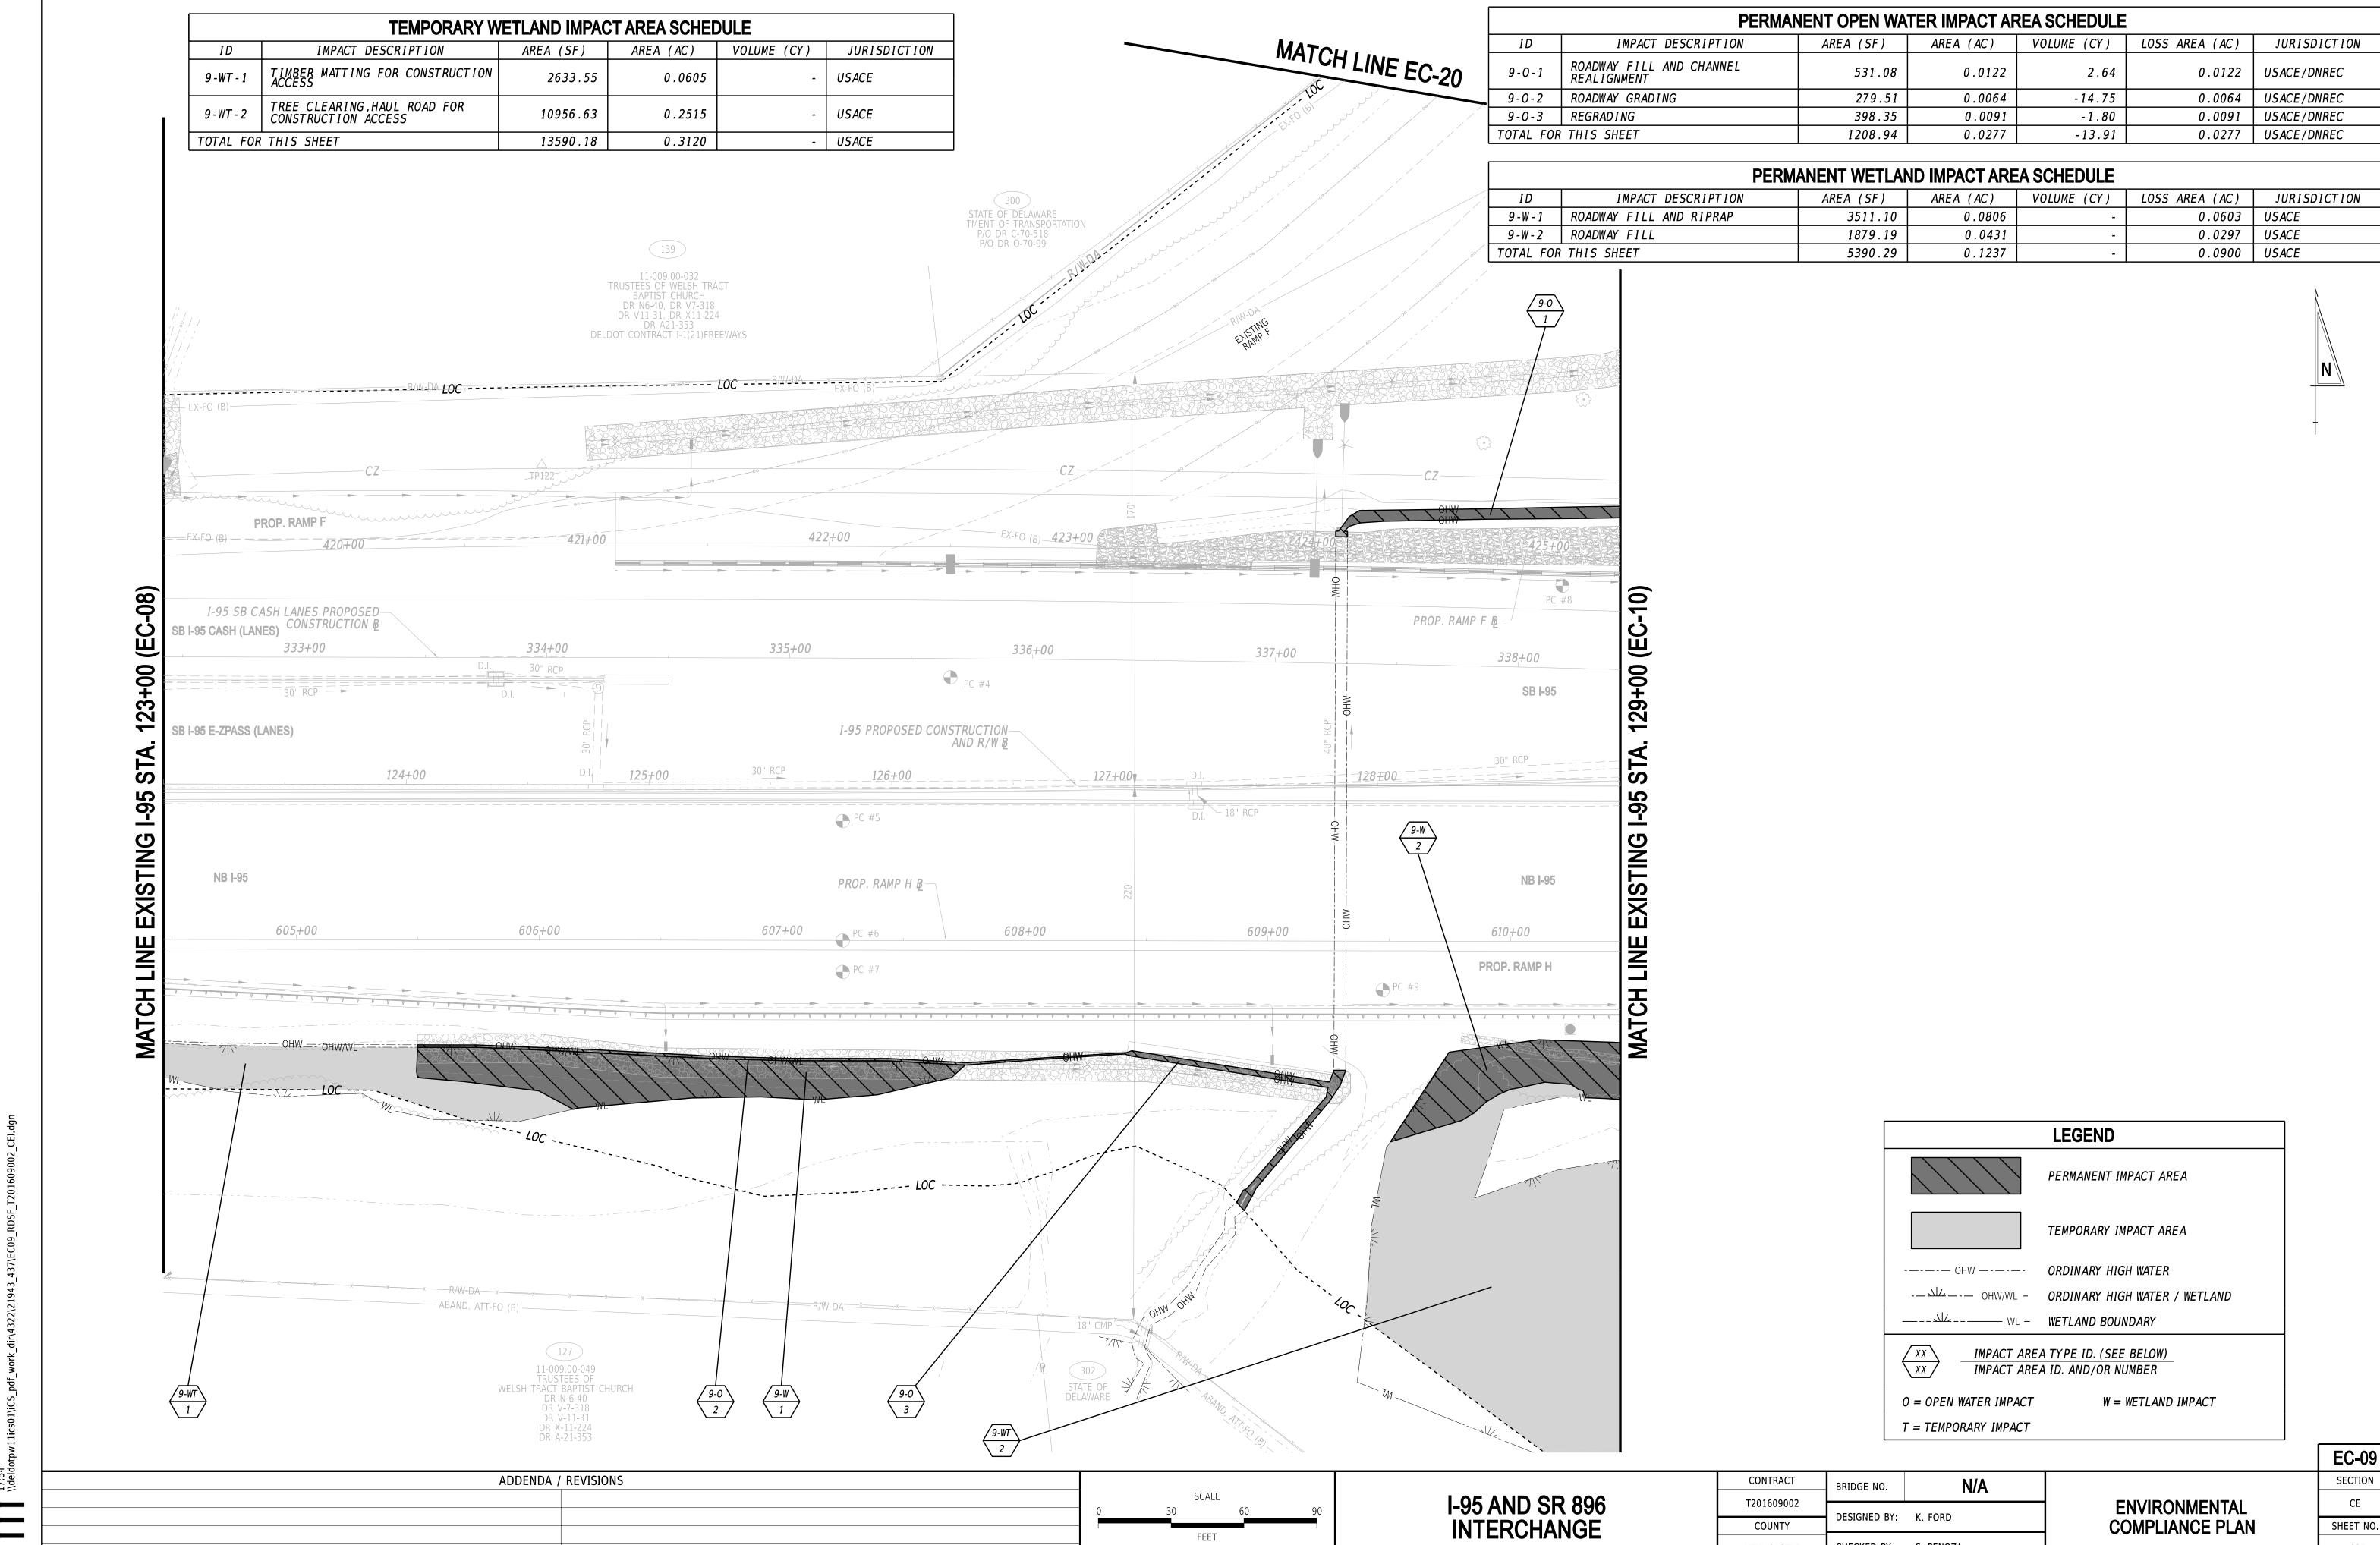

CHECKED BY: S. PENOZA NEW CASTLE


SECTION CE SHEET NO. 1035

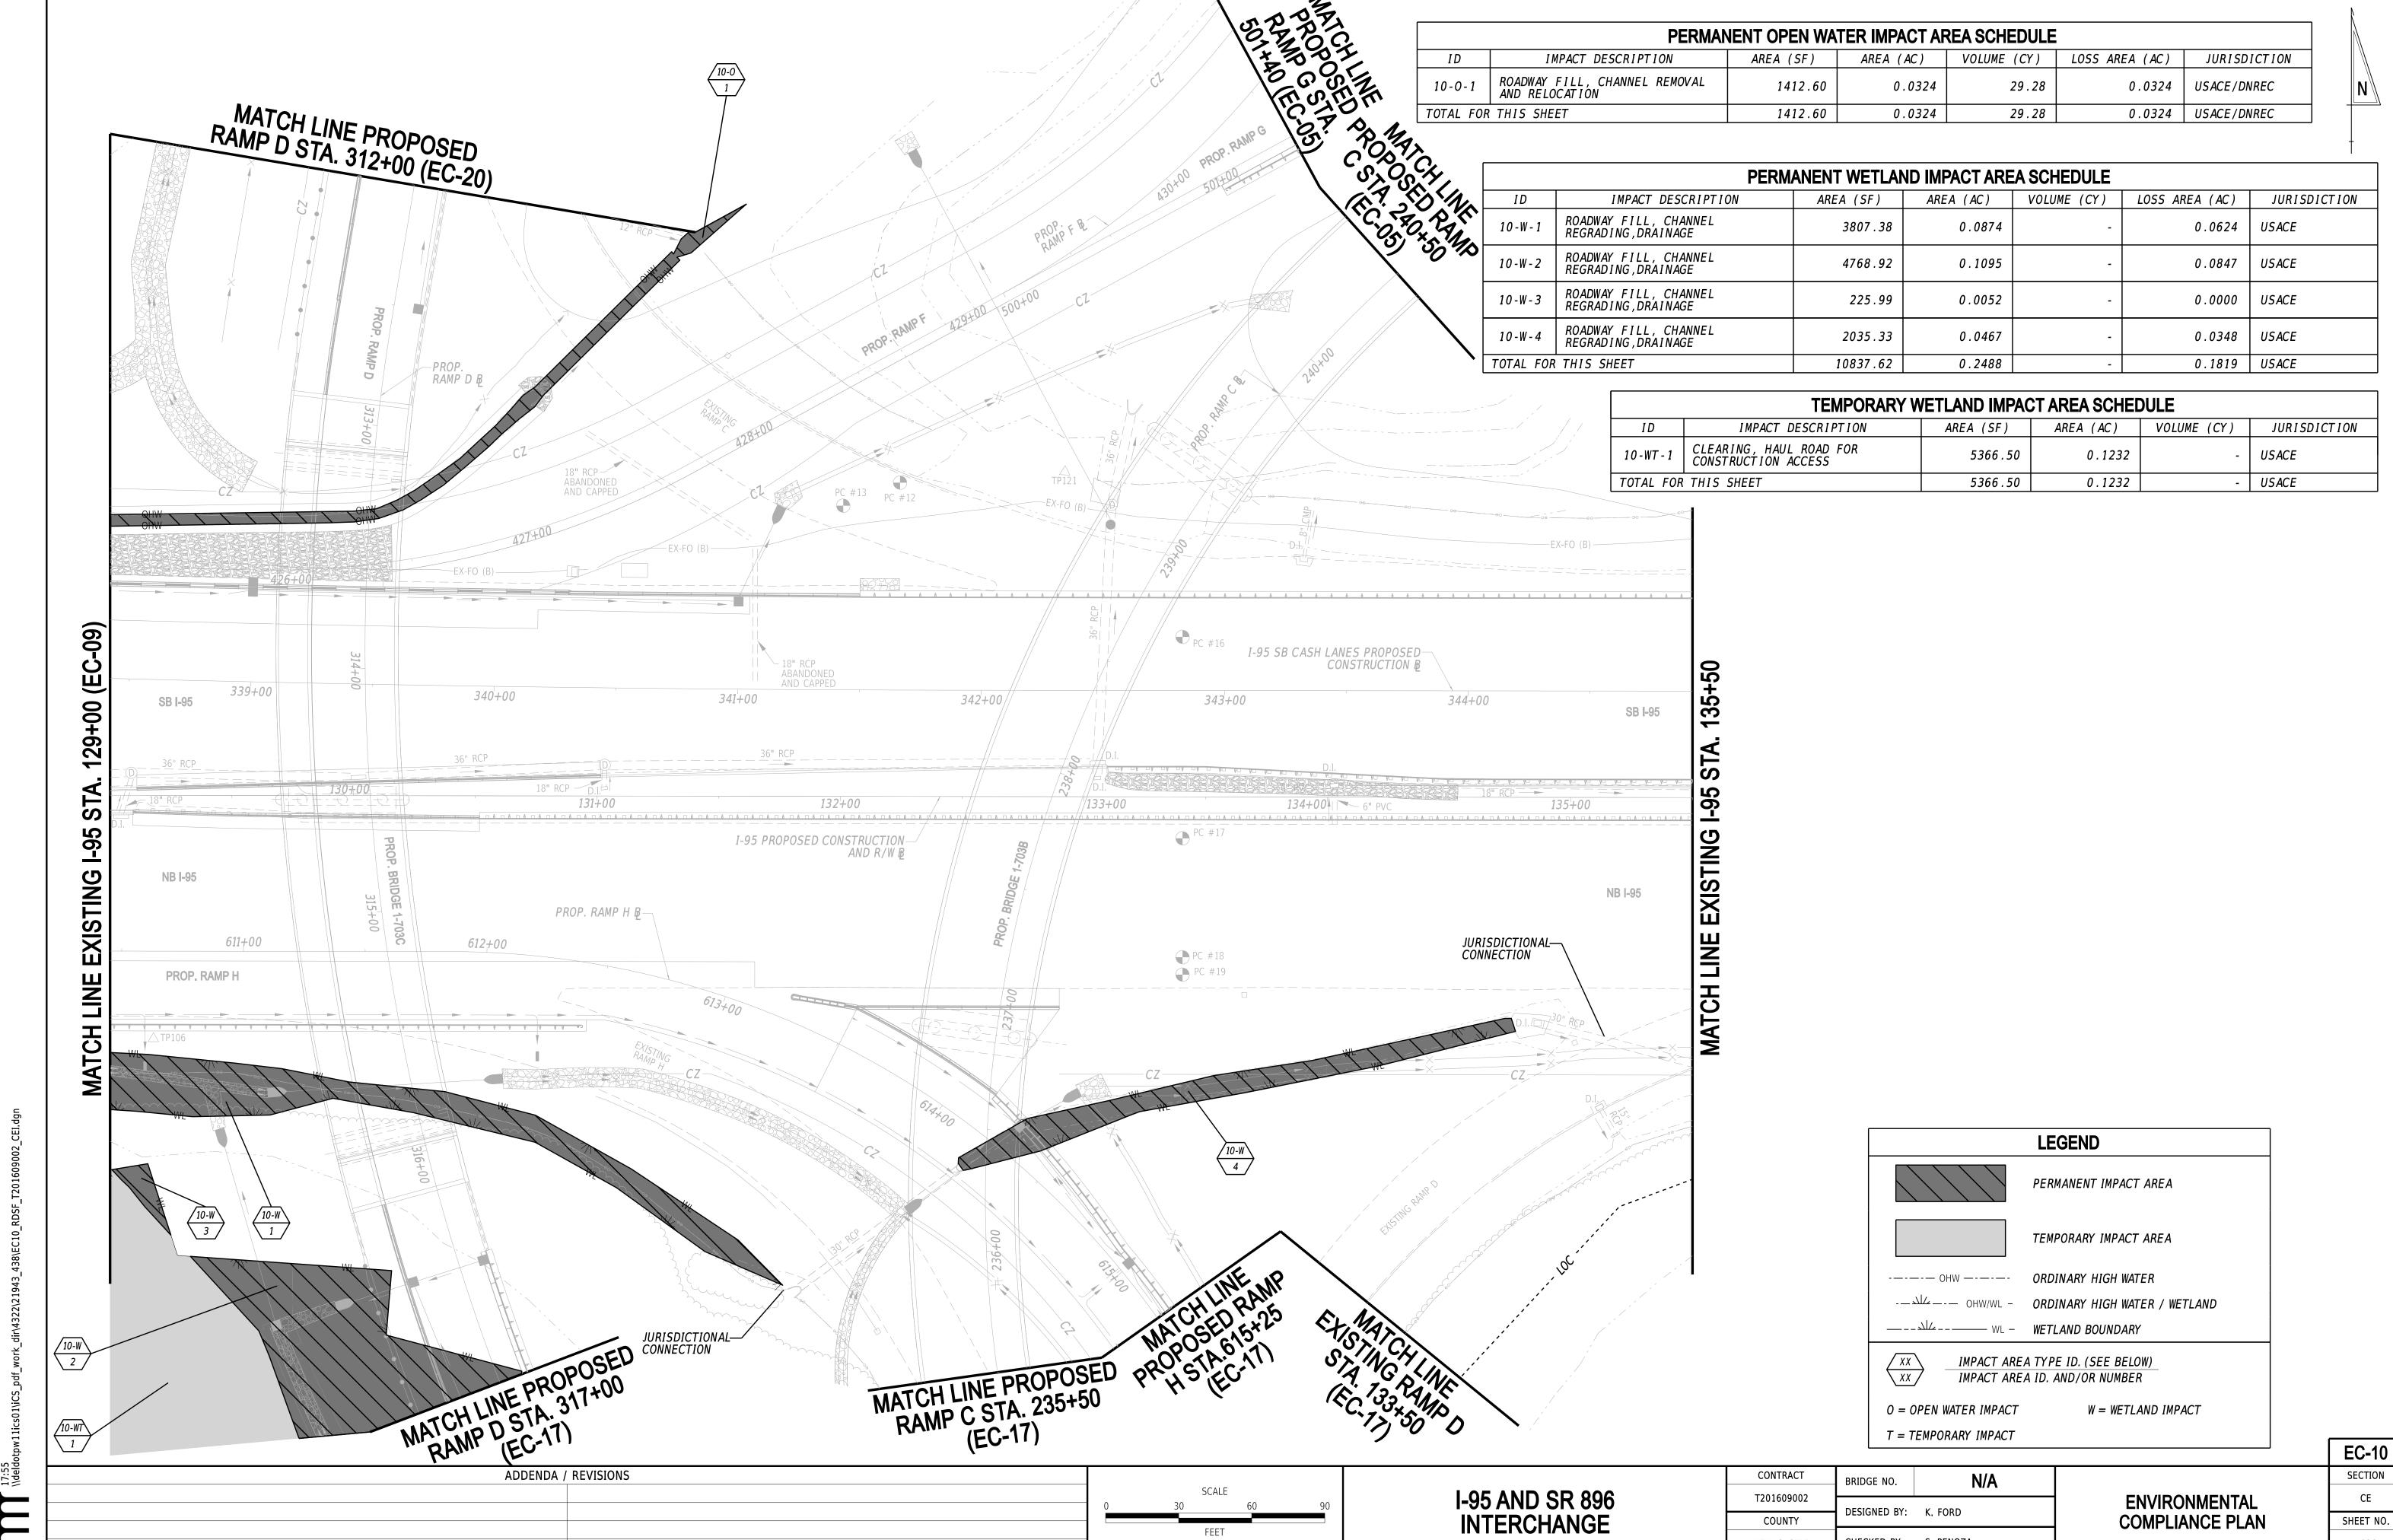

SECTION CE SHEET NO. 1036

CHECKED BY: S. PENOZA


NEW CASTLE

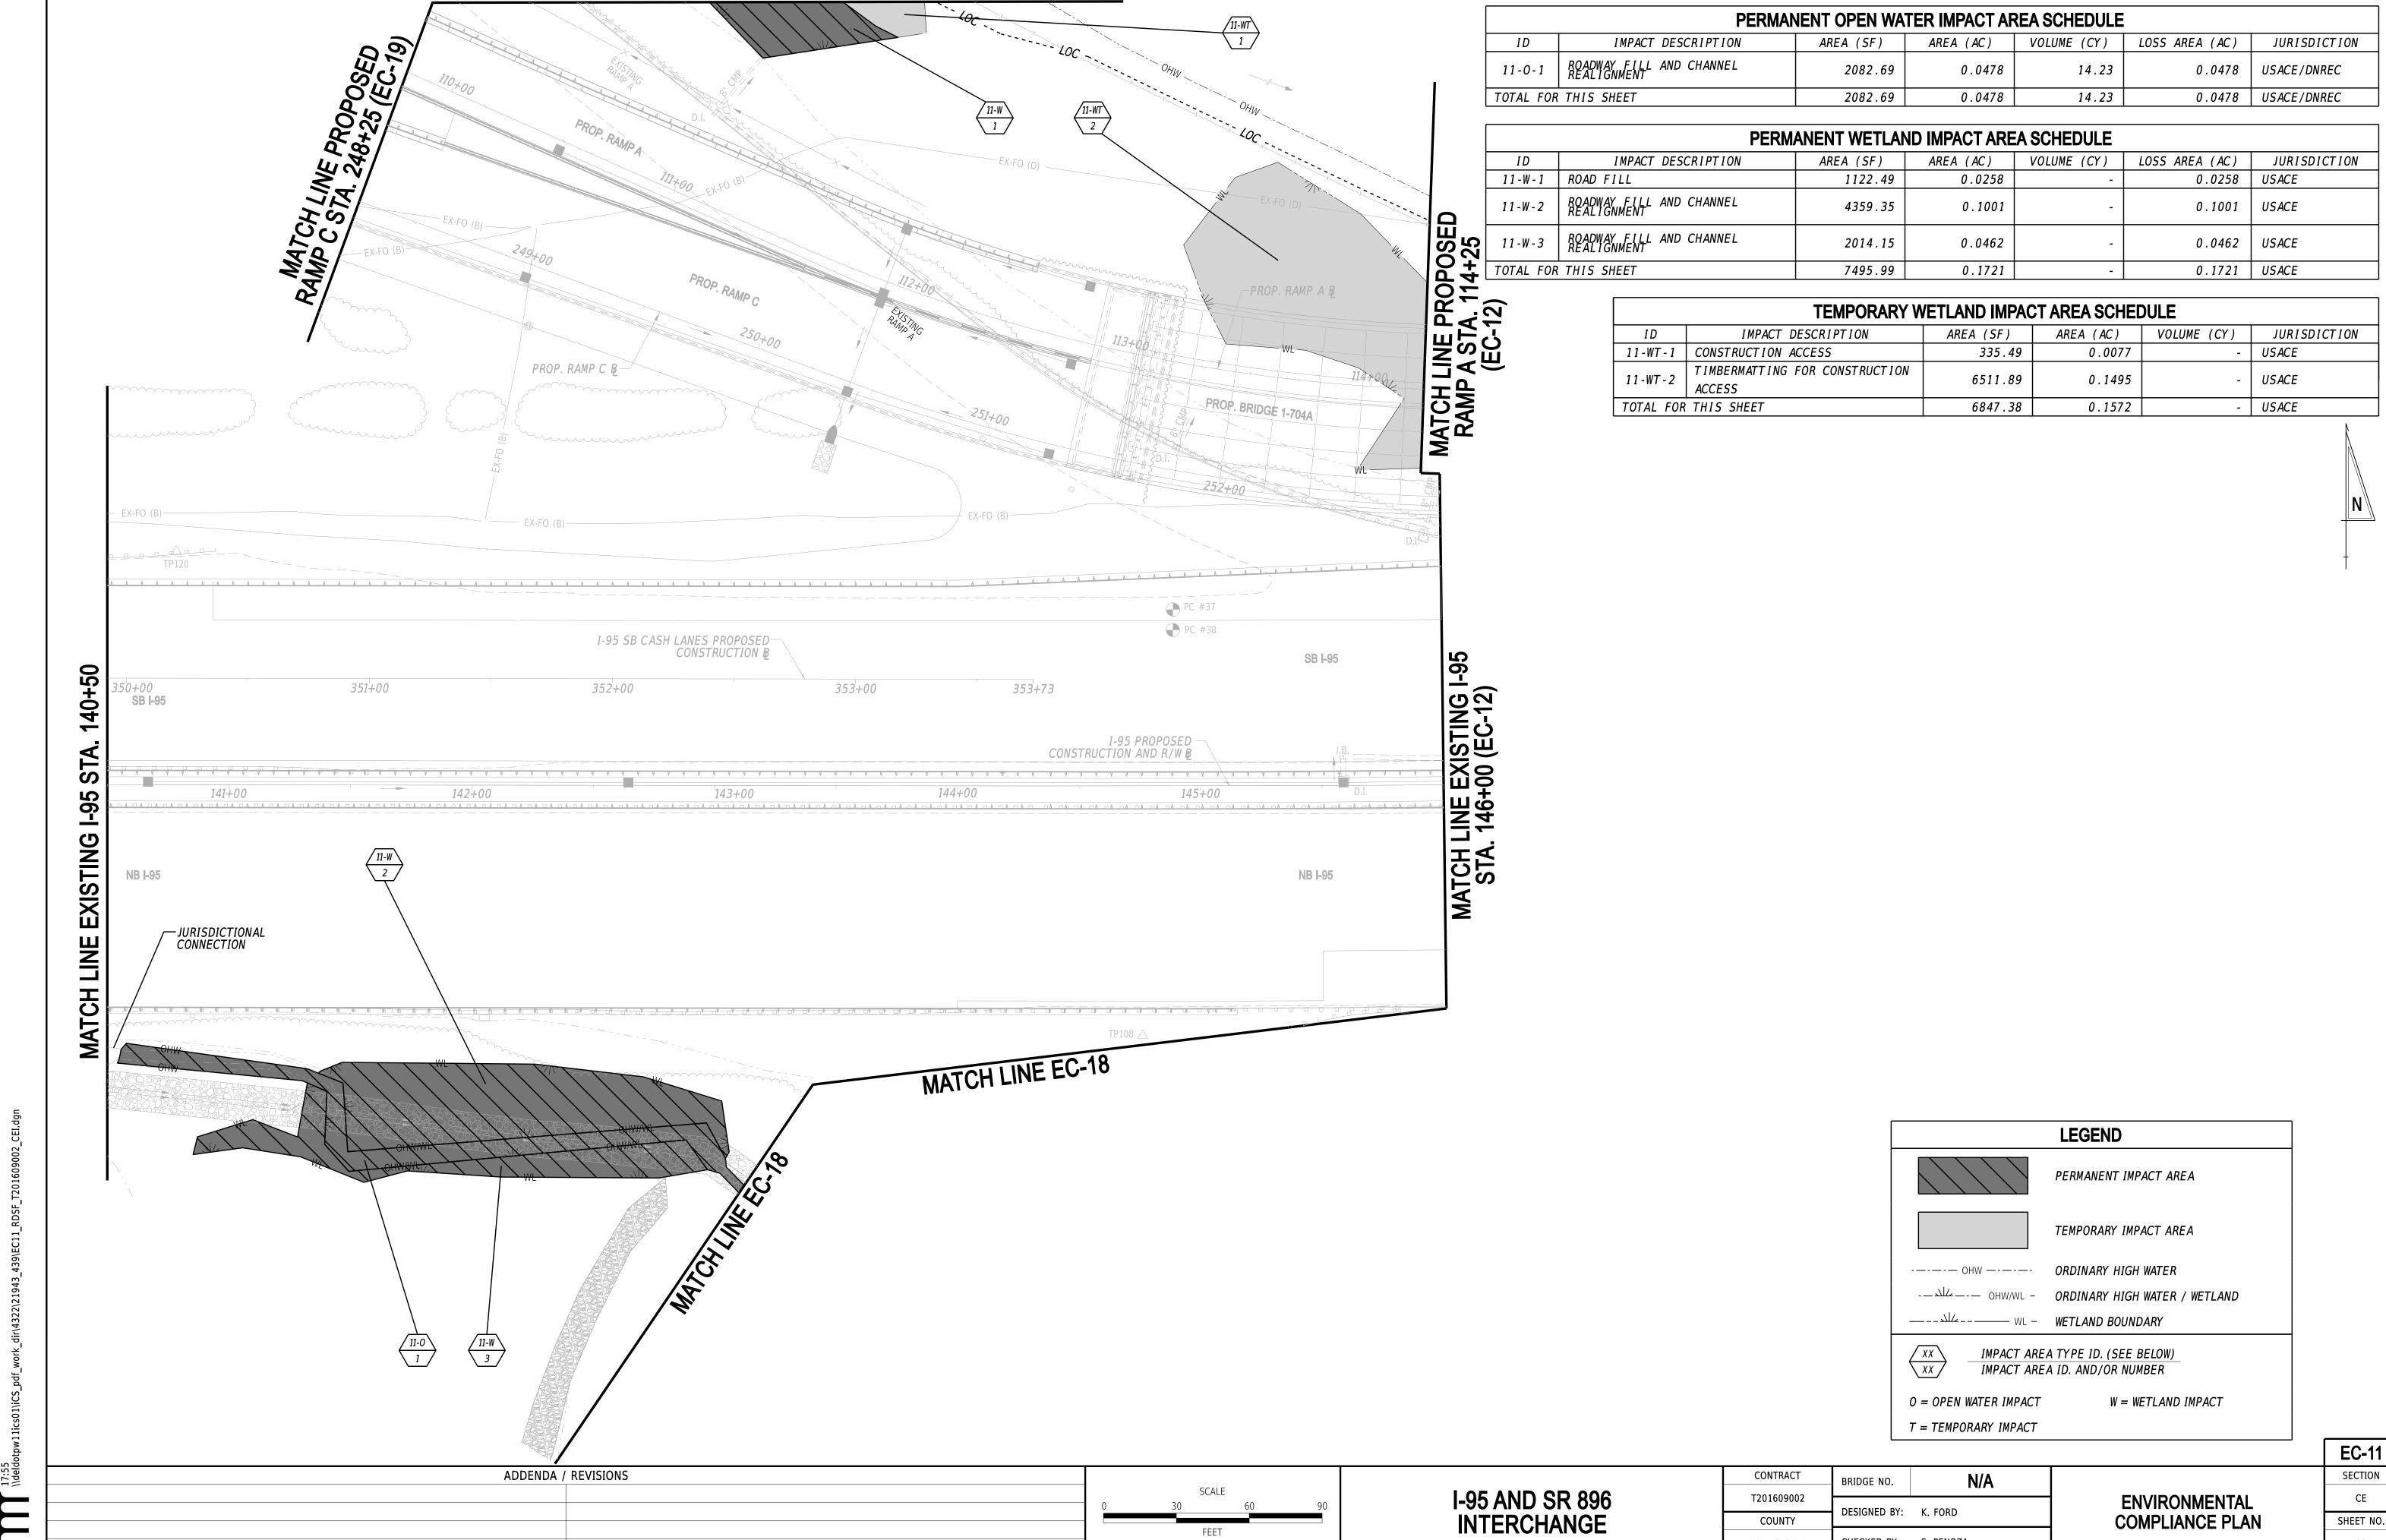

SHEET NO.

CHECKED BY: S. PENOZA


NEW CASTLE

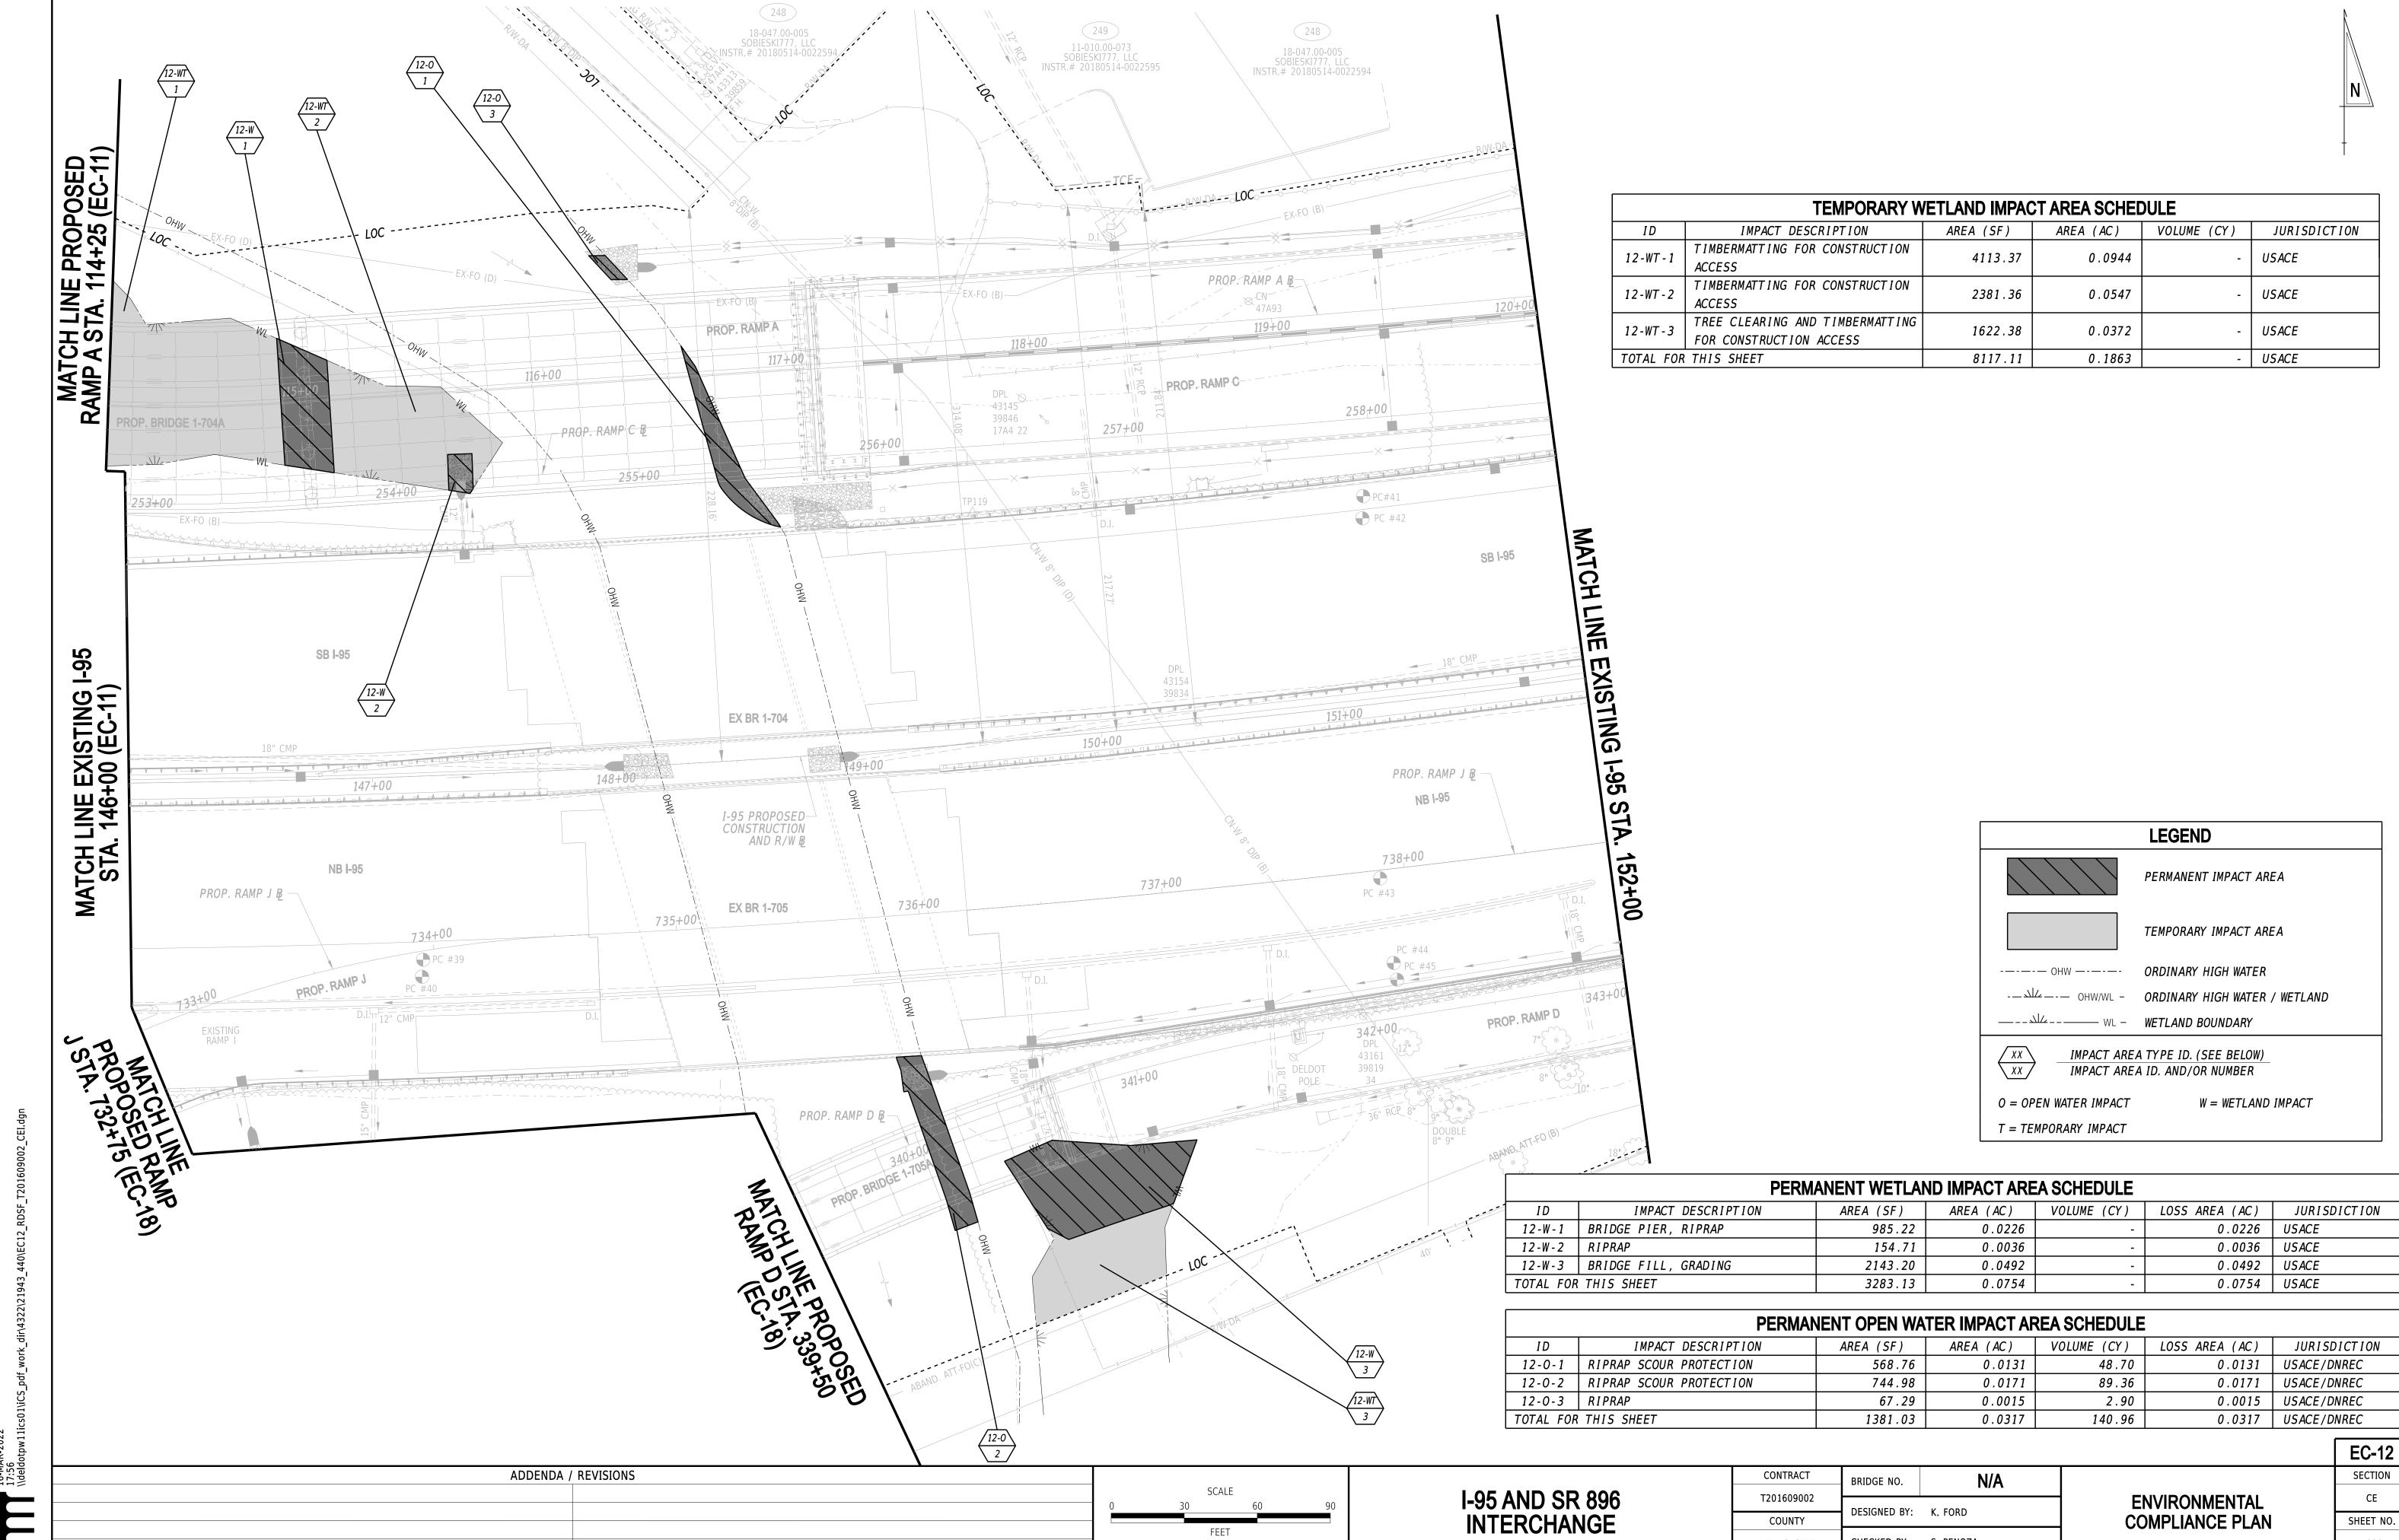



COUNTY


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CHECKED BY: S. PENOZA




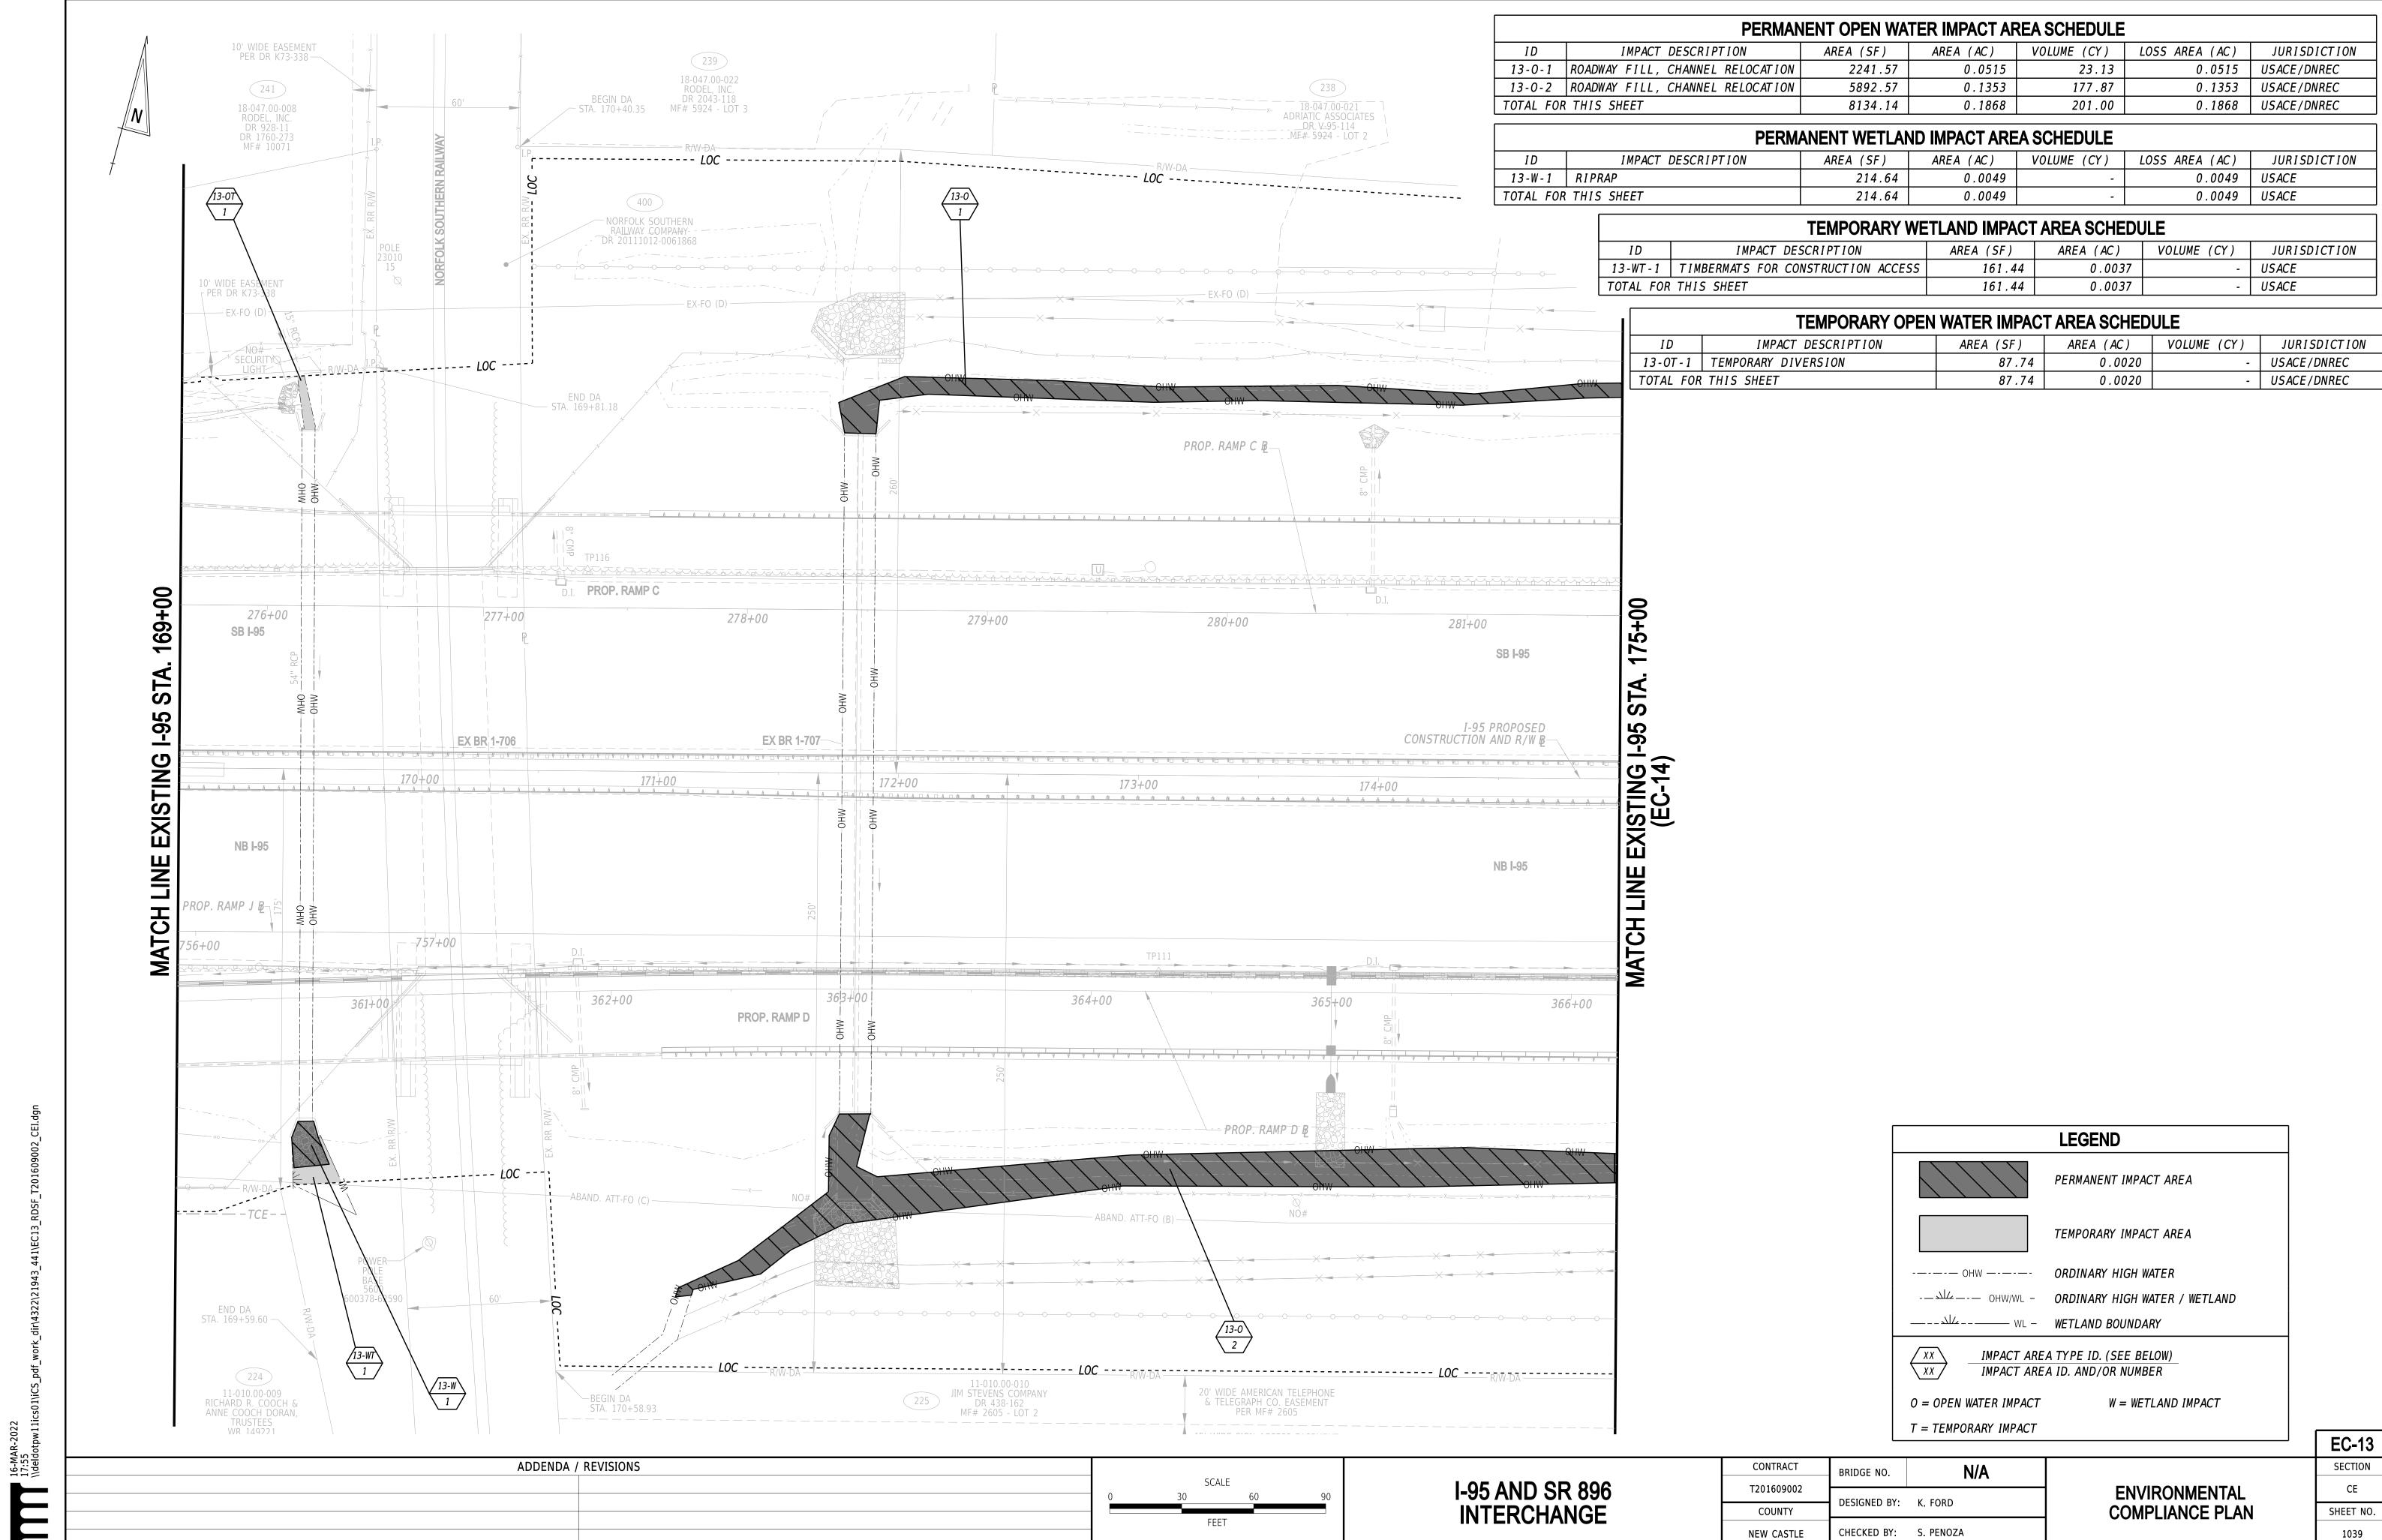

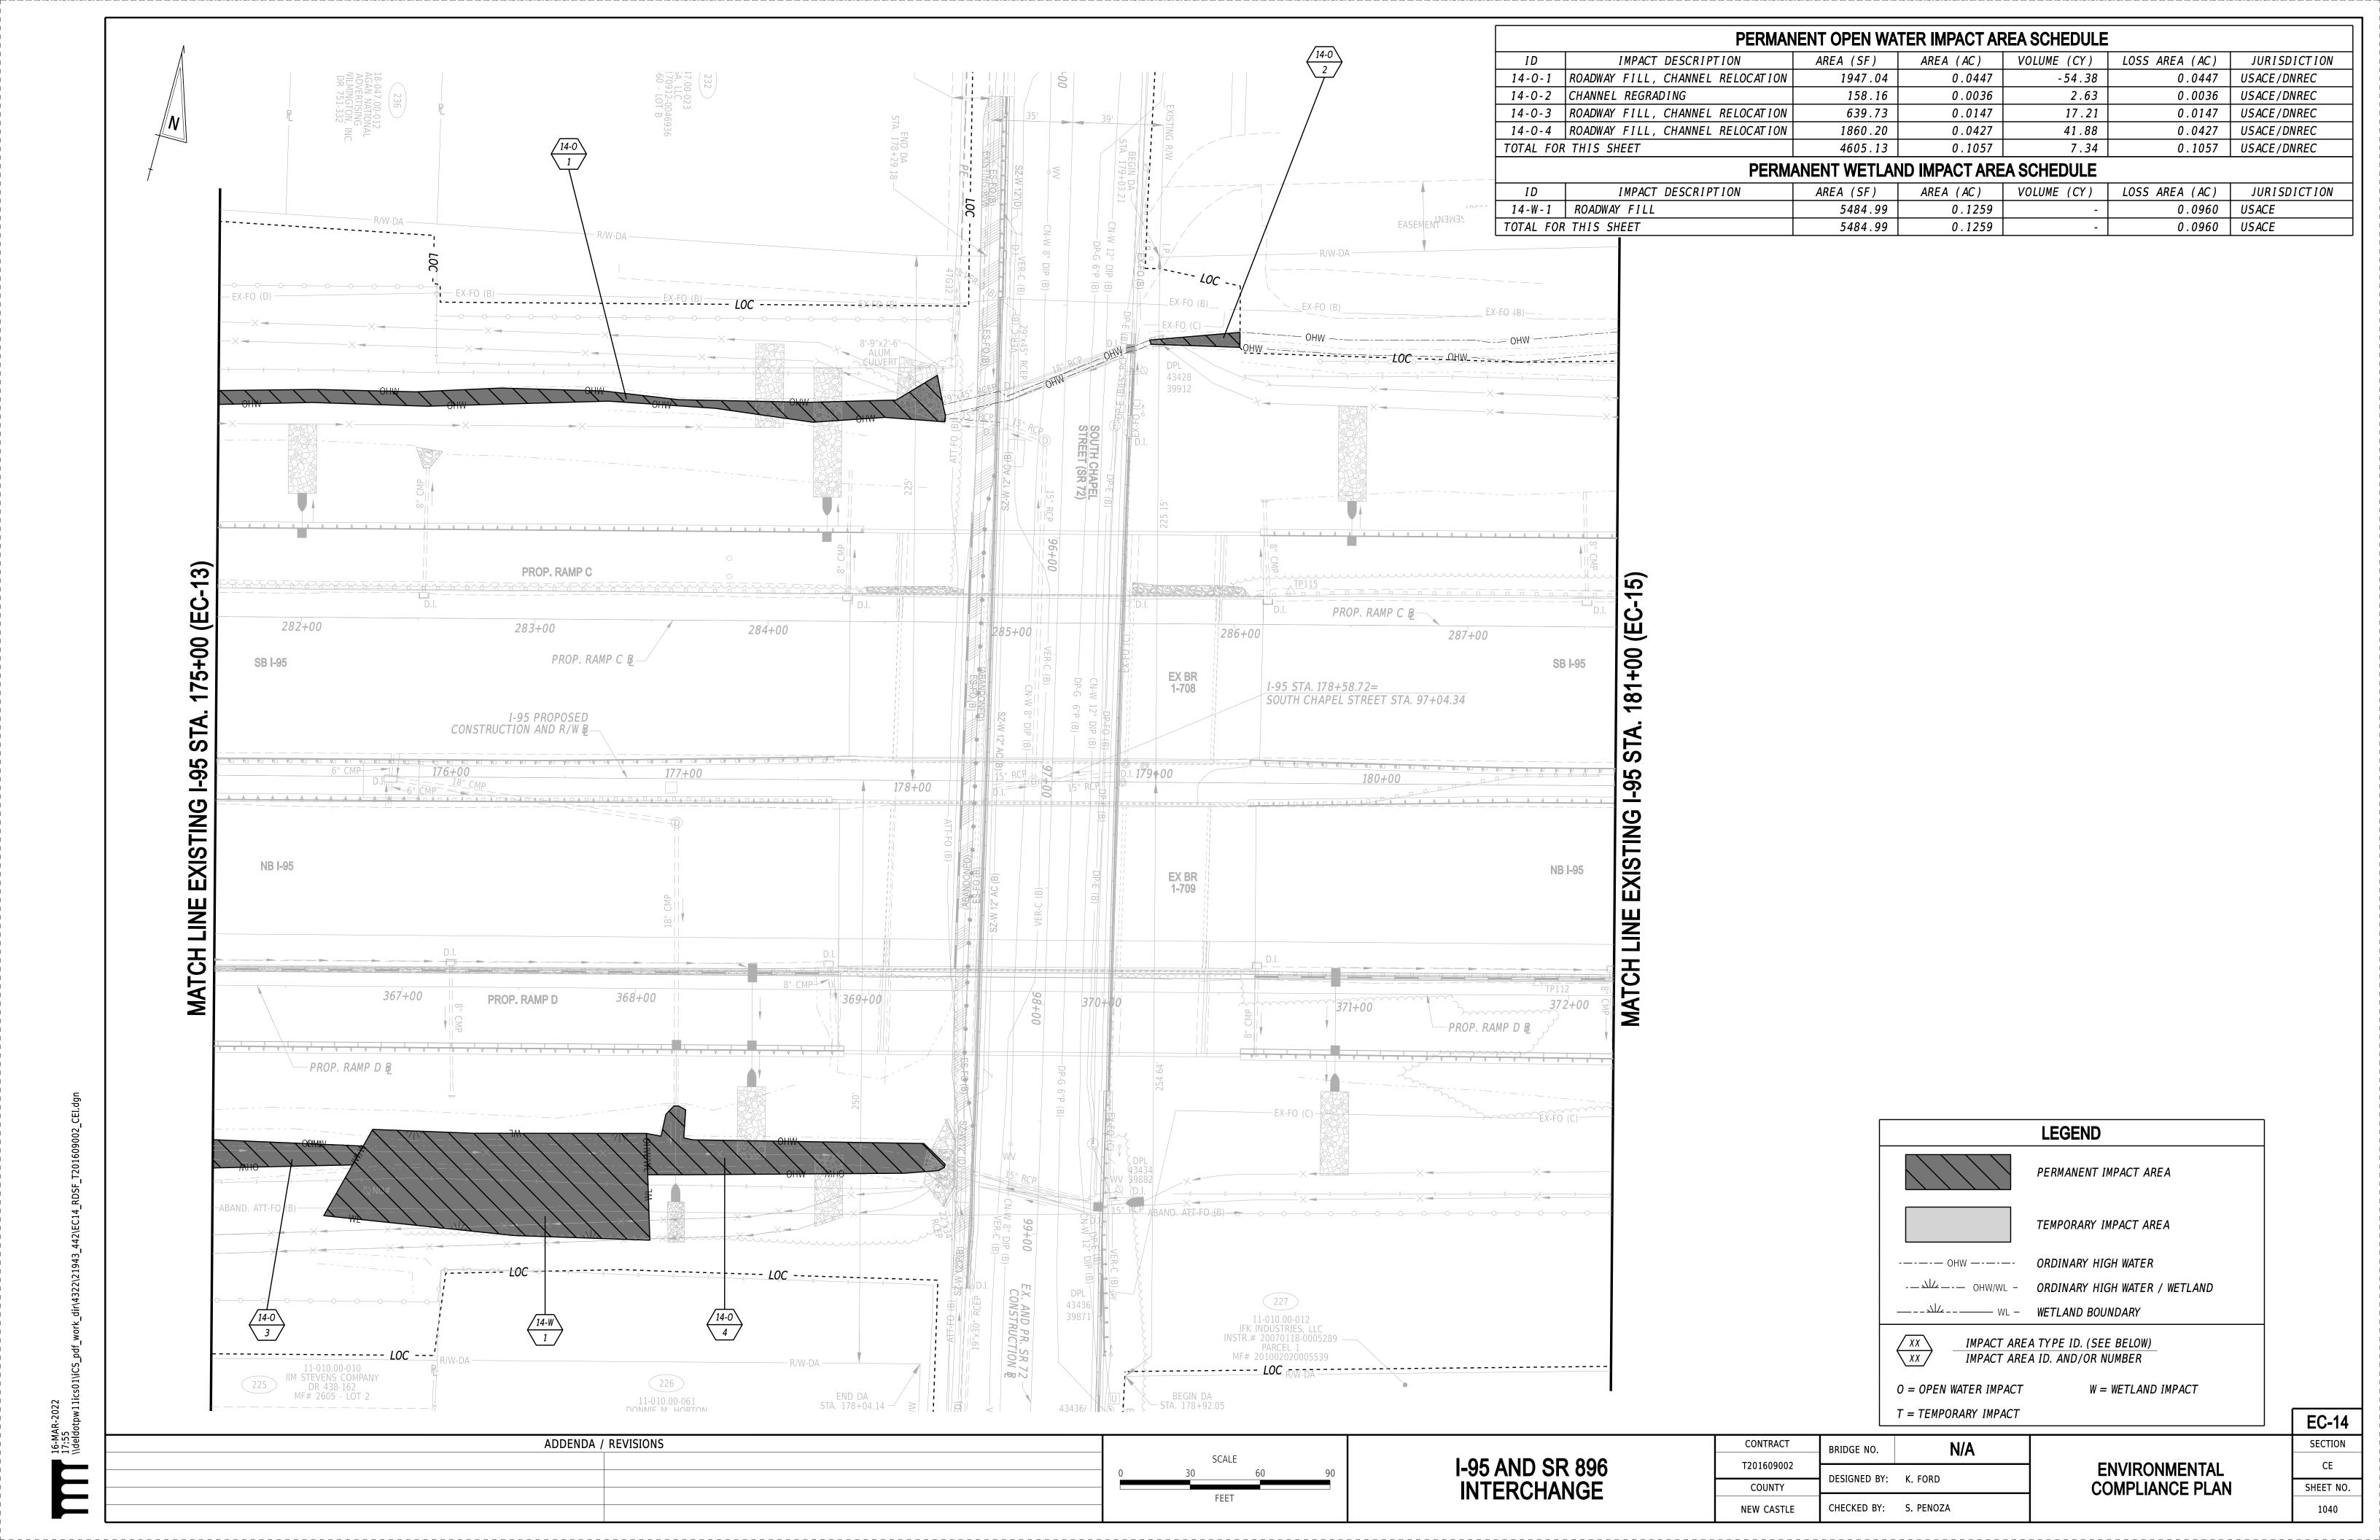


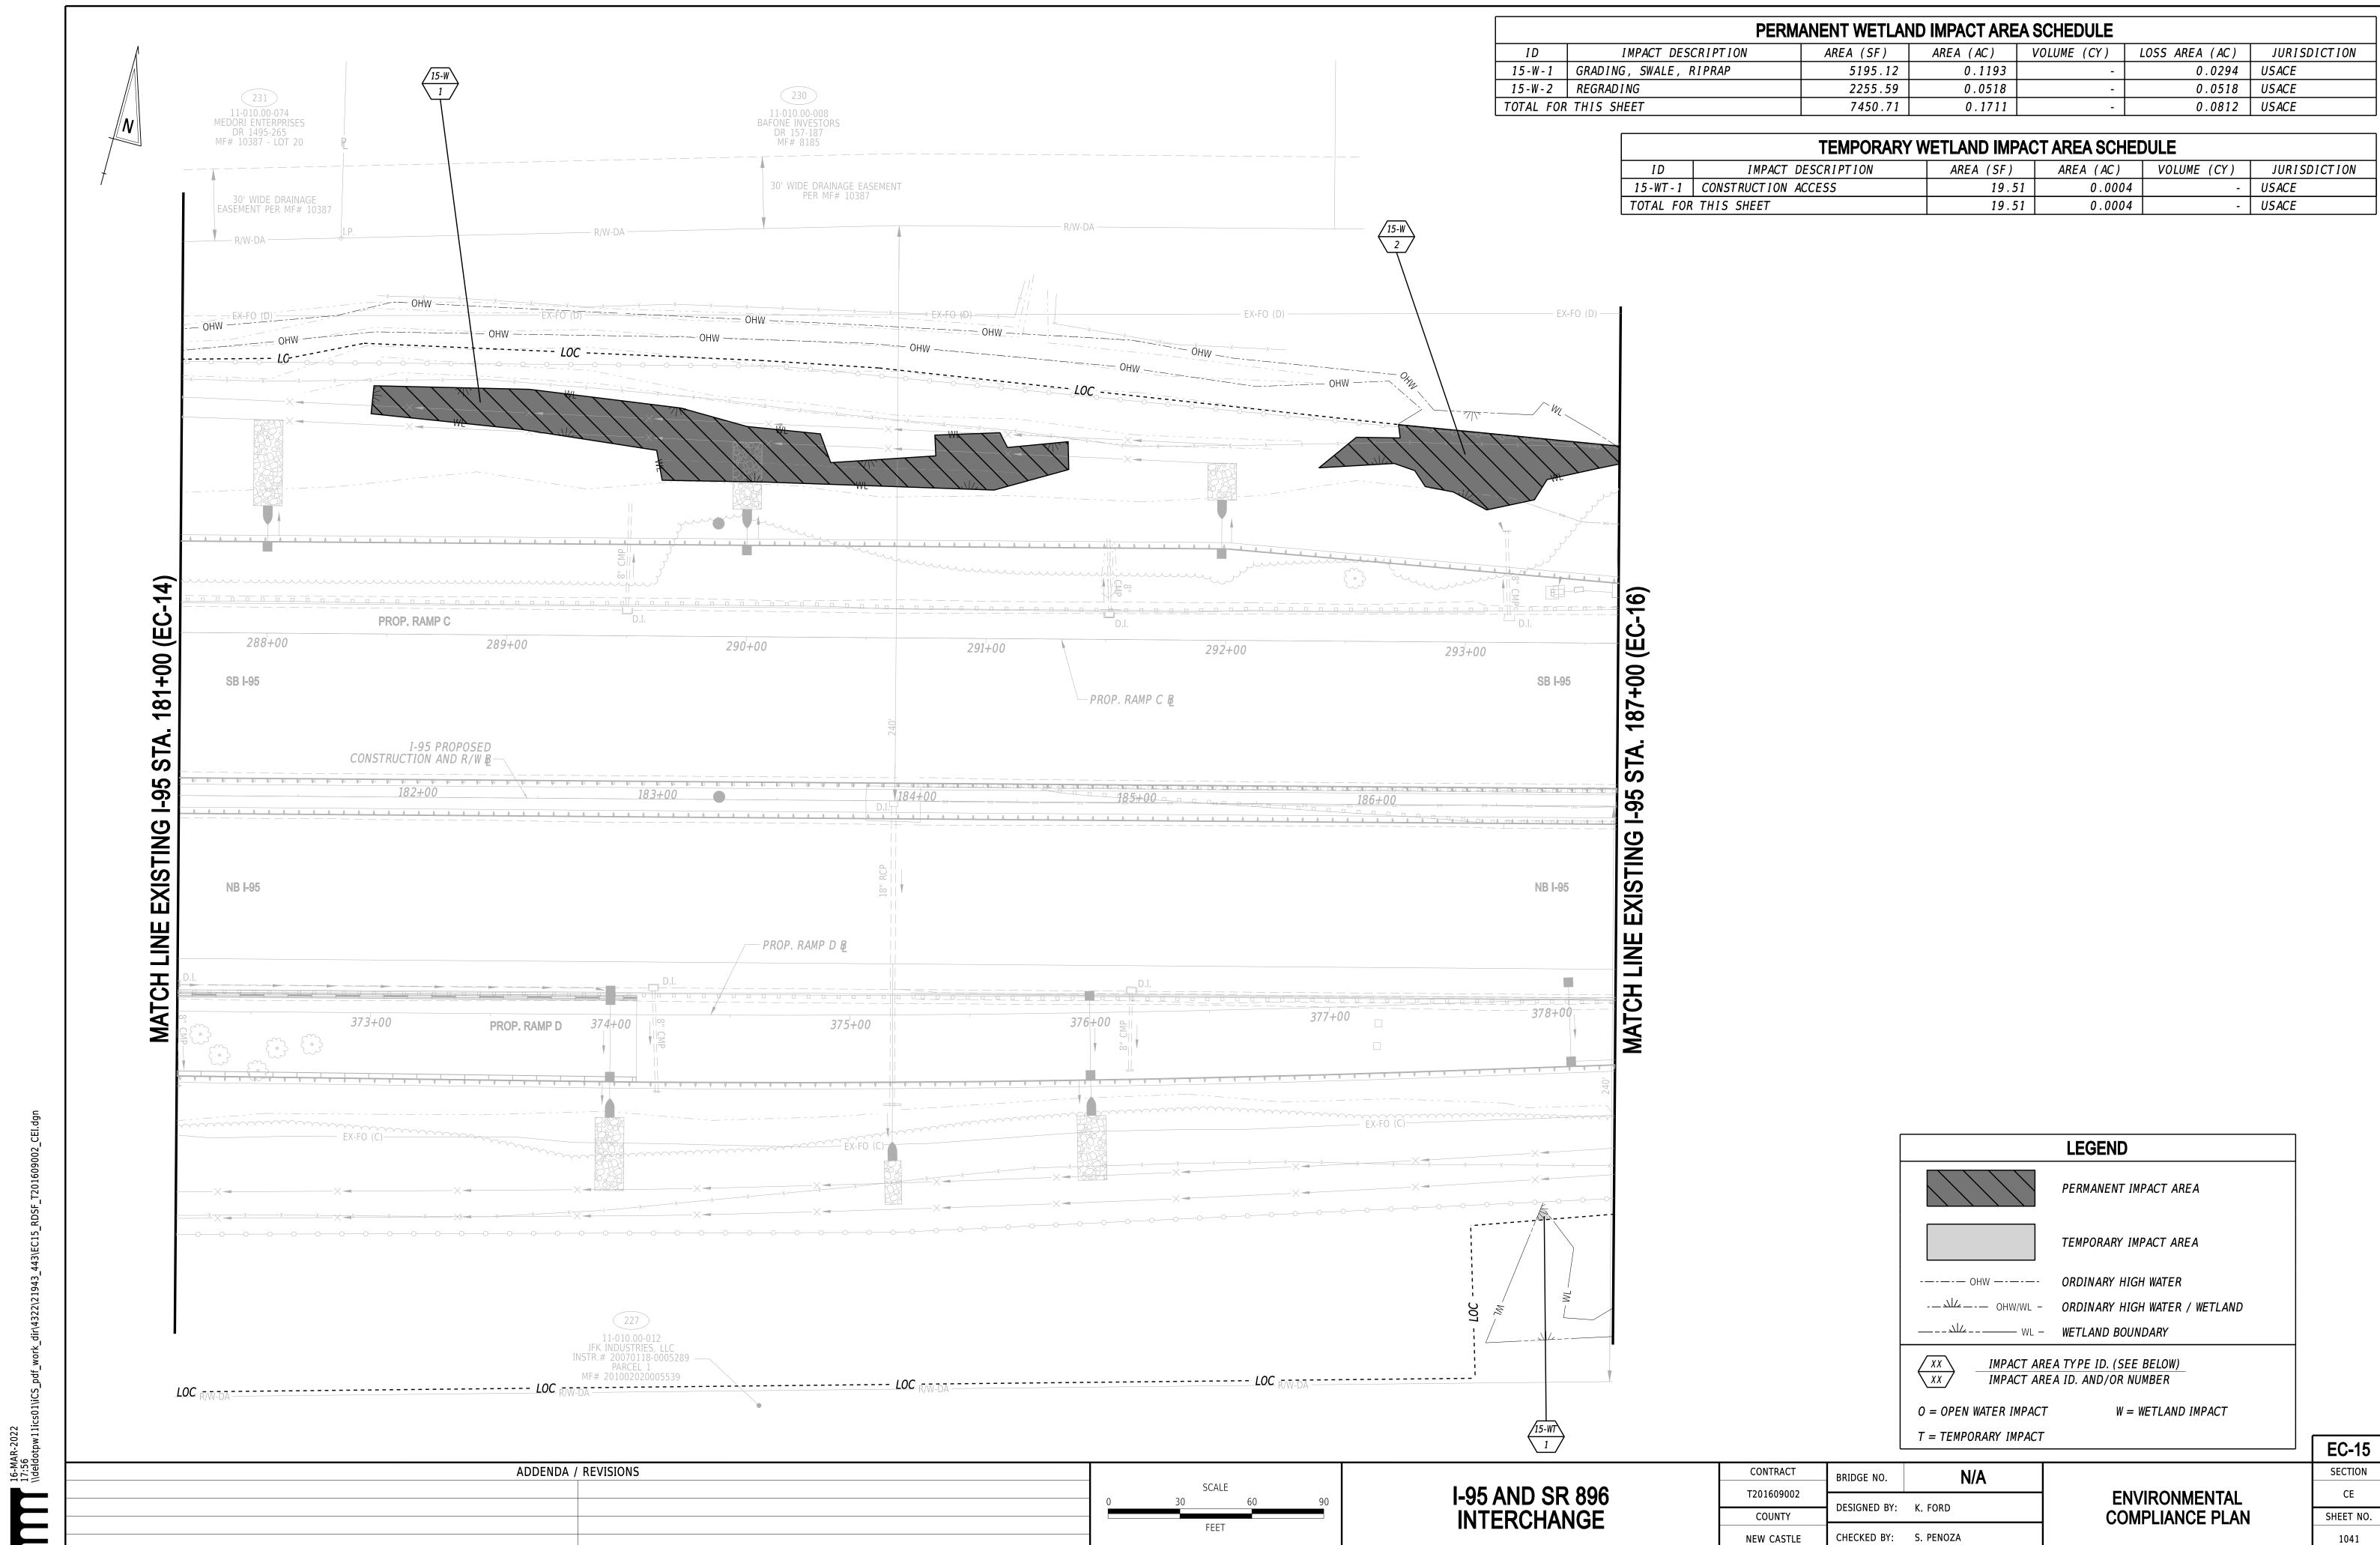

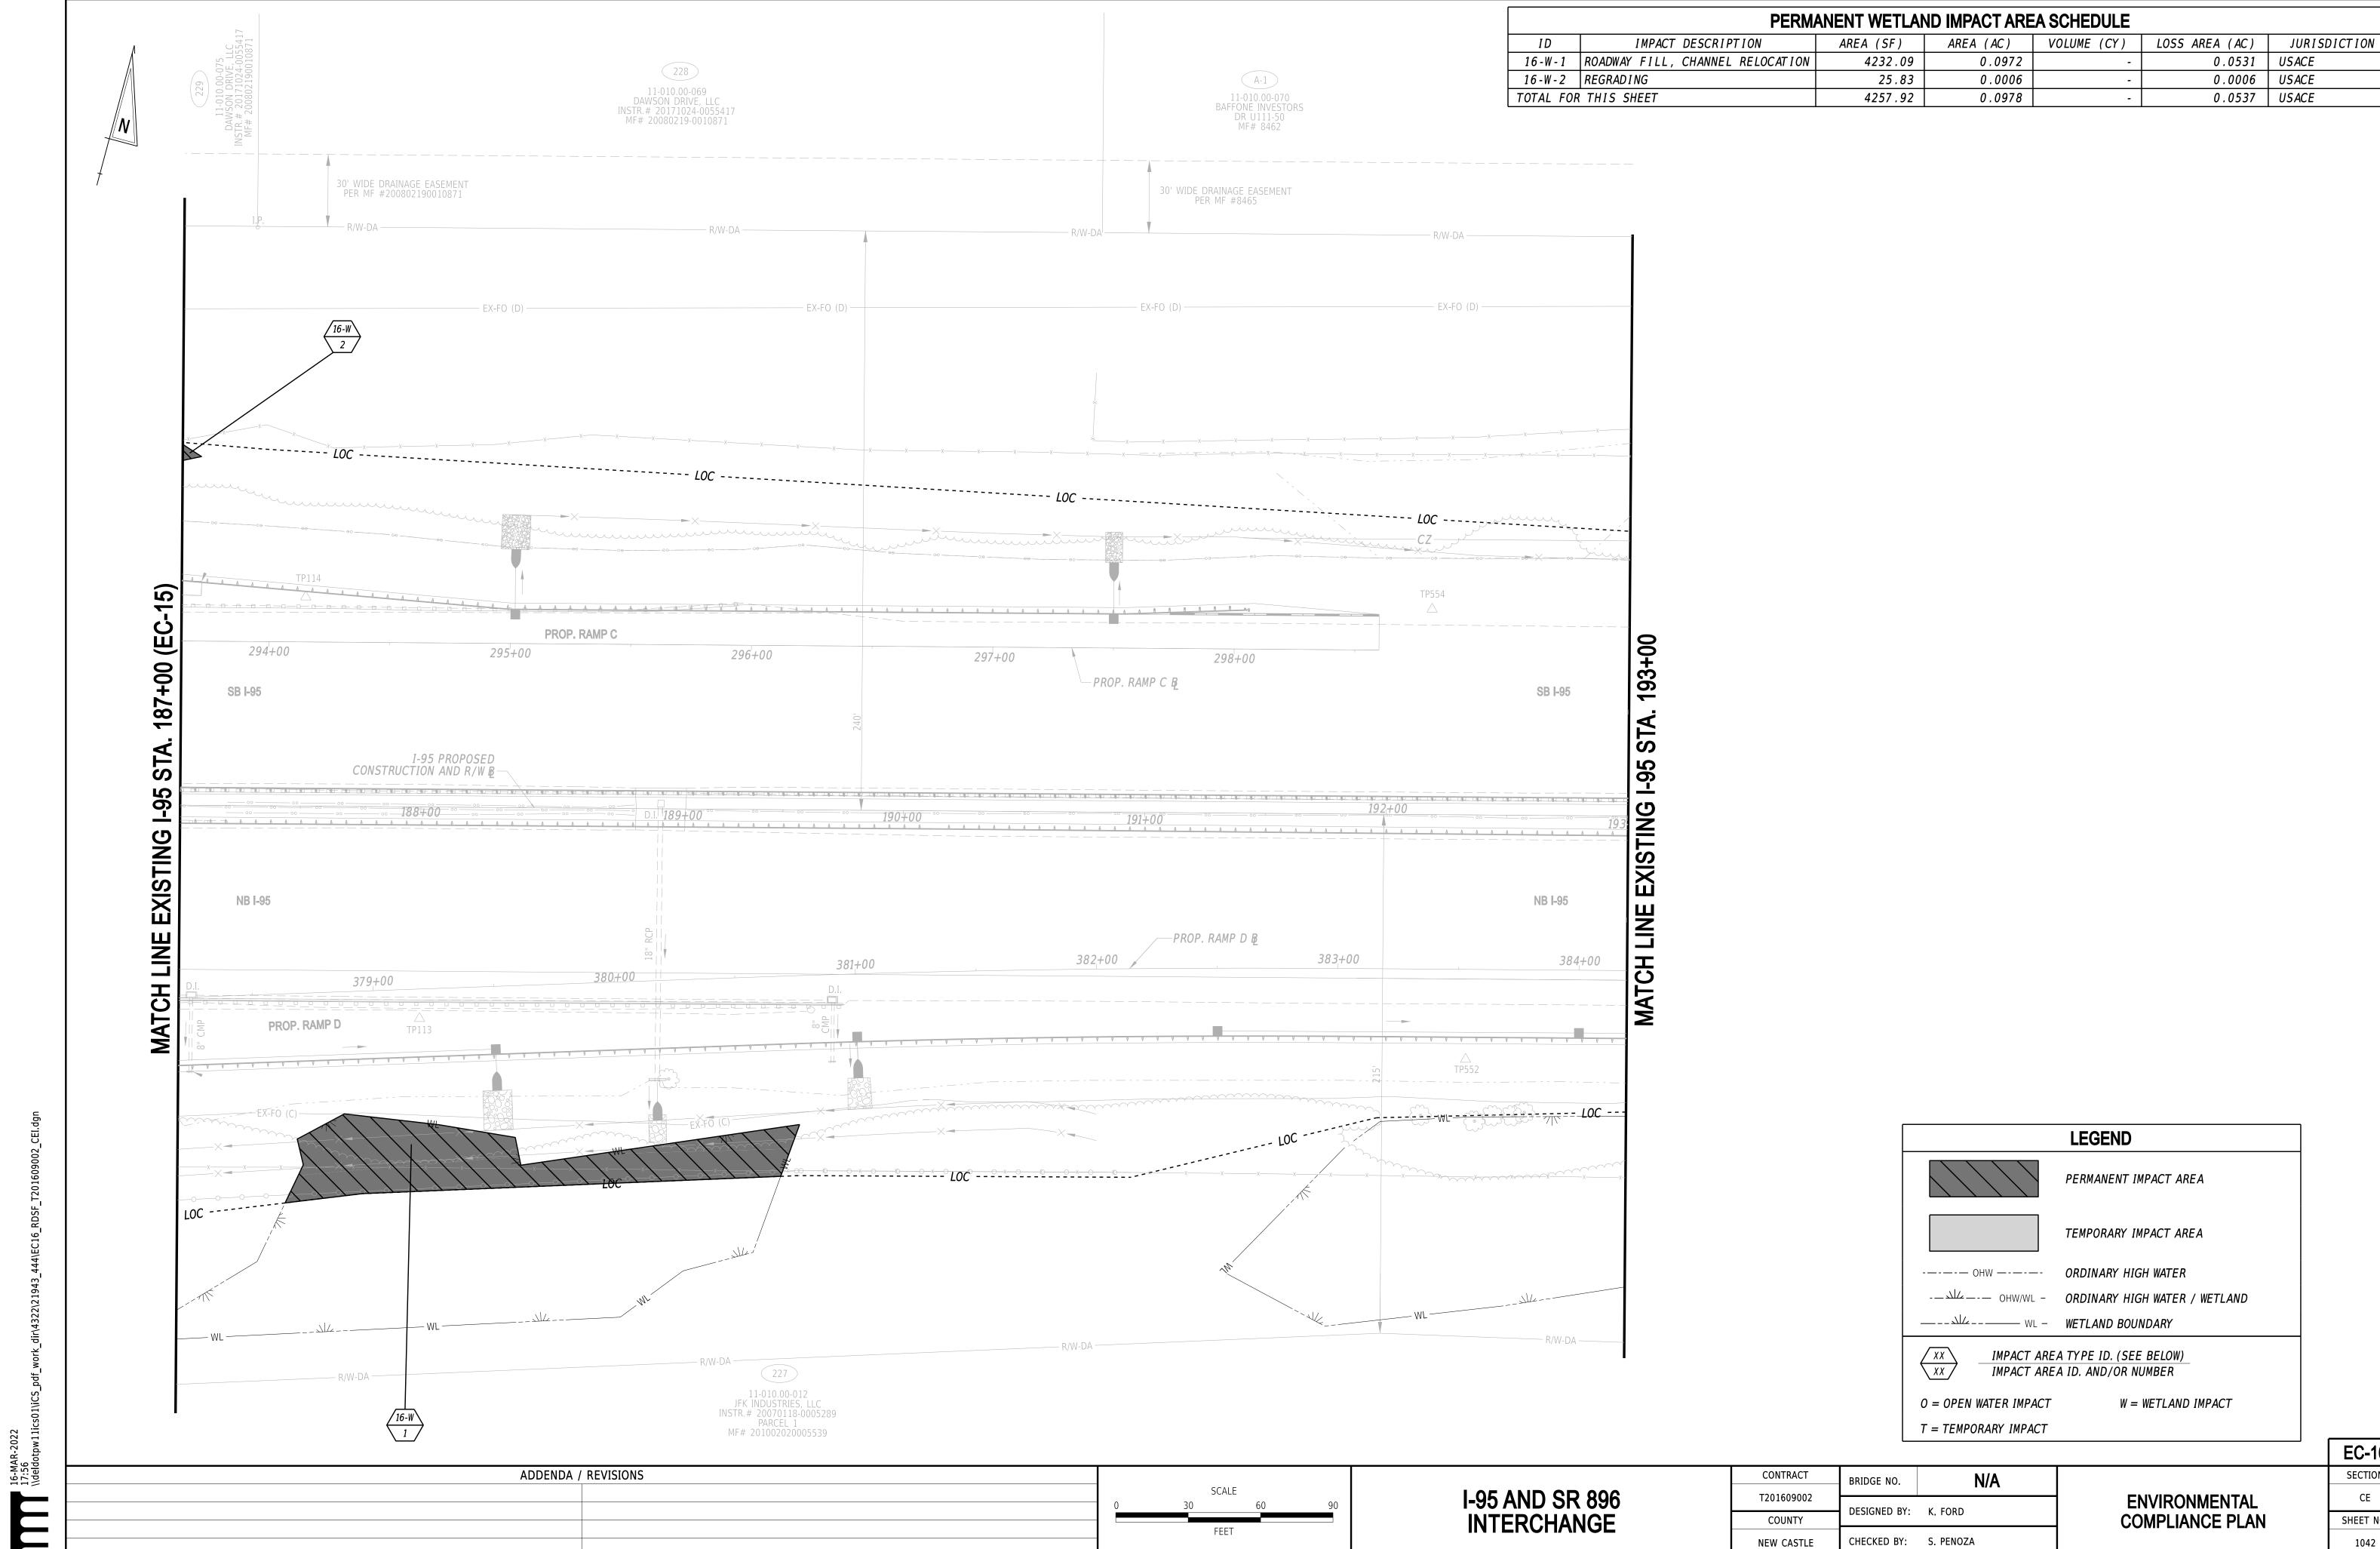
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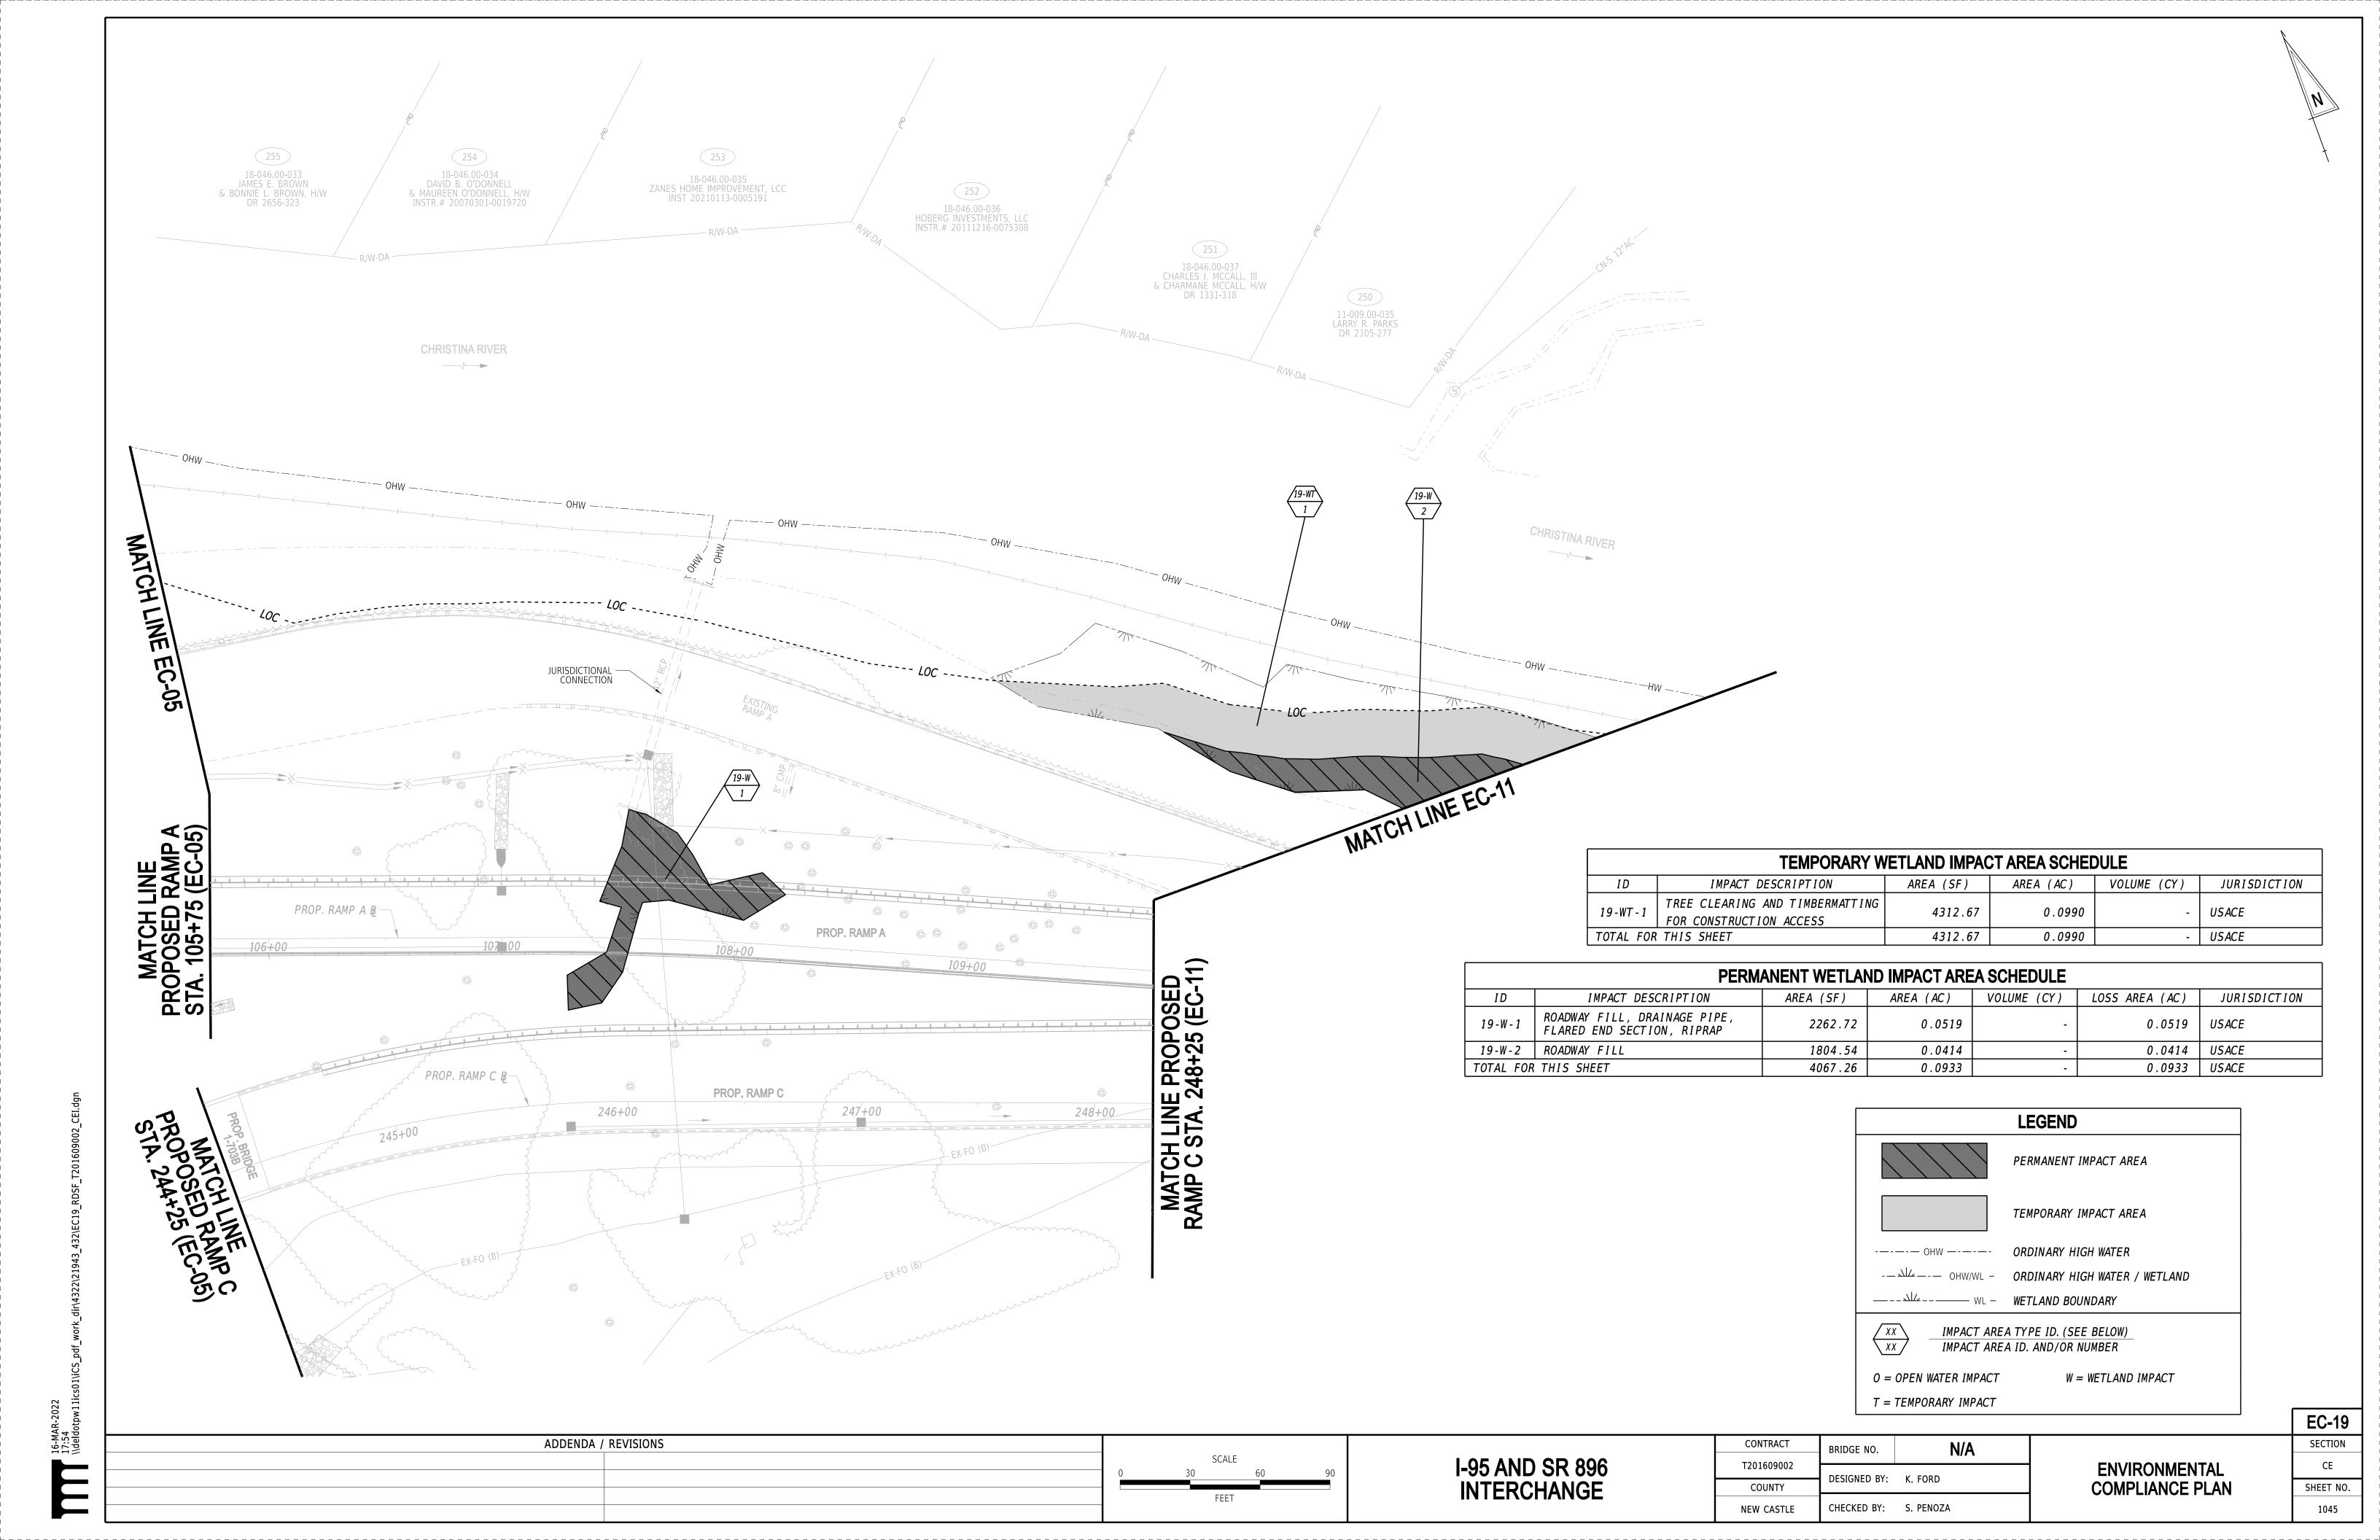


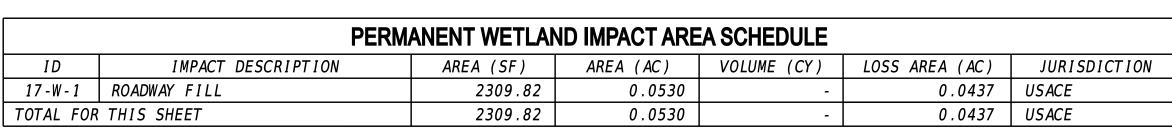
TEMPORARY WETLAND IMPACT AREA SCHEDULE							
I D	ID IMPACT DESCRIPTION AREA (SF) AREA (AC) VOLUME (CY) JURISDICTION						
17 -WT - 1	TREE CLEARING AND TIMBERMATTING FOR CONSTRUCTION ACCESS	4547.69	0.1044	_	USACE		
TOTAL FOR	THIS SHEET	4547.69	0.1044	1	USACE		

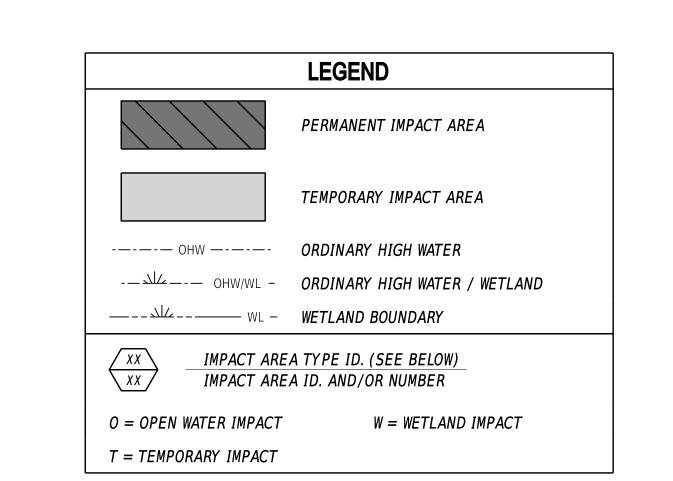

EC-17 ADDENDA / REVISIONS CONTRACT SECTION N/A BRIDGE NO. I-95 AND SR 896 INTERCHANGE ENVIRONMENTAL T201609002 CE DESIGNED BY: K. FORD **COMPLIANCE PLAN** SHEET NO. COUNTY CHECKED BY: S. PENOZA NEW CASTLE 1043



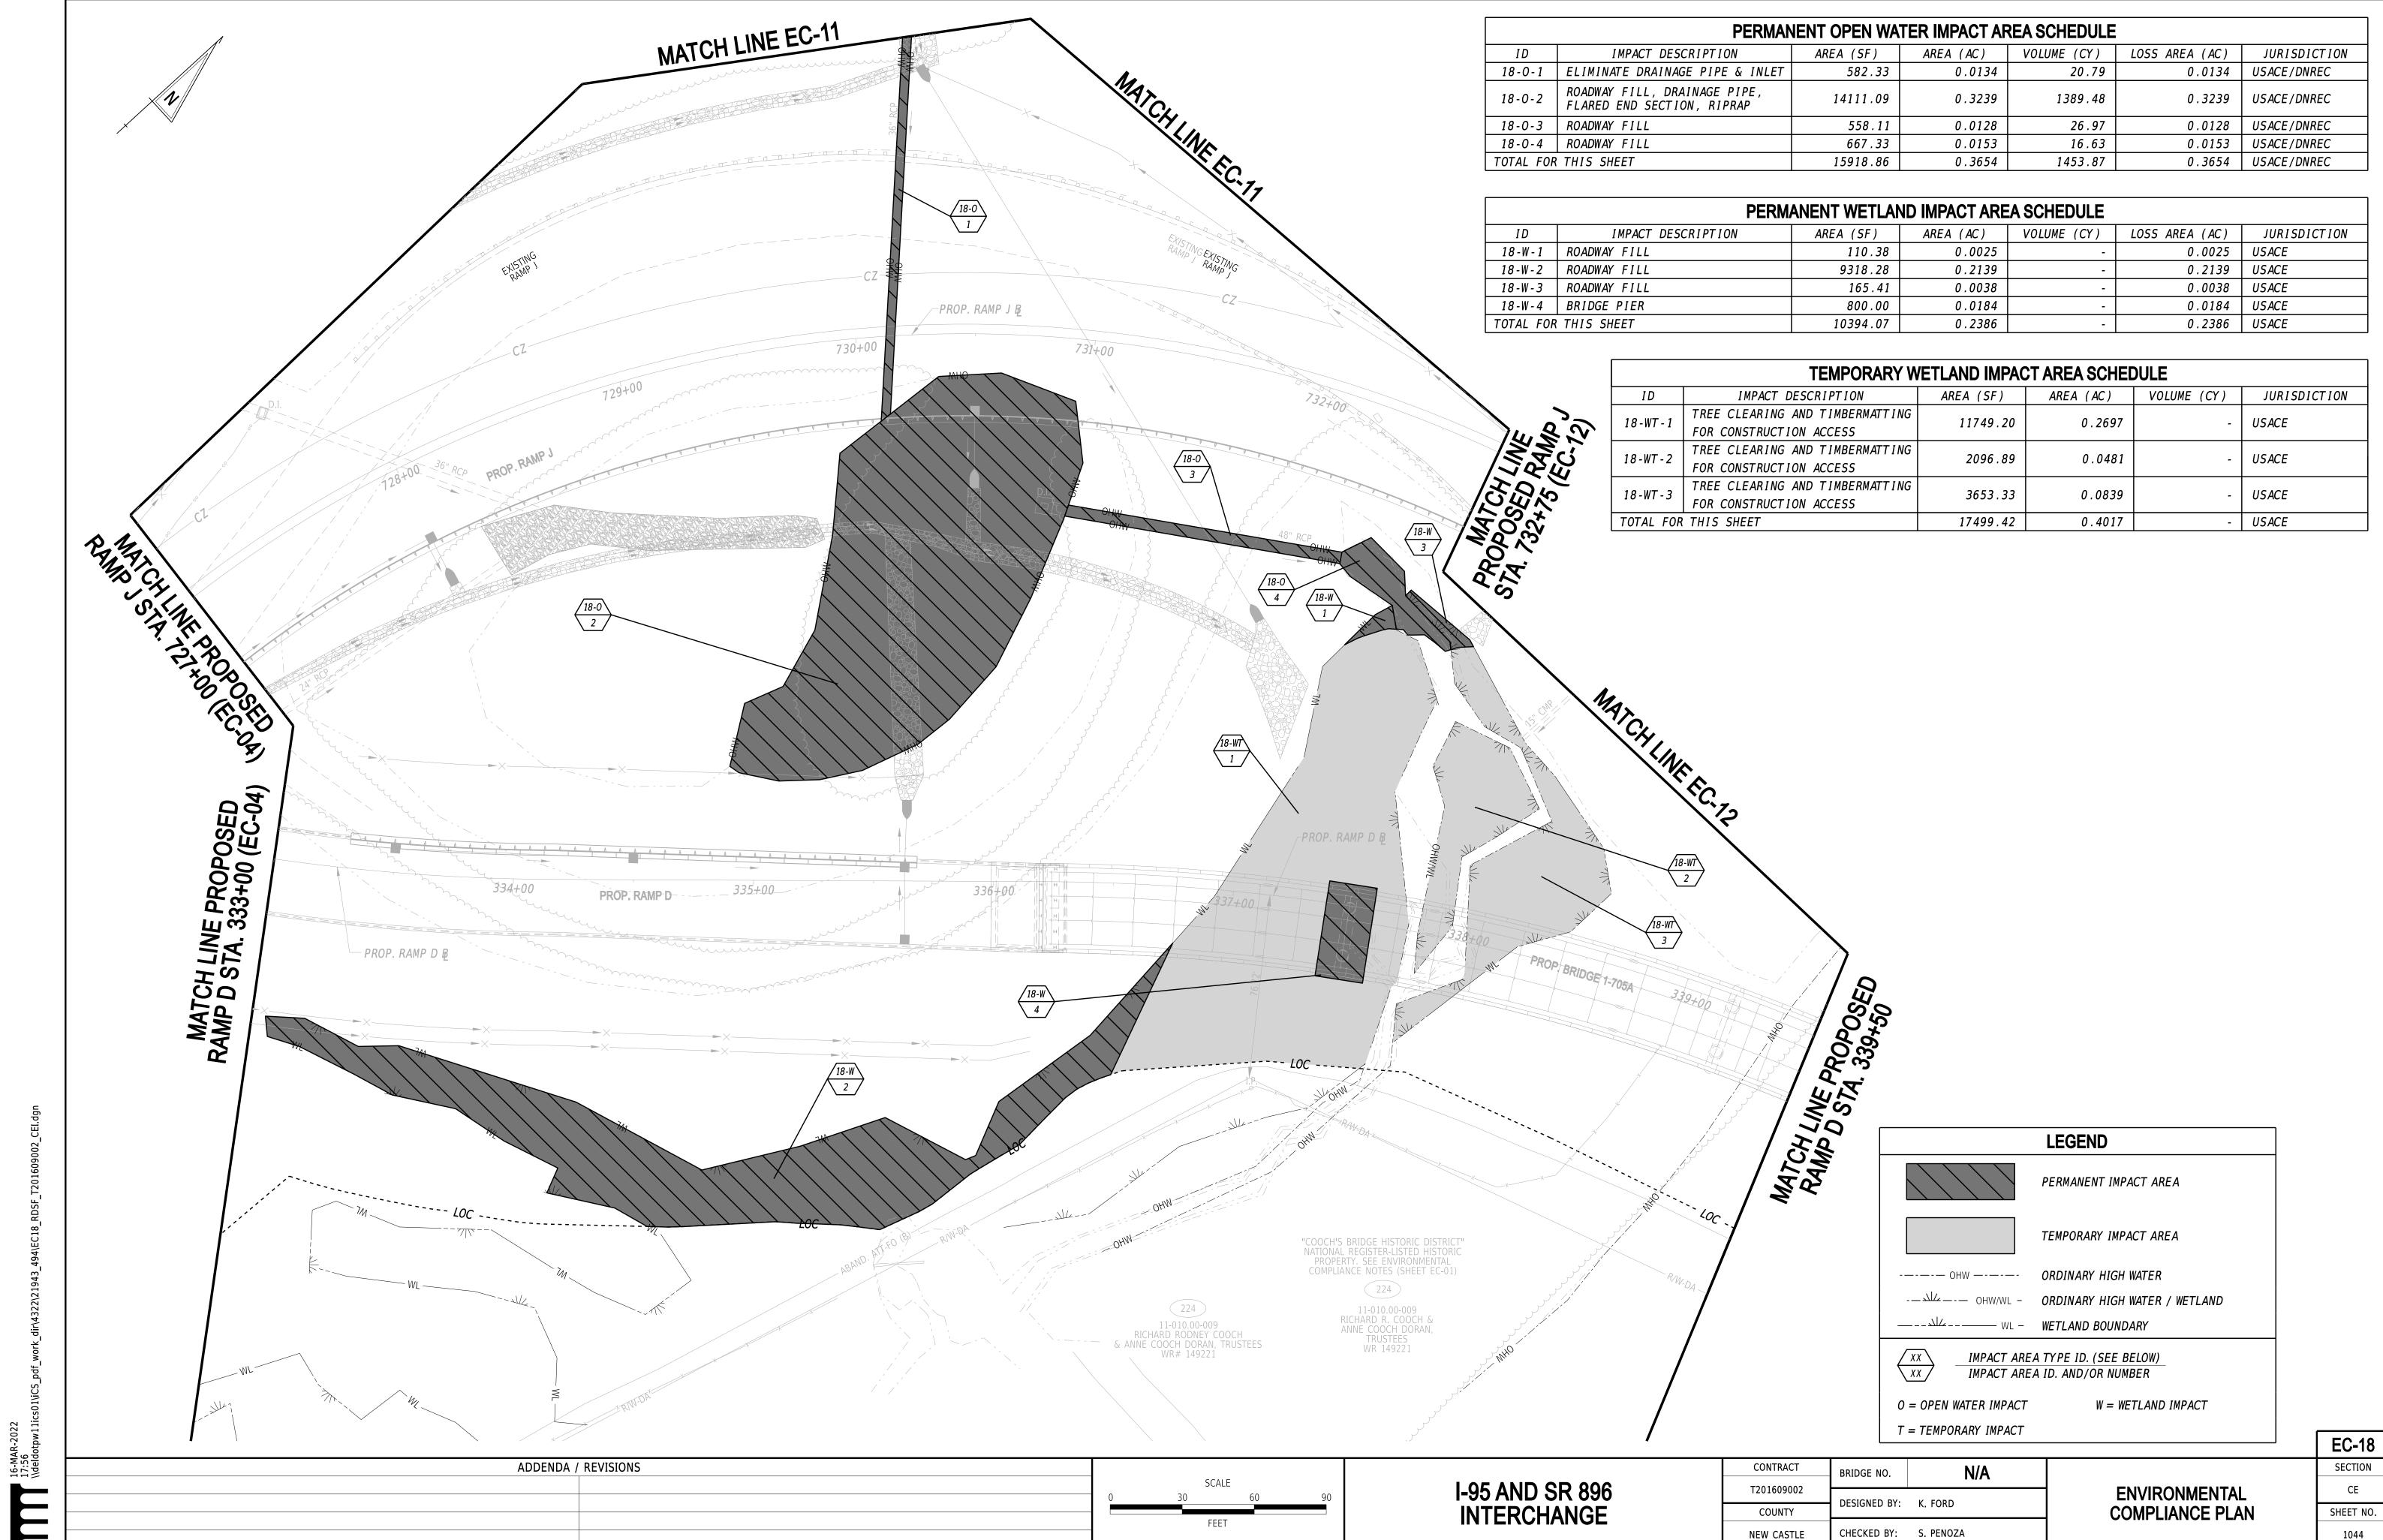

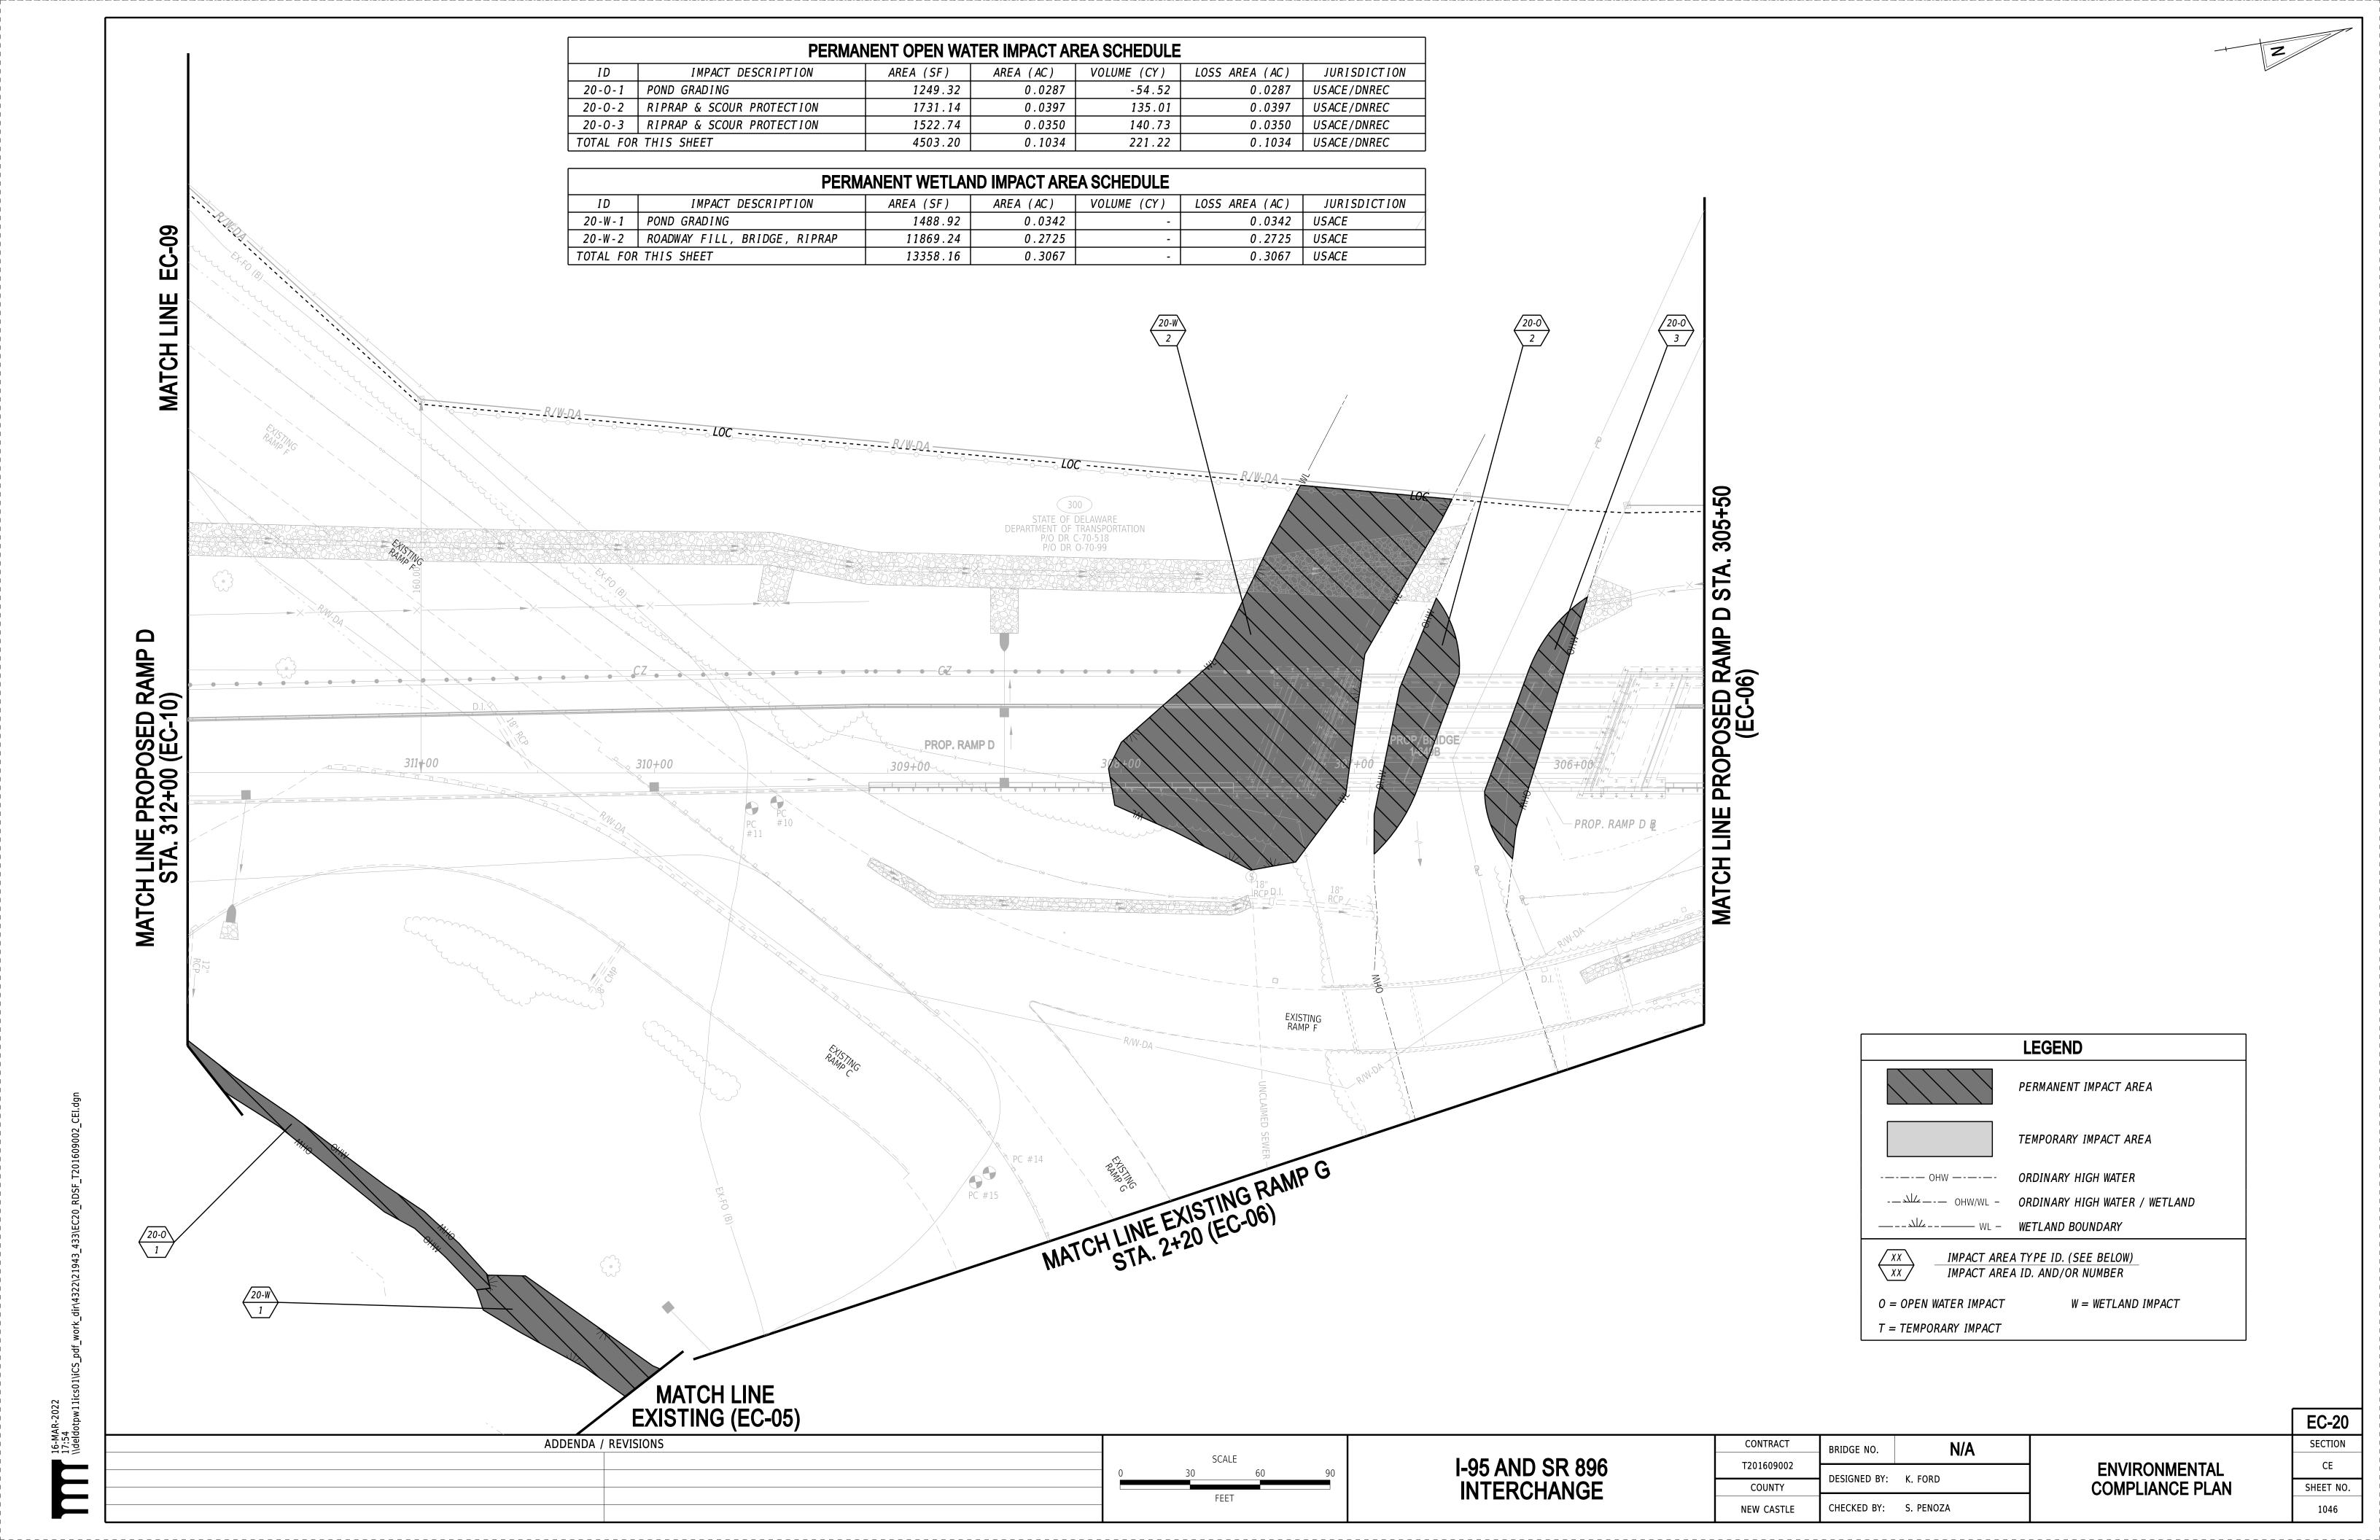

WETLAND MITIGATION SITE NOTES AND SEQUENCE OF CONSTRUCTION

ALL WORK AT THE WESTON WETLAND MITIGATION SITE SHALL BE COMPLETED IN ONE CONSTRUCTION SEASON AND SHALL BEGIN AS THE FIRST OPERATION. THE SITE SHALL BE COMPLETED PRIOR TO THE START OF PHASE 3. APPROVAL OF THE FINAL GRADING AS-BUILT DRAWINGS SHALL OCCUR SO ITEM NO. 908503 - WETLAND MITIGATION GRASS SEEDING SHALL BE PLACED BETWEEN SEPTEMBER 1ST AND NOVEMBER 15TH AS NOTED BELOW.

- 1. INSTALL ITEM NO. 905001 SILT FENCE AND ITEM NO. 905002 REINFORCED SILT FENCE AROUND THE PERIMETER OF THE SITE AS SHOWN ON THE EROSION AND SEDIMENT CONTROL PLANS.
- 2. INSTALL ITEM NO. 908023 STABILIZED CONSTRUCTION ENTRANCES AS SHOWN ON THE EROSION AND SEDIMENT CONTROL PLANS. THE DRIVEWAY SHALL REMAIN OPEN AT ALL TIMES DURING CONSTRUCTION.
- 3. INSTALL ORANGE SAFETY FENCE AND APPROPRIATE SIGNAGE AROUND ARCHAEOLOGICAL AREAS WITHIN THE LIMITS OF CONSTRUCTION. PAID FOR UNDER ITEM NO. 727006 TEMPORARY CONSTRUCTION FENCE.
- PERFORM THE CLEARING AND GRUBBING OF THE SITE SO THE WORK ONLY DISTURBS AREAS THAT WILL BE EXCAVATED OR GRADED WITHIN THE NEXT FOURTEEN CALENDAR DAYS.
- EXCAVATE THE EXISTING TOPSOIL TO A DEPTH OF 9". PLACE THE EXCAVATED TOPSOIL IN A STOCKPILE IN THE UPLAND AREA NOTED ON THE EROSION AND SEDIMENT CONTROL PLANS. THIS STOCKPILE LOCATION IS IDENTIFIED ON PLANS AS PROPOSED WETLAND MITIGATION TEMPORARY TOPSOIL STOCKPILE. INSTALL ITEM NO. 905002 REINFORCED SILT FENCE AROUND THE TOPSOIL STOCKPILE PRIOR TO PLACING ANY MATERIALS IN THE STOCKPILE. STABILIZE THE TEMPORARY TOPSOIL STOCKPILE WITH ITEM NO. 908017 TEMPORARY SEED MIX, DRY GROUND. THIS TOPSOIL WILL BE PLACED ON THE BOTTOM AND SIDES OF THE CREATED WETLAND MITIGATION SITE AND SHALL NOT BE USED ANYWHERE ELSE ON THE PROJECT SITE (ITEM NO. 908006 TOPSOILING ON THE BOTTOM AND NO. 908010 TOPSOILING, 6" DEPTH ON THE SIDES). NO TOPSOIL SHALL BE REMOVED FROM THE SITE UNTIL ACCEPTANCE OF THE FINAL GRADING.
- 6. EXCAVATE THE WETLAND MITIGATION SITE TO THE DESIGN SUB-GRADE ELEVATIONS AND STOCKPILE THE EXCAVATED MATERIALS AT THE DESIGNATED STOCKPILE LOCATION NOTED ON THE PLANS OR INCORPORATE DIRECTLY INTO THE PROJECT. THE STOCKPILE LOCATIONS ARE IDENTIFIED ON THE PLANS. PAYMENT FOR ALL EXCAVATED MATERIAL TO BE MADE UNDER ITEM NO. 202000 EXCAVATION AND EMBANKMENT.
- THE CONTRACTOR SHALL PREPARE AND SUBMIT AS-BUILT TOPOGRAPHIC PLANS FOR THE SUB-GRADE. THE MAXIMUM HORIZONTAL DISTANCE BETWEEN SPOT ELEVATIONS SHALL BE 20' AND ADDITIONAL SPOT ELEVATIONS SHALL BE OBTAINED AS NECESSARY TO IDENTIFY ALL BREAKS IN GRADE AND OTHER FEATURES. SPOT ELEVATIONS SHALL EXTEND A MINIMUM OF 50' BEYOND THE DISTURBED AREA. SPOT ELEVATIONS SHALL BE OBTAINED AND SHOWN ON THE AS-BUILT PLAN TO ONE-HUNDRETH OF A FOOT. THE TOLERANCE FOR THE PROPOSED WETLAND MITIGATION SITE BOTTOM SHALL BE PLUS OR MINUS ONE TENTH (0.1) OF A FOOT. THE DRAWINGS SHALL BE SUBMITTED TO DELDOT IN BOTH DIGITAL AND PAPER FORMAT CONFORMING TO CURRENT DELDOT CADD STANDARDS. DIGITAL INFORMATION SHALL BE SUBMITTED IN .DGN FORMAT AND .DTM FORMAT AND SHALL INCLUDE ALL SURVEY DATA IN .TXT FORMAT. THE DRAWINGS SHALL BE AT 60 SCALE. CONTOURS SHALL BE SHOWN AT 0.5' INTERVALS AND THE CONTOUR LINES SHALL BE LABELED FREQUENTLY ENOUGH THAT IT IS POSSIBLE TO CLEARLY ASCERTAIN THE ELEVATION OF ANY PARTICULAR CONTOUR LINE ANYWHERE ON THE PLAN SHEET. SPOT ELEVATIONS ON THE AS-BUILTS SHALL BE LABELED AND SHALL BE SUCH THAT THE PLAN SHEET TEXT SHALL BE LEGIBLE, SOLID BLACK CHARACTERS, IN A SIZE APPROPRIATE TO THE SCALE OF THE DRAWINGS AND SEPARATED, NOT SUPERIMPOSED, ON TOP OF ONE ANOTHER. A PROFESSIONAL ENGINEER OR LAND SURVEYOR REGISTERED IN THE STATE OF DELAWARE SHALL SIGN AND SEAL THE AS-BUILTS. THE CONTRACTOR SHALL SUBMIT THE AS-BUILTS WITHIN SEVEN CALENDAR DAYS OF REACHING FINAL SUBGRADE ELEVATIONS. ALL COSTS FOR PREPARING THE SUBGRADE AS-BUILT PLANS SHALL BE PAID FOR UNDER ITEM NO. 763501 CONSTRUCTION ENGINEERING. DISKING MAY NOT BEGIN UNTIL THE CONTRACTOR HAS RECEIVED THE ENGINEER'S APPROVAL OF THE SUBGRADE AS-BUILT PLAN.
- AFTER ACCEPTANCE OF THE SUB-GRADE AS-BUILTS, THE SUBGRADE SHALL BE DISKED TO A MIN. DEPTH OF 4", THREE TIMES. THE SECOND PASS WITH THE DISK SHALL BE PERPENDICULAR TO THE FIRST. SIMILARLY, THE THIRD PASS SHALL BE PERPENDICULAR TO THE SECOND PASS. ALL COSTS SHALL BE INCIDENTAL TO ITEM 202000 EXCAVATION AND EMBANKMENT. AFTER THE SUB-GRADE IS DISKED, THE CONTRACTOR SHALL PLACE TOPSOIL FROM THE ON-SITE PROPOSED WETLAND MITIGATION TEMPORARY TOPSOIL STOCKPILES, ON THE SIDES AND BOTTOM OF THE WETLAND MITIGATION SITE. TOPSOIL SHALL BE PLACED TO THE LINES, GRADES AND ELEVATIONS SHOWN IN THE PLANS WITH EQUIPMENT UTILIZING WIDE LOW-PRESSURE TIRES OR TRACKS. NINE (9") INCHES OF TOPSOIL SHALL BE PLACED, IN TWO EQUAL 4.5" LIFTS ON THE BOTTOM OF THE WETLAND SITE. SIX (6") INCHES OF TOPSOIL SHALL BE PLACED ON THE SIDES OF THE WETLAND SITE IN ONE LIFT. ALL COSTS ASSOCIATED WITH PLACING EACH LIFT OF THE TOPSOIL SHALL BE PAID FOR UNDER ITEM NO. 908006 TOPSOILING ON THE BOTTOM OF THE WETLAND MITIGATION SITE AND NO. 908010 TOPSOILING, 6" DEPTH ON THE SIDES.
- 9. ONCE THE TOPSOIL IS PLACED TO THE FINAL LINES, GRADES AND ELEVATIONS SHOWN ON THE PLANS, THE CONTRACTOR SHALL PREPARE AND SUBMIT AS-BUILT TOPOGRAPHIC PLANS SHOWING IN-PLACE TOPSOIL GRADESAND ELEVATIONS. THESE PLANS SHALL MEET ALL REQUIREMENTS OF THE AS-BUILTS AS STATED ABOVE AND SHALL BE SUBMITTED WITHIN SEVEN CALENDAR DAYS OF REACHING FINAL GRADES.
- 10. DELDOT SHALL REVIEW THE SUBMITTED AS-BUILT DRAWINGS TO ENSURE THE PROJECT IS GRADED IN ACCORDANCE WITH THE LINE AND GRADES OF THE PLANS AND SHALL RESPOND TO THE CONTRACTOR WITHIN FOURTEEN CALENDAR DAYS. IF THE SITE IS NOT PROPERLY GRADED, DELDOT SHALL MARK THE ERRORS ON THE DRAWINGS AND RETURN THEM TO THE CONTRACTOR. THE CONTRACTOR SHALL GRADE ANY DEFECTIVE AREAS WITHIN SEVEN CALENDAR DAYS OF RECEIVING THE MARKED PLANS FROM DELDOT AND THEN SHALL PREPARE AND SUBMIT TO DELDOT A NEW SET OF PAPER AND ELECTRONIC AS-BUILT PLANS FOR THE ENTIRE SITE SHOWING THE CORRECTIVE WORK AREAS WITHIN SEVEN CALENDAR DAYS OF COMPLETING THE CORRECTIVE WORK. DELDOT SHALL REVIEW AND, IF NECESSARY, RETURN THE PLANS TO THE CONTRACTOR WITH ANY ERRORS AGAIN MARKED ON THE PLANS WITHIN SEVEN CALENDAR DAYS. THIS PROCESS SHALL CONTINUE UNTIL THE PROJECT AND AS-BUILT DRAWINGS CONFORM TO THE PLANS AND ALL OTHER REQUIREMENTS OF THE CONTRACT DOCUMENTS. ALL COSTS FOR PREPARING THE FINAL AS-BUILT PLANS SHALL BE PAID FOR UNDER ITEM 763501 CONSTRUCTION ENGINEERING.
- 11. AFTER ACCEPTANCE OF THE WETLAND FINAL TOPSOIL GRADING BY DELDOT, THE CONTRACTOR SHALL PLACE THE SEED AND MULCH AS SHOWN ON THE WETLAND MITIGATION SITE CROSS SECTIONS AND IN ACCORDANCE WITH THE FOLLOWING:
 - A. THE CONTRACTOR SHALL SPREAD THE SEED MIX OVER THE WETLAND MITIGATION AREA AT THE RATES SPECIFIED IN ITEM NO. 908503 WETLAND MITIGATION GRASS SEEDING AND ON THE PLANS. THIS SEED MIX SHALL ONLY BE APPLIED BETWEEN SEPTEMBER 1ST AND NOVEMBER 15TH.
 - B. THEN THE CONTRACTOR SHALL DISK THE AREA, TO A DEPTH OF 4 INCHES, THREE (3) TIMES. THE SECOND PASS WITH THE DISK SHALL BE PERPENDICULAR TO THE FIRST PASS AND SIMILARLY, THE THIRD PASS SHALL BE PERPENDICULAR TO THE SECOND PASS. ALL COSTS FOR DISKING SHALL BE INCIDENTAL TO ITEM NO. 202000 EXCAVATION AND EMBANKMENT.
 - C. AFTER THE CONTRACTOR DISKS THE SEED INTO THE TOPSOIL, THE CONTRACTOR SHALL MULCH THE AREA WITH STRAW MULCH AT 4000 LB/AC AS SPECIFIED IN THE SPECIAL PROVISION FOR ITEM NO. 908503 WETLAND MITIGATION GRASS SEEDING. SECURE THE STRAW MULCH PER THE SPECIAL PROVISION AFTER EACH APPLICATION. THIS WORK SHALL BE PAID FOR UNDER ITEM NO. 911509 MULCHING. ITEM NO. 908020 EROSION CONTROL BLANKET MULCH SHALL BE PLACED ON THE SIDE SLOPES OF THE WETLAND SITE AS SHOWN ON THE WETLAND MITIGATION SITE TYPICAL SECTIONS.
- 12. FOLLOWING APPROVAL OF THE AS-BUILTS, ACCEPTANCE OF STABILIZATION AND COMPLETION OF TREE PLANTING, REMOVE TEMPORARY PORTIONS OF ACCESS ROAD AS SHOWN IN THE PLANS AND RESTORE AREA TO EXISTING GRADE. NO STABLIZATION OR SEEDING REQUIRED. COST FOR REMOVAL SHALL BE INCIDENTAL TO ITEM NO. 211000 REMOVAL OF STRUCTURES AND OBSTRUCTIONS. REMOVE ALL EROSION AND SEDIMENT CONTROLS.
- 13. IT SHALL BE THE CONTRACTOR'S RESPONSIBILITY TO PROVIDE POSITIVE DRAINAGE AND DEWATERING MEASURES AT ALL TIMES DURING WORK ACTIVITIES REQUIRING ANY EXCAVATION WITHIN THE WETLAND MITIGATION SITE. THESE MEASURES ARE INTENDED TO MAINTAIN THE GROUNDWATER LEVEL AT LEAST ONE FOOT BELOW THE EXCAVATION ELEVATION. THE CONTRACTOR SHALL ALSO PROVIDE NECESSARY DEWATERING TO STABILIZE SLOPE EXCAVATION DURING CONSTRUCTION UNTIL THE SLOPES STABILIZE AS DETERMINED BY THE ENGINEER. IN ADDITION, IT SHALL BE THE CONTRACTOR'S RESPONSIBILITY TO GATHER ALL NECESSARY DATA AND INFORMATION TO OBTAIN ANY PERMITS FOR PUMPING GROUNDWATER THAT MAY BE REQUIRED FOR THEIR OPERATIONS. PUMPING PERMITS ARE OBTAINABLE FROM THE DNREC DIVISION OF WATER RESOURCES WATER SUPPLY WELL PERMITTING AND LICENSING BRANCH. ALL COSTS SHALL BE INCIDENTAL TO ITEM NO. 908020 EROSION CONTROL BLANKET MULCH.
- 14. THE DELAWARE FOREST SERVICE SHALL BE ALLOWED ACCESS TO THE WETLAND MITIGATION SITE, AT THE DIRECTION OF THE DELDOT ENGINEER, AFTER DELDOT ACCEPTANCE AND SEEDING IS COMPLETED TO INSTALL THE REQUIRED PLANTINGS.

15. THE WETLAND MITIGATION GRASS SEED MIX SHALL BE IN ACCORDANCE WITH THE SPECIAL PROVISION FOR ITEM NO. 908503 - WETLAND MITIGATION GRASS SEEDING AND USED TO SEED THE FINISHED GRADES, AS SHOWN ON THE PLANS. AREAS SEEDED SHALL INCLUDE THE WETLAND MITIGATION SITE BOTTOM, SLOPES, AND SURROUNDING UPLAND AREAS, INCLUDING THE FORESTED UPLAND AREA. CONTRACTOR SHALL SCHEDULE AND COMPLETE CONSTRUCTION SO THAT THE SITE CAN BE STABILIZED WITHIN 14 DAYS AND MEET THE SEEDING WINDOW BELOW:

SEPTEMBER 1ST TO NOVEMBER 15TH

- 16. THE REMOVAL AND INSTALLATION OF ALL DESIGNATED PIEZOMETERS SHALL BE COMPLETED BY A CERTIFIED WELL DRILLER.
 REMOVAL COST INCIDENTAL TO ITEM 211000 REMOVAL OF STRUCTURES AND OBSTRUCTIONS. INSTALLATION TO BE PAID
 UNDER ITEM 202514 PIEZOMETER. IT IS THE RESPONSIBILITY OF THE WELL DRILLER TO OBTAIN AND COMPLY WITH THE REQUIRED
 WELL PERMITS. COST OF OBTAINING THESE PERMITS IS INCLUDED IN ITEM NO. 202514 PIEZOMETER.
- 17. AS NOTED IN THE CONTRACT DOCUMENTS AND DIRECTED BY THE ENGINEER, MATERIALS ARE TO BE STOCKPILED FOR LATER USE IN THE PROJECT. THE TOPSOIL FROM THESE STOCKPILE AREAS SHALL BE REMOVED IN ITS ENTIRETY AND STOCKPILED FOR REPLACEMENT IN THE AREA WHERE IT WAS EXCAVATED. THE EXCAVATION AND STOCKPILING OF THE TOPSOIL SHALL BE MEASURED FOR PAYMENT UNDER ITEM NO. 202000 EXCAVATION AND EMBANKMENT. THE TOPSOIL SHALL BE REPLACED IN REASONABLY CLOSE CONFORMITY TO THE ORIGINAL LINES, GRADES AND ELEVATIONS AS DIRECTED BY THE ENGINEER. ALL COSTS ASSOCIATED WITH REPLACING THE FULL DEPTH OF THE TOPSOIL REMOVED SHALL BE PAID UNDER ITEM NO. 908010 TOPSOILING, 6" DEPTH. THE AREA OF TOPSOIL REPLACED SHALL ONLY BE MEASURED ONCE FOR PAYMENT UNDER ITEM NO. 908010 TOPSOILING, 6" DEPTH OR ITEM NO. 908006 TOPSOILING. SEEDING AND MULCHING OF THE REPLACED TOPSOIL SHALL BE PERFORMED UNDER THE APPLICABLE BID ITEMS.
- 18. ALL SURVEY WORK, INCLUDING LAYOUT AND AS-BUILTS, FOR THE WETLAND MITIGATION SITE SHALL BE BASED OFF A SINGLE MASTER CONTROL POINT AS IDENTIFIED ON THE WETLAND MITIGATION SITE CONTROL DATA PLANS. THIS ELEVATION SHALL NOT BE CHANGED OR MODIFIED. THE MASTER CONTROL POINT SHALL NOT BE DISTURBED.
- 19. ANY NATIVE WOODY DEBRIS CLEARED ONSITE SHALL BE STOCKPILED AND PLACED INTO THE WETLAND FOLLOWING FINAL TOPSOIL GRADING AND BEFORE OR CONCURRENT TO SEEDING. COARSE WOODY DEBRIS SHOULD BE RANDOMLY DISTRIBUTED ACROSS THE BOTTOM OF THE SITE. THE CONTRACTOR SHALL CONSULT WITH DELDOT ENVIRONMENTAL OR THEIR DESIGNATED CONSULTANT FOR PLACEMENT.
- 20. AREA DEPICTED FOR PERMANENT ACCESS IS FOR ILLUSTRATION ONLY. PERMANENT ACCESS ROAD SHALL NOT BE CONSTRUCTED UNDER THIS CONTRACT.
- 21. CONTRACTOR SHALL NOT DISTURB CROPS AFTER PLANTING OR BEFORE HARVEST.
- 22. REMOVAL OF DEBRIS IS INCIDENTAL TO ITEM NO. 211000 REMOVAL OF STRUCTURES AND OBSTRUCTIONS.
- 23. REFER TO MASTER EARTHWORK SUMMARY FOR EARTHWORK DETAILS.
- 24. REMOVE WELLS AND ABANDON PER DNREC GUIDELINES. CONTRACTOR MUST CONTACT CENTURY ENGINEERING BEFORE REMOVAL OF WELLS TO RETRIEVE EQUIPMENT FROM WELLS:

EMAIL: TJAUSTIN@CENTURYENG.COM

PHONE: (302) 734 - 9188


| Company | Phone | P


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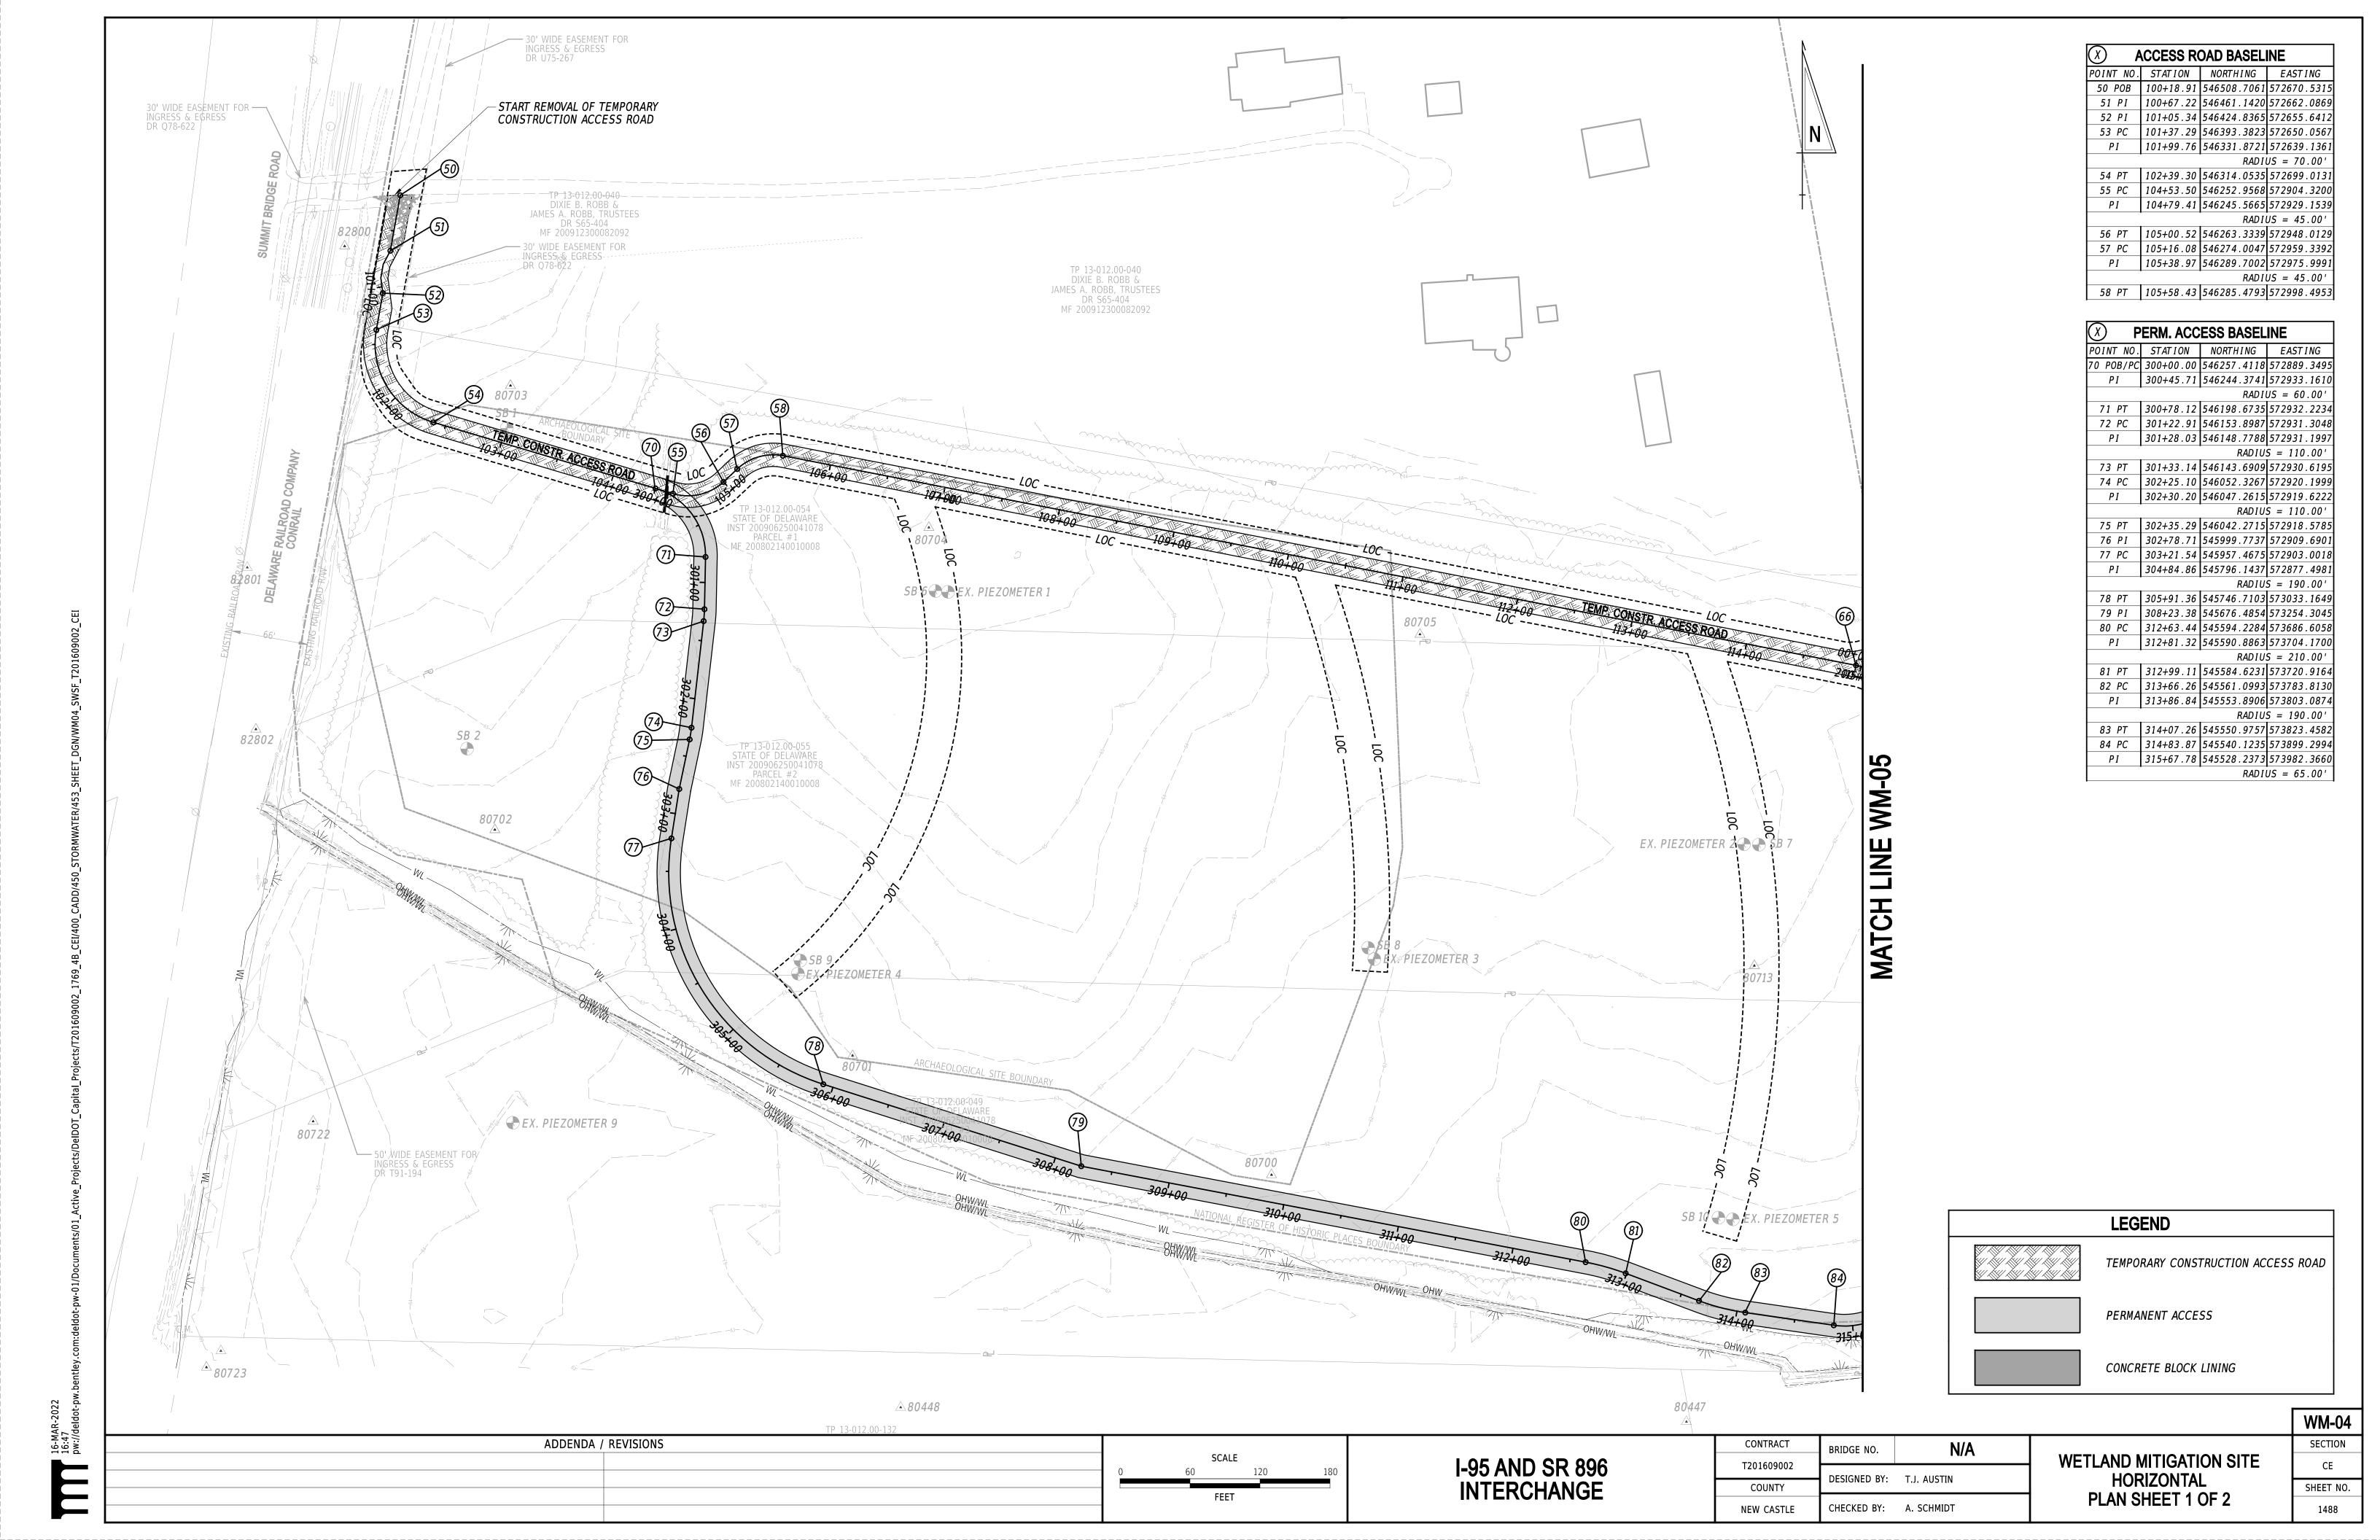
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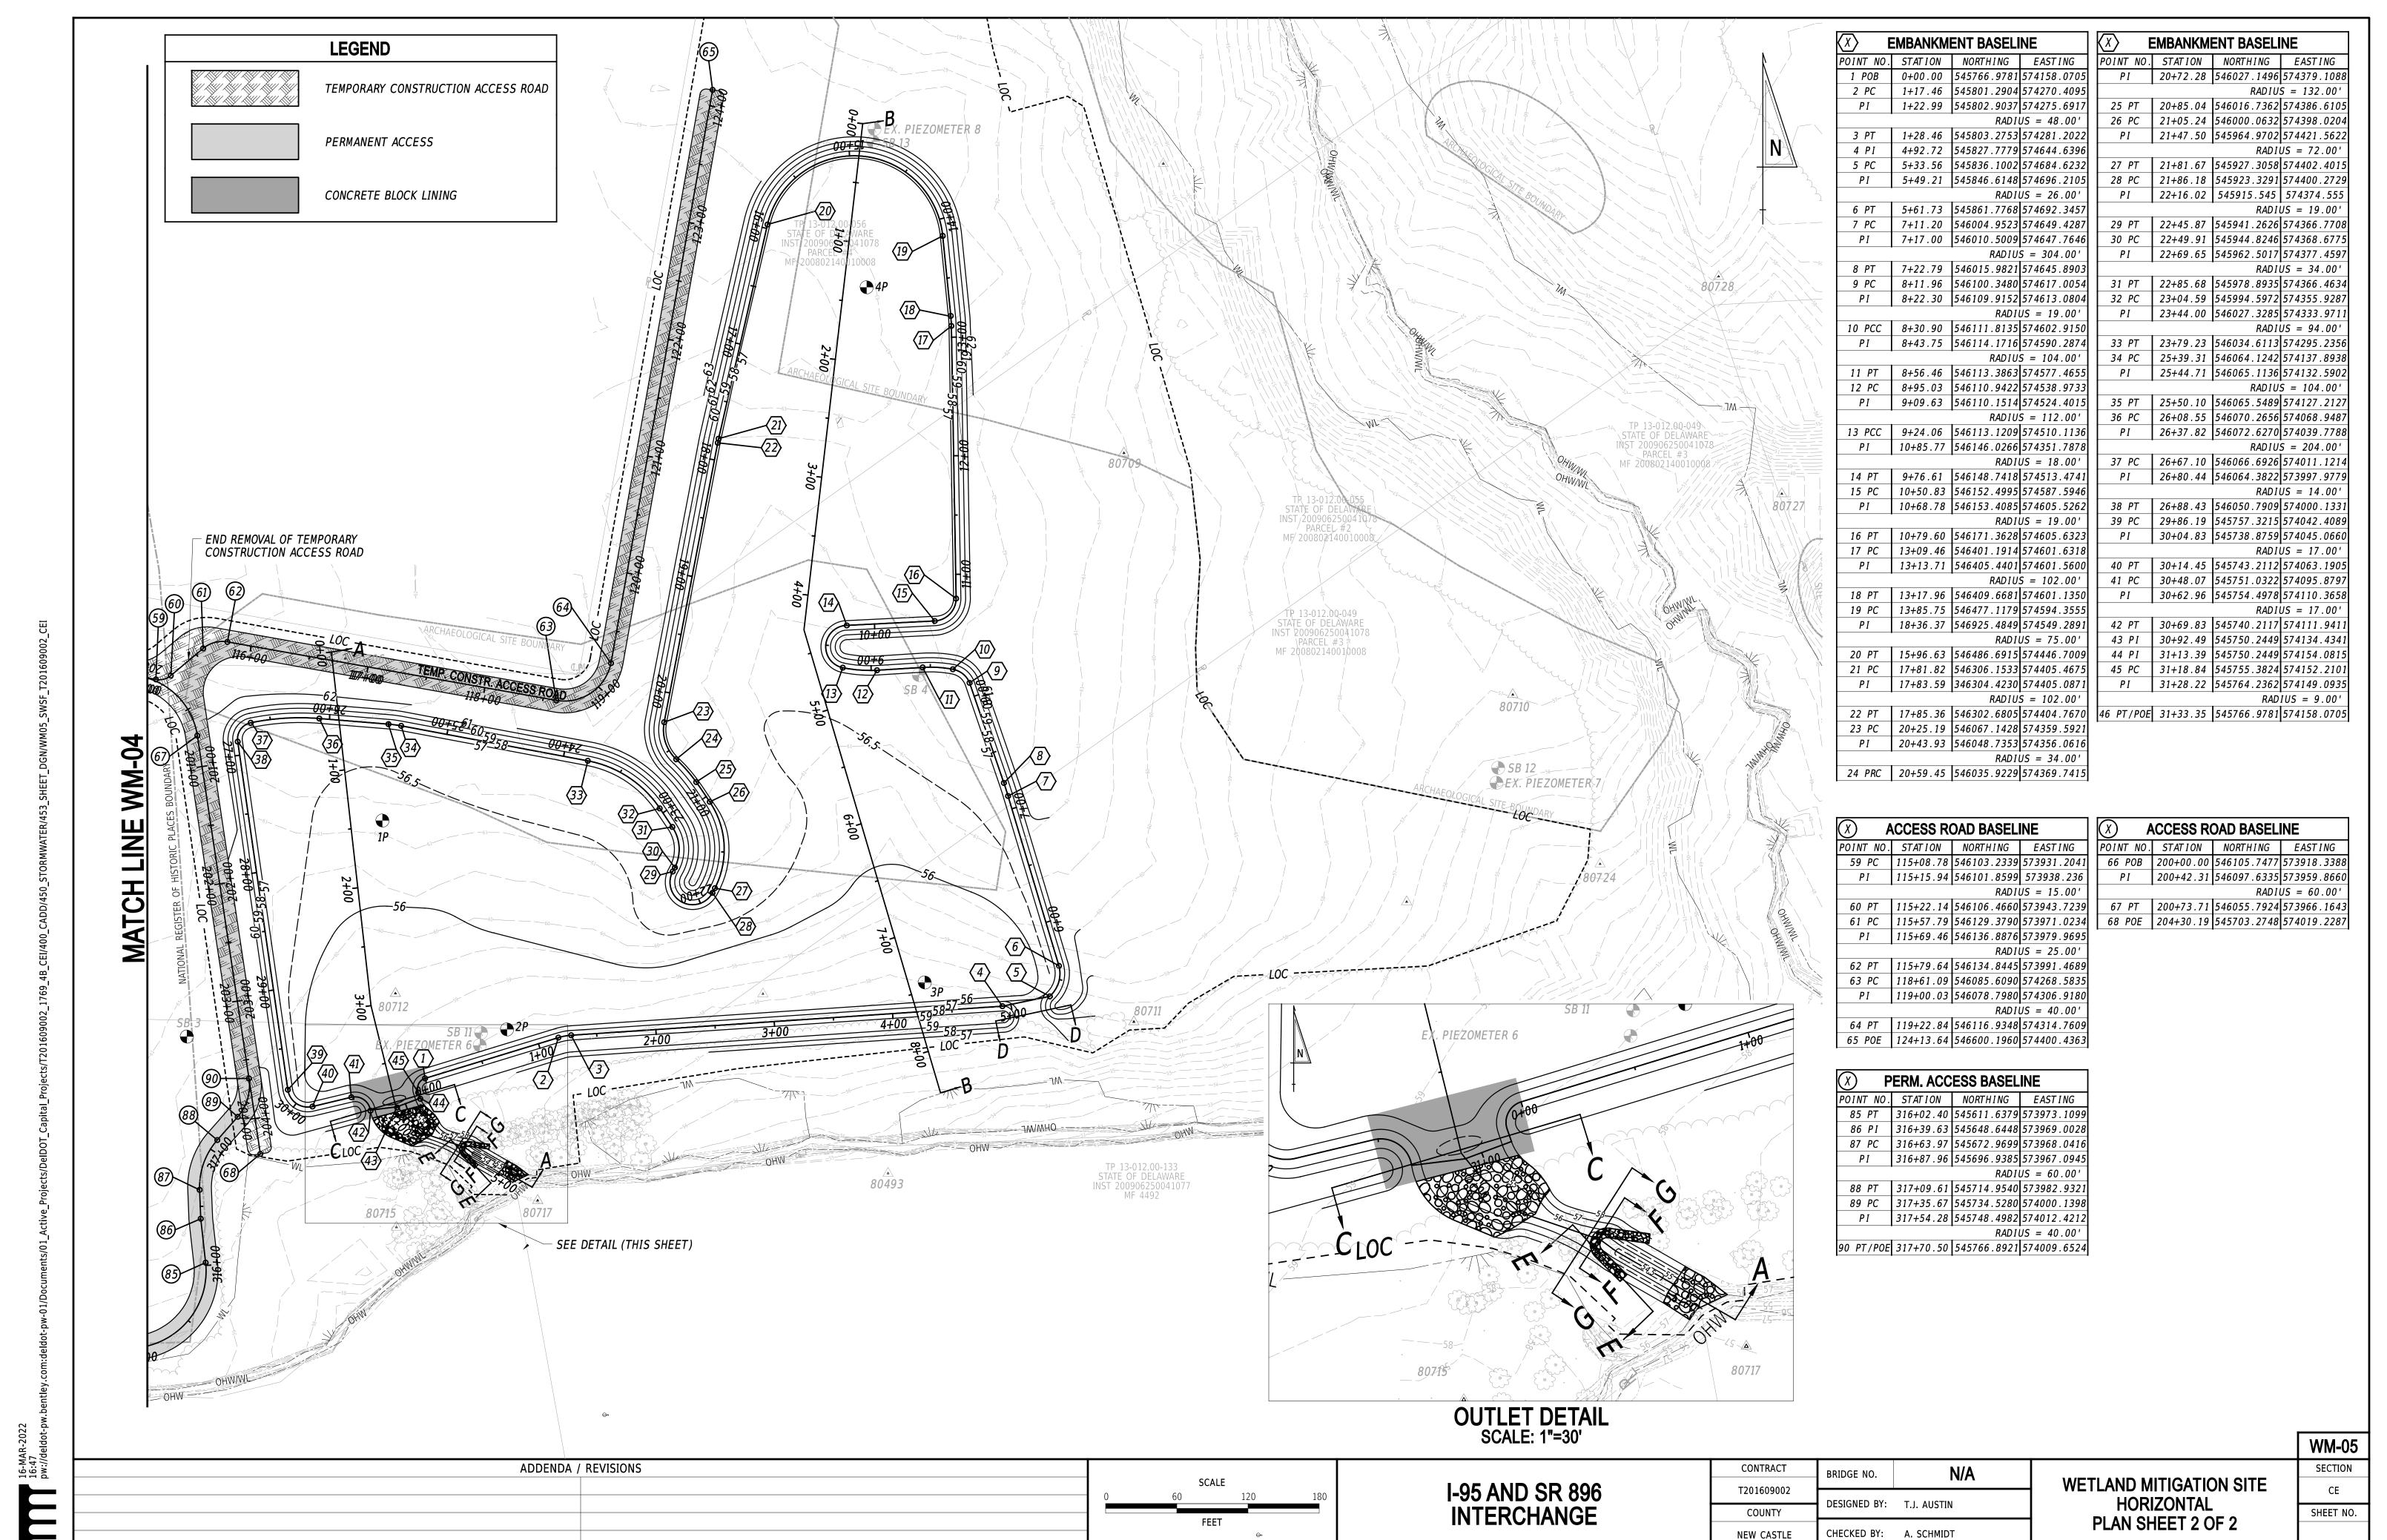
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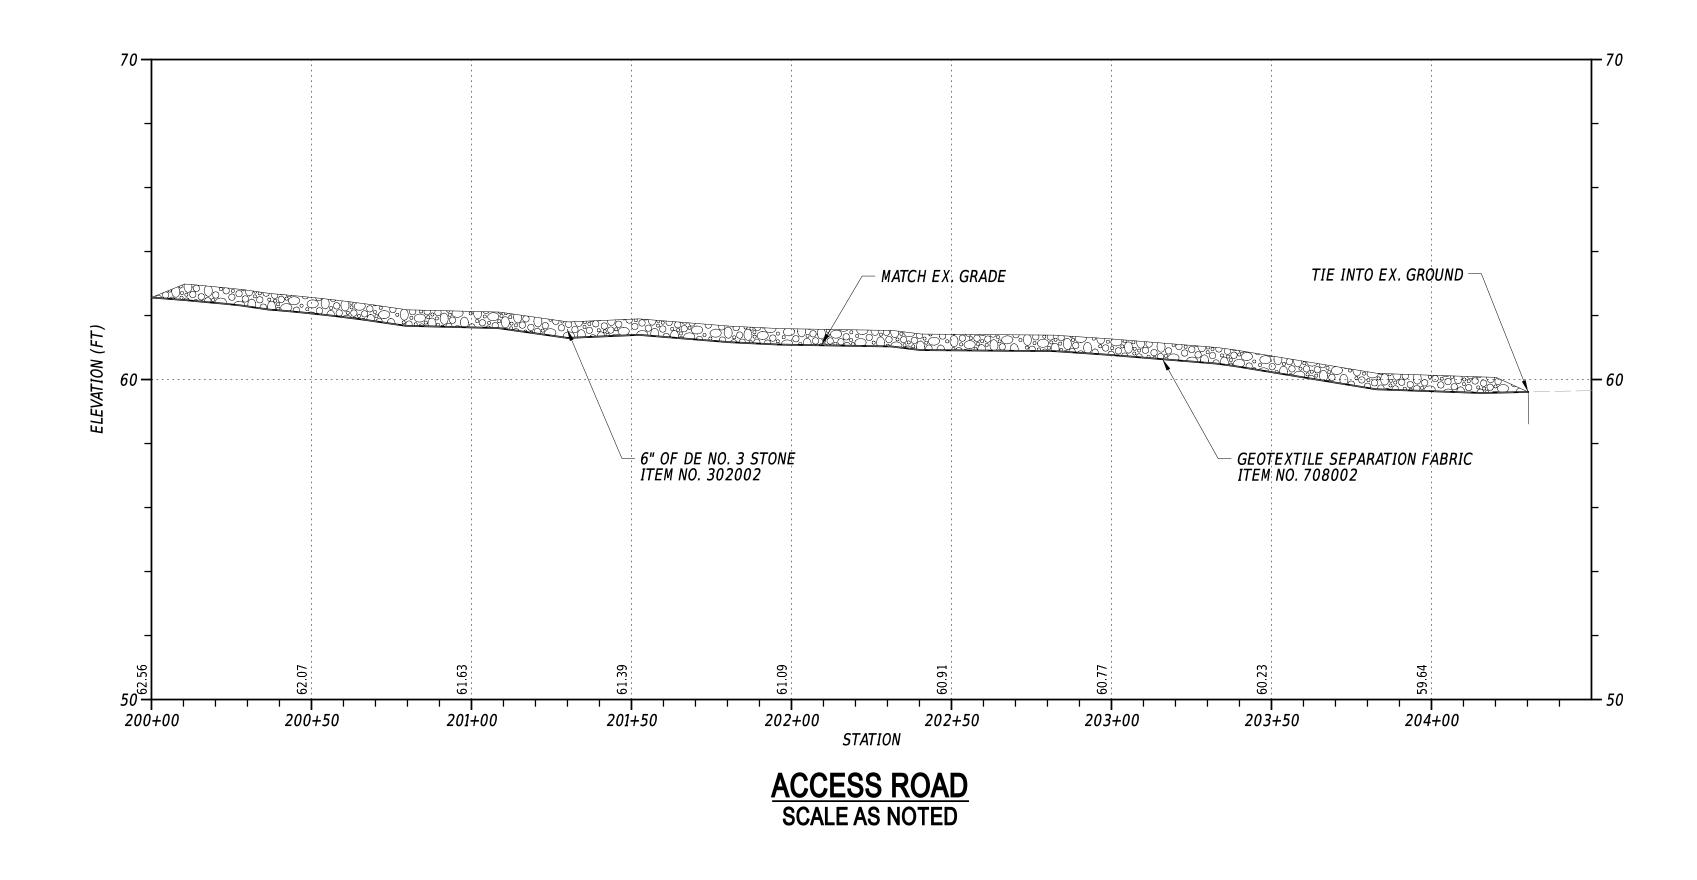
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ADDENDA / REVISIONS

WM-08

CE


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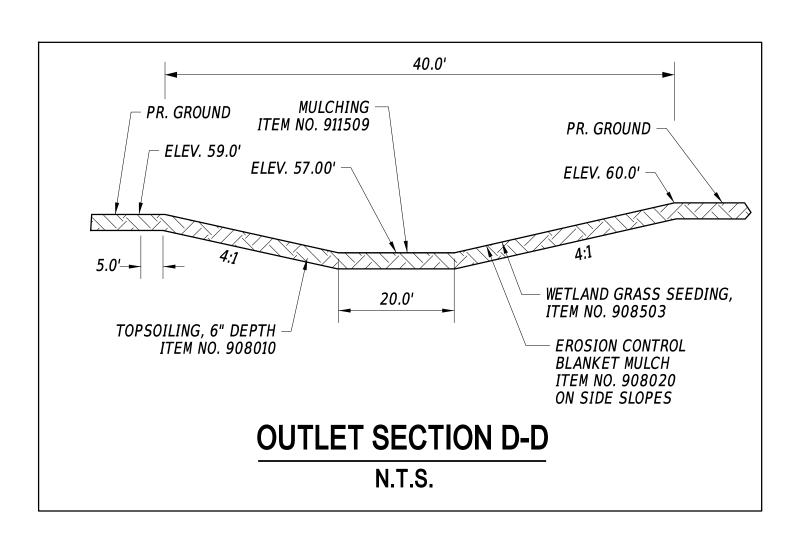
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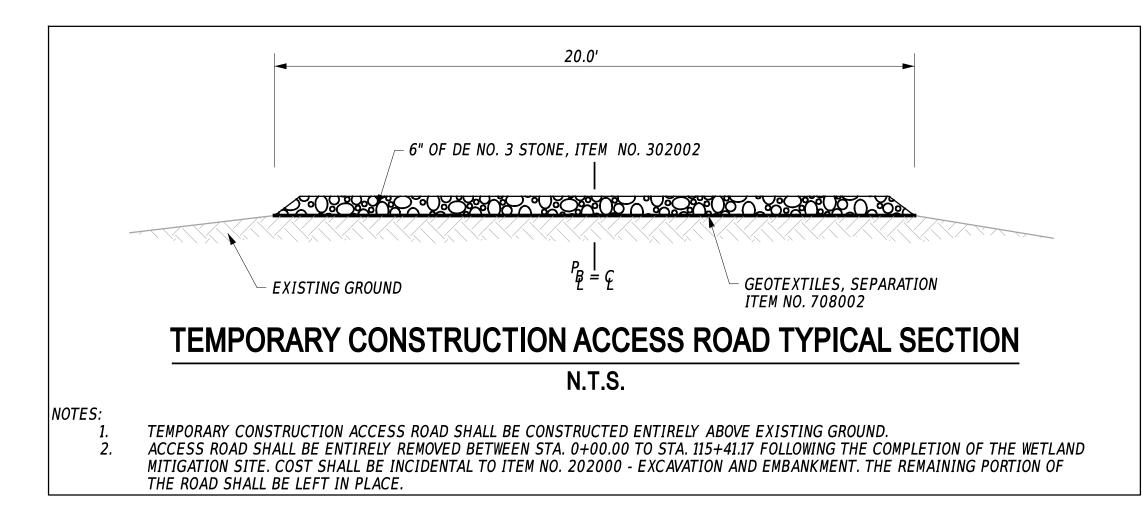
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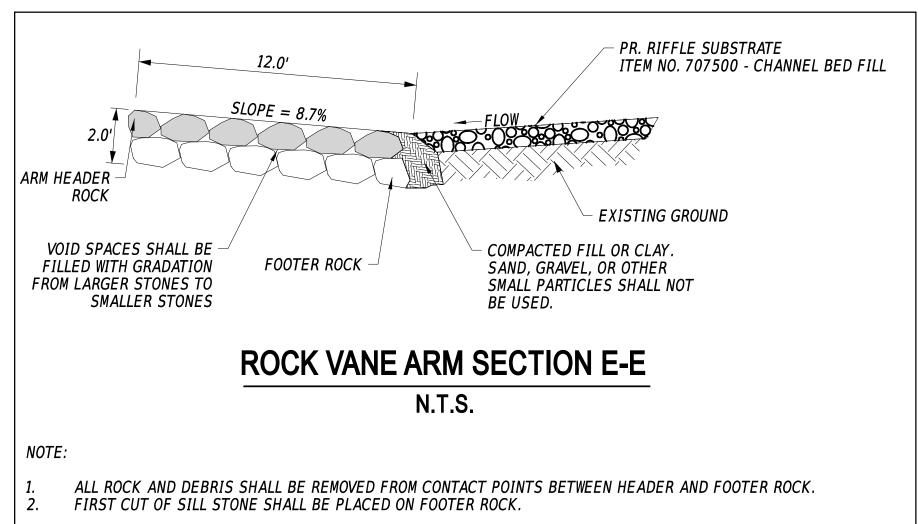
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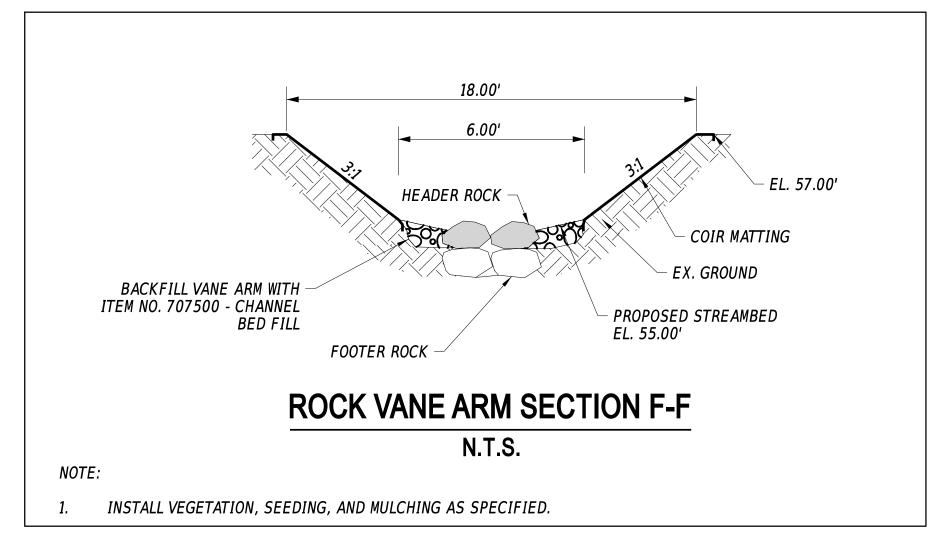
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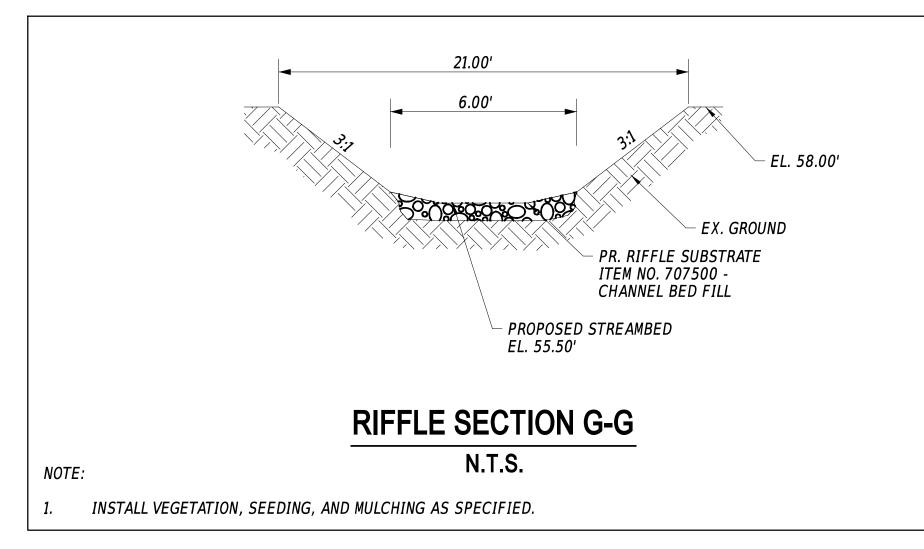


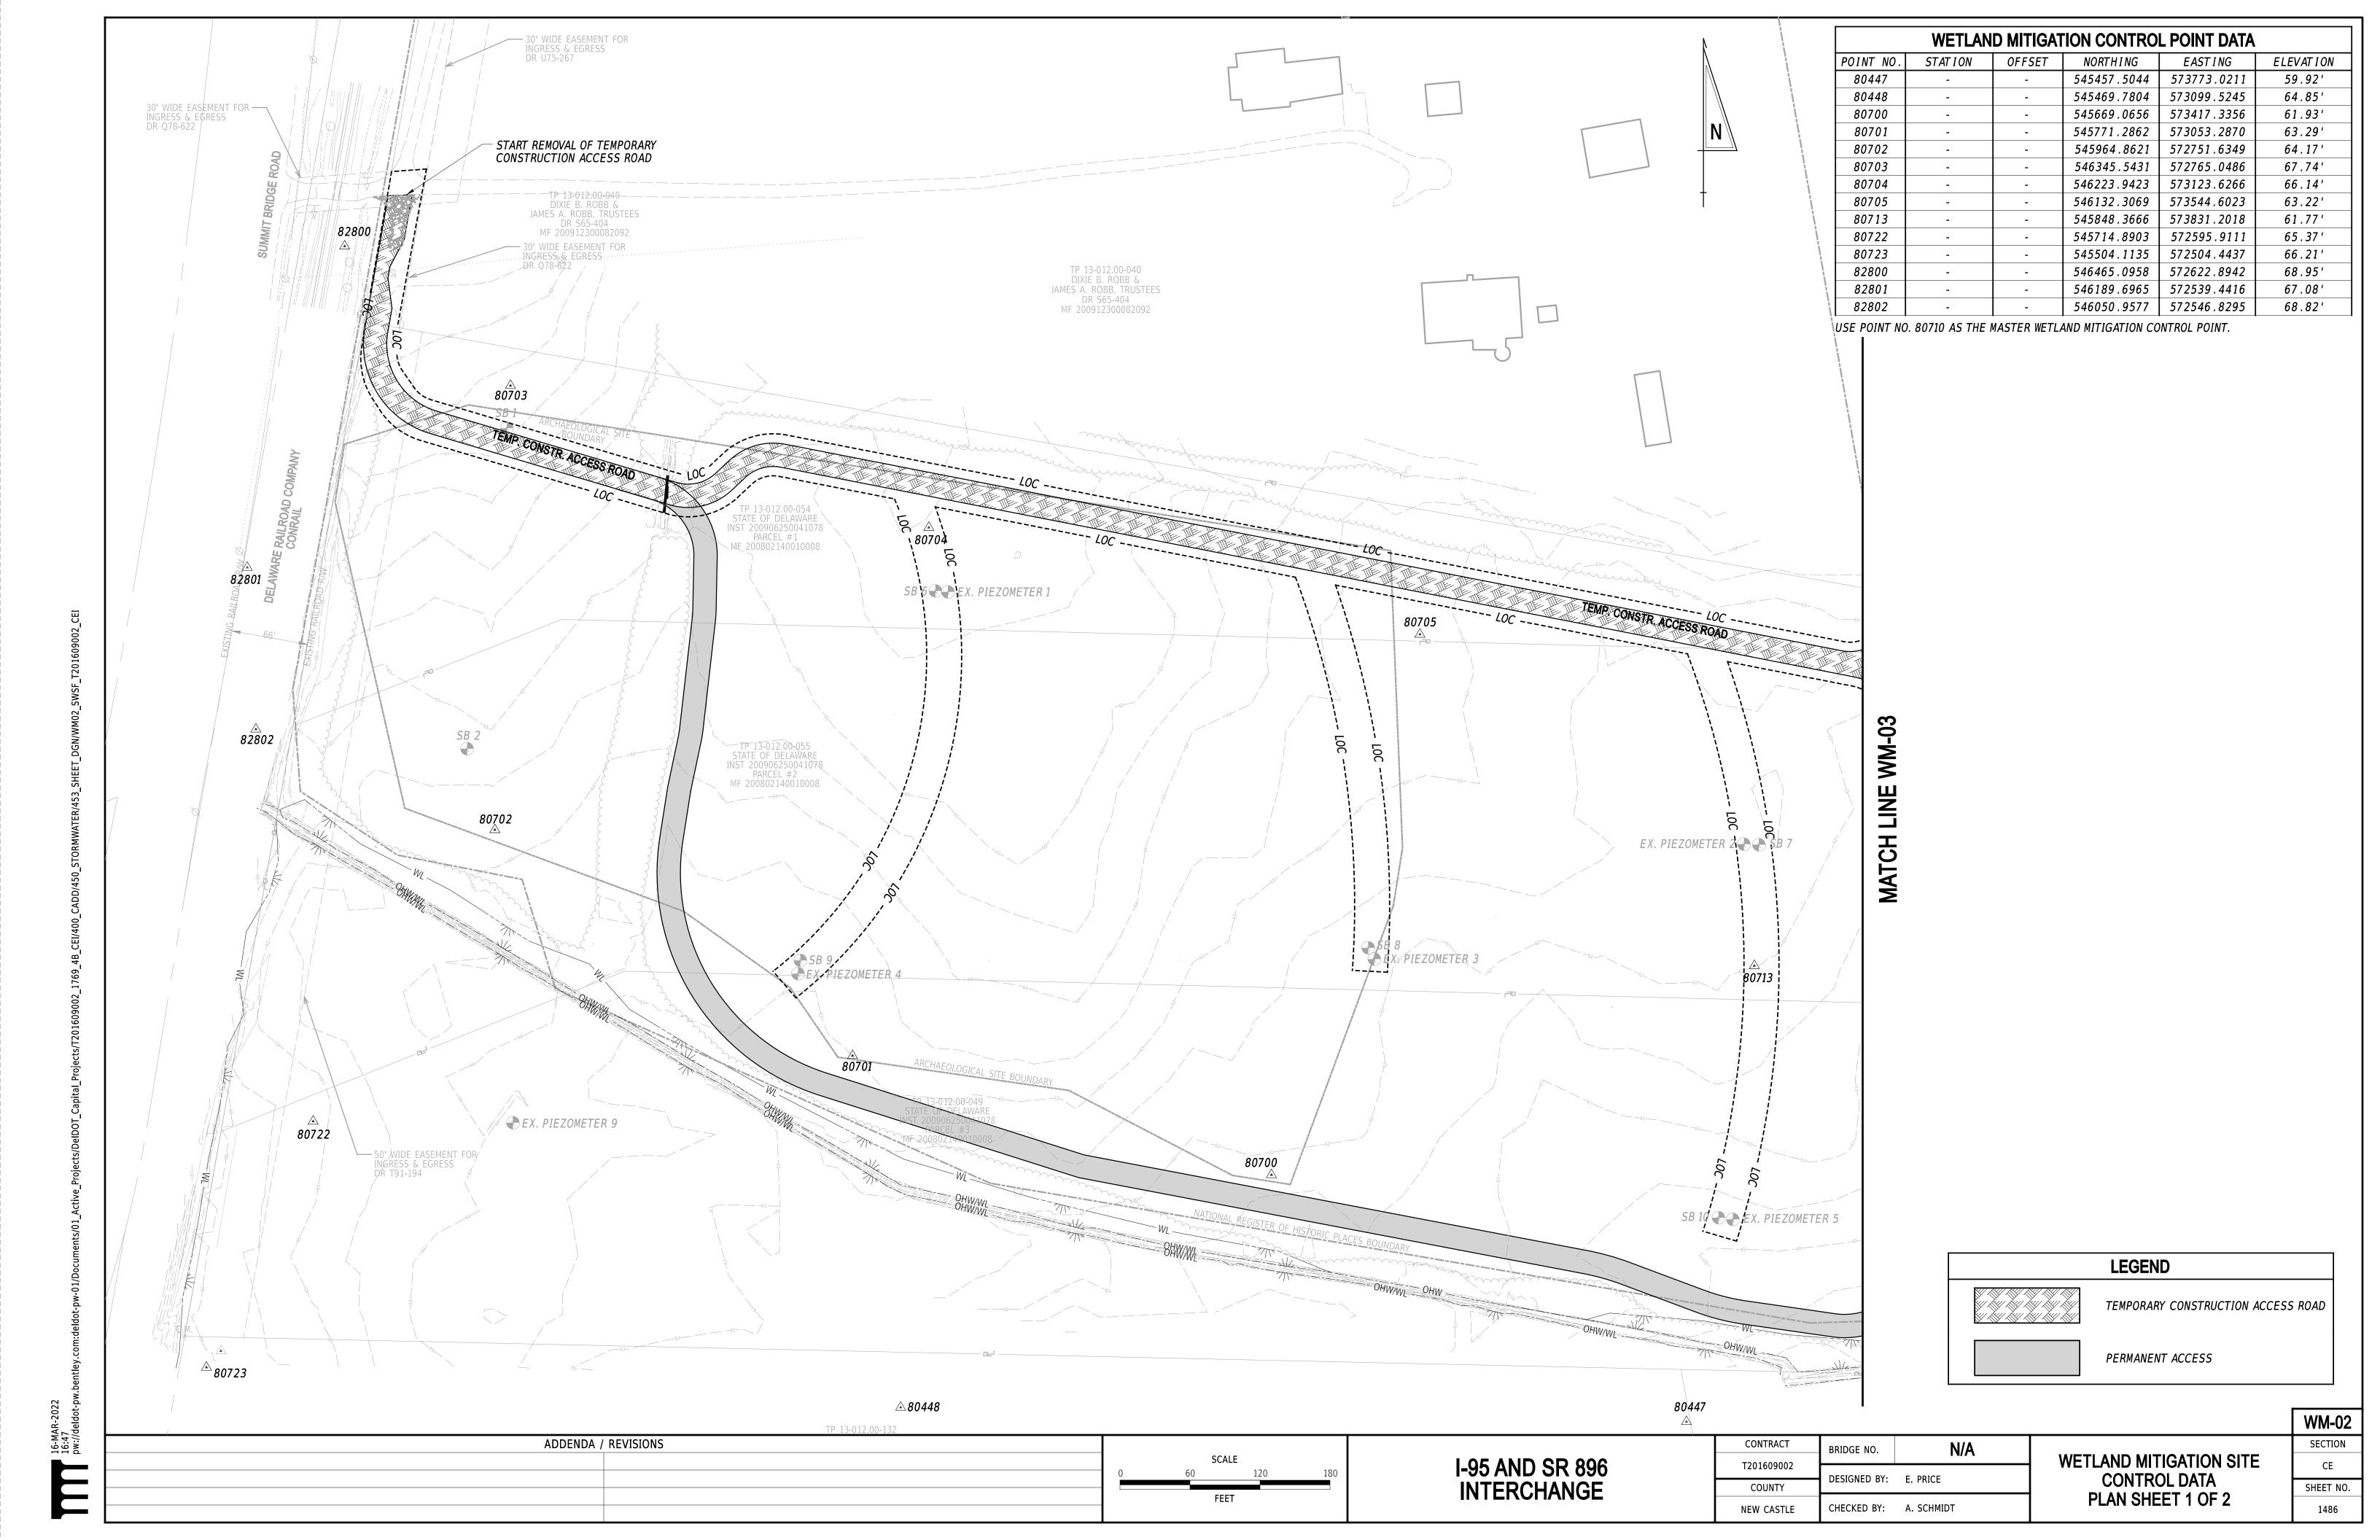


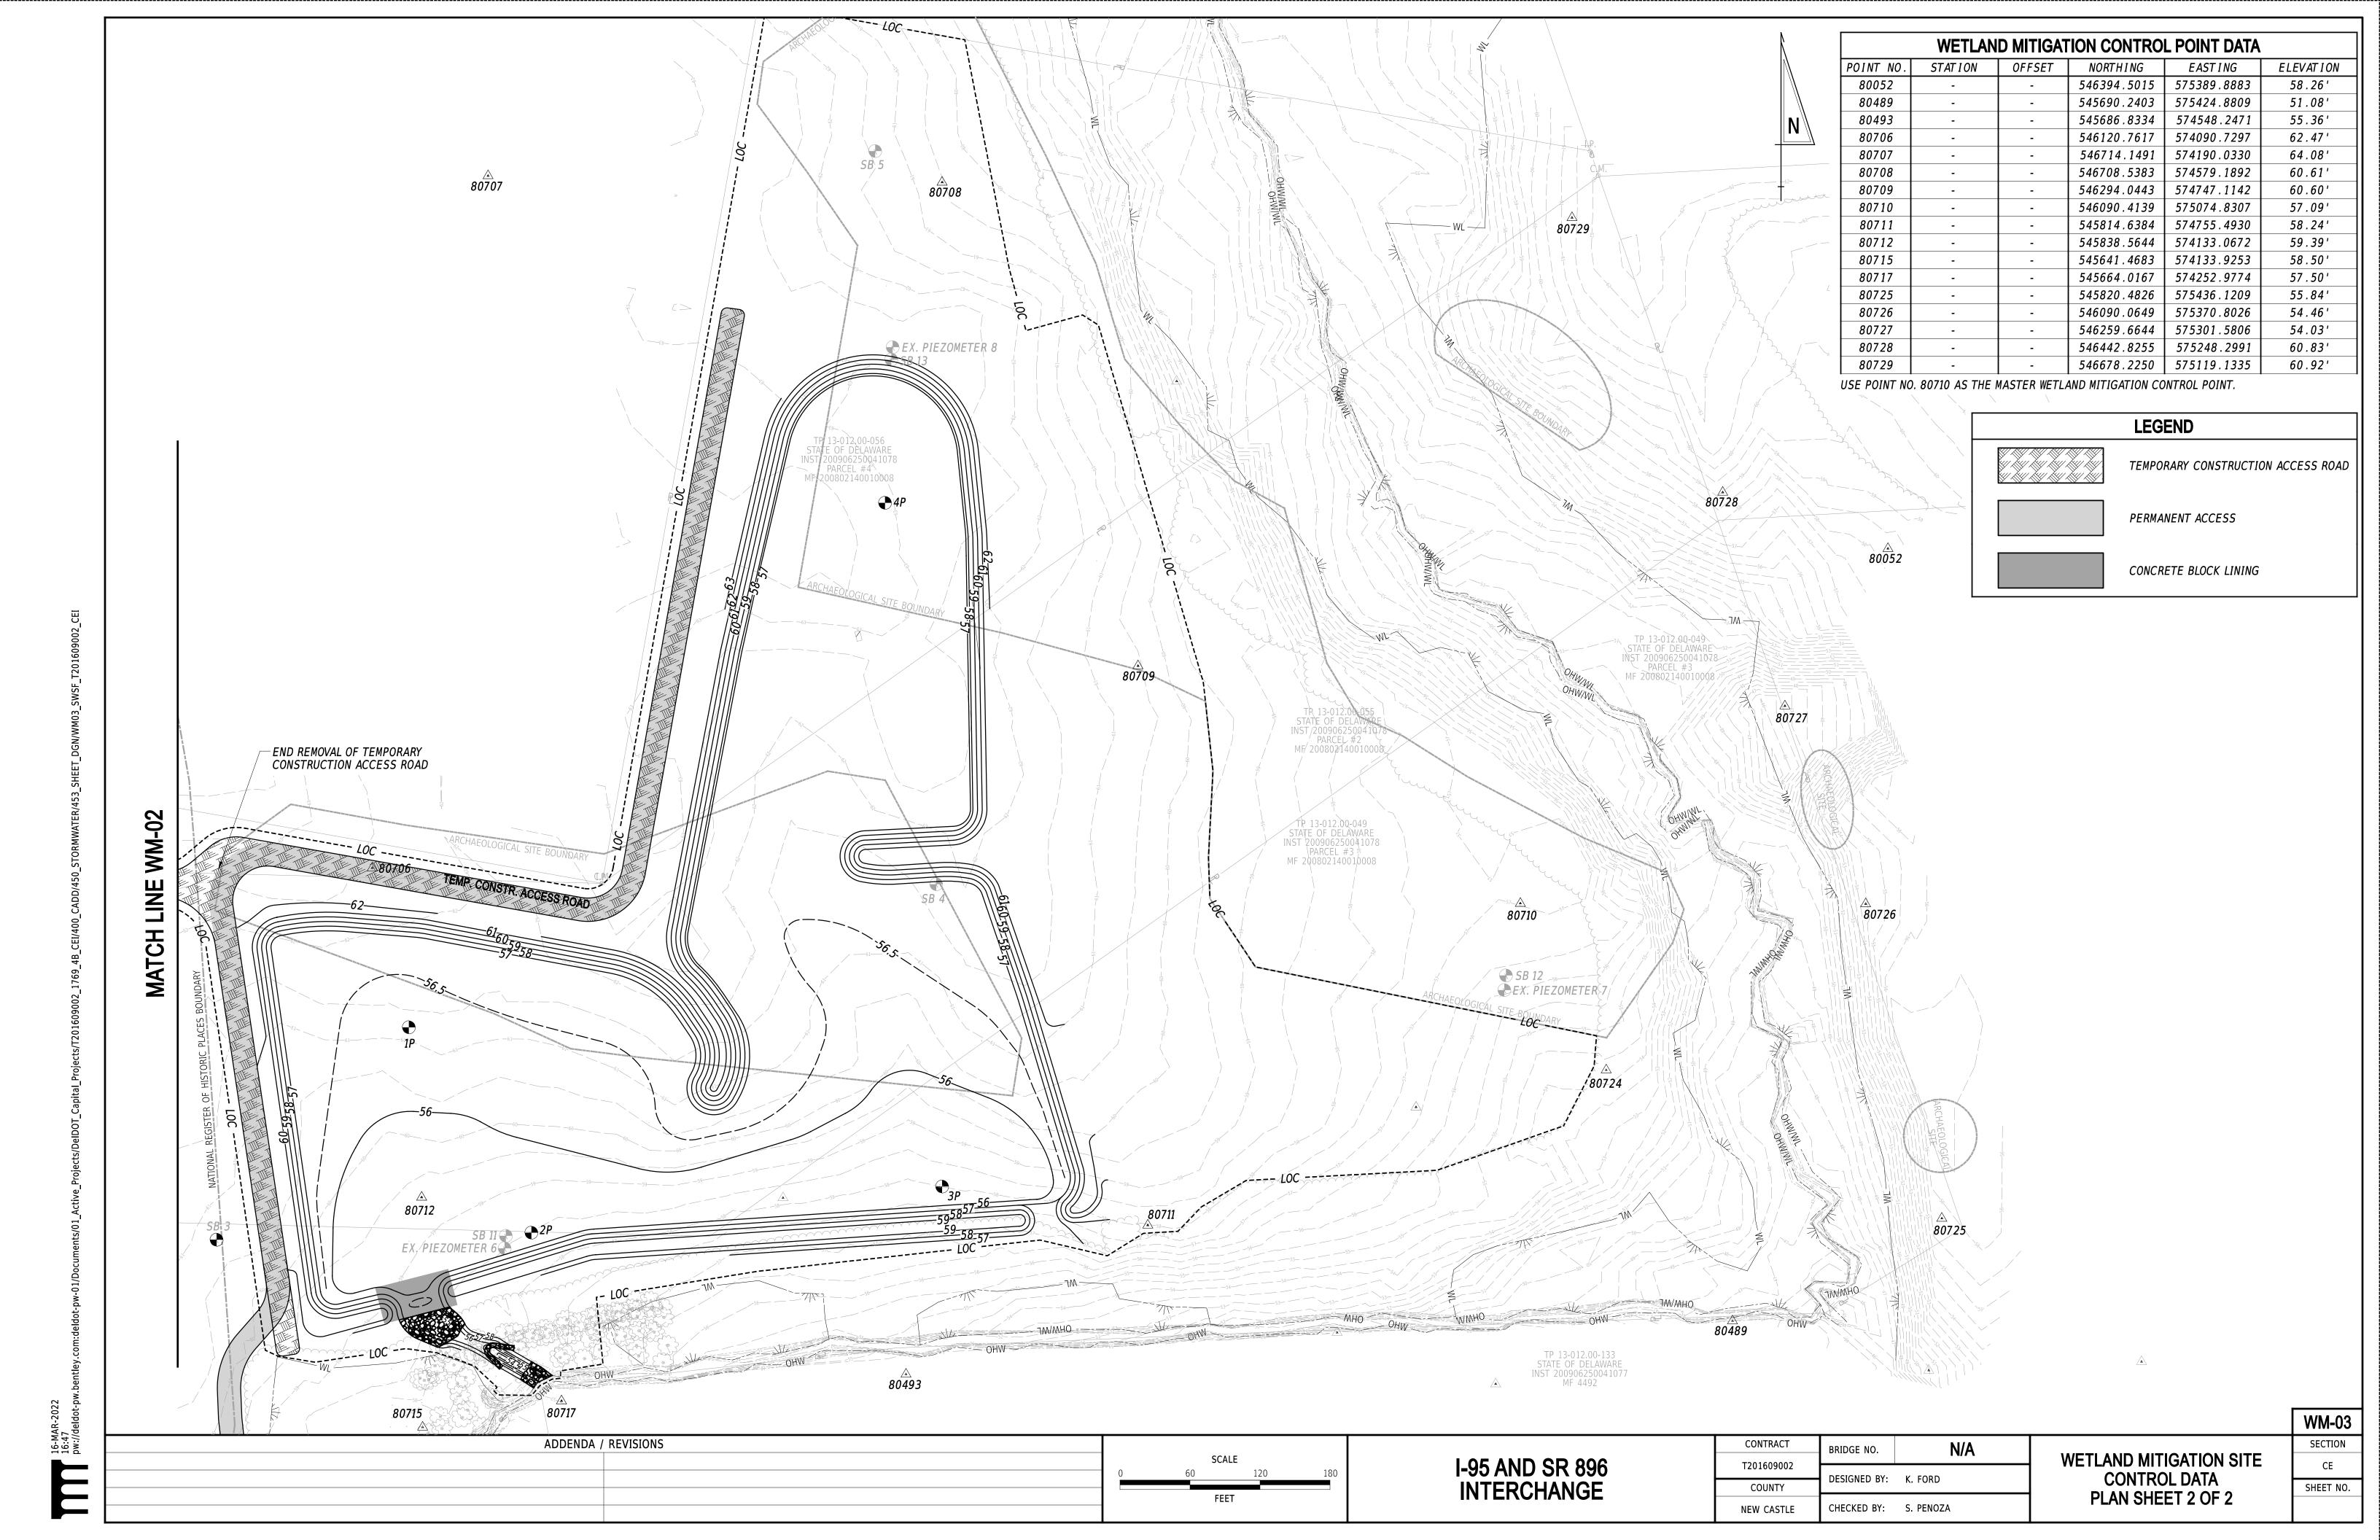





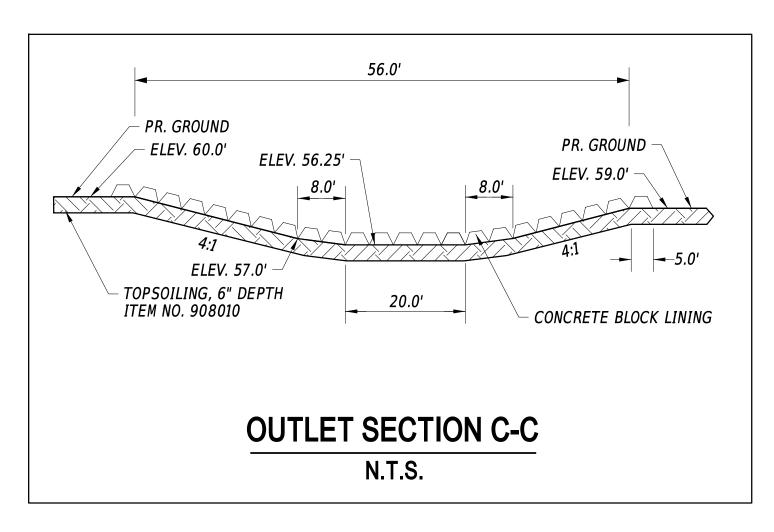

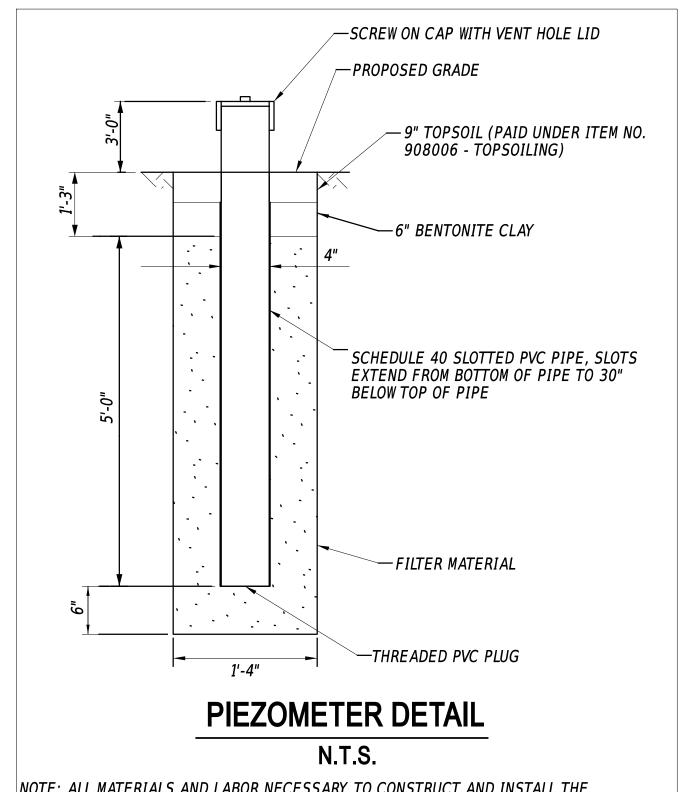

NOTE: ALL MATERIALS AND LABOR NECESSARY TO CONSTRUCT AND INSTALL THE PIEZOMETER, INCLUDING BUT NOT LIMITED TO A CAP, BENTONITE CLAY, PVC PIPE, FILTER MATERIAL, AND THREADED PVC PLUG, SHALL BE INCLUDED UNDER ITEM NO. 202514 - PIEZOMETER.

ADDENDA / REVISIONS

I-95 AND SR 896 SCALE AS NOTED INTERCHANGE

N/A BRIDGE NO. T201609002 DESIGNED BY: E. PRICE COUNTY CHECKED BY: A. SCHMIDT **NEW CASTLE**


WETLAND MITIGATION SITE DETAILS

WM-09

SECTION

CE

SHEET NO.

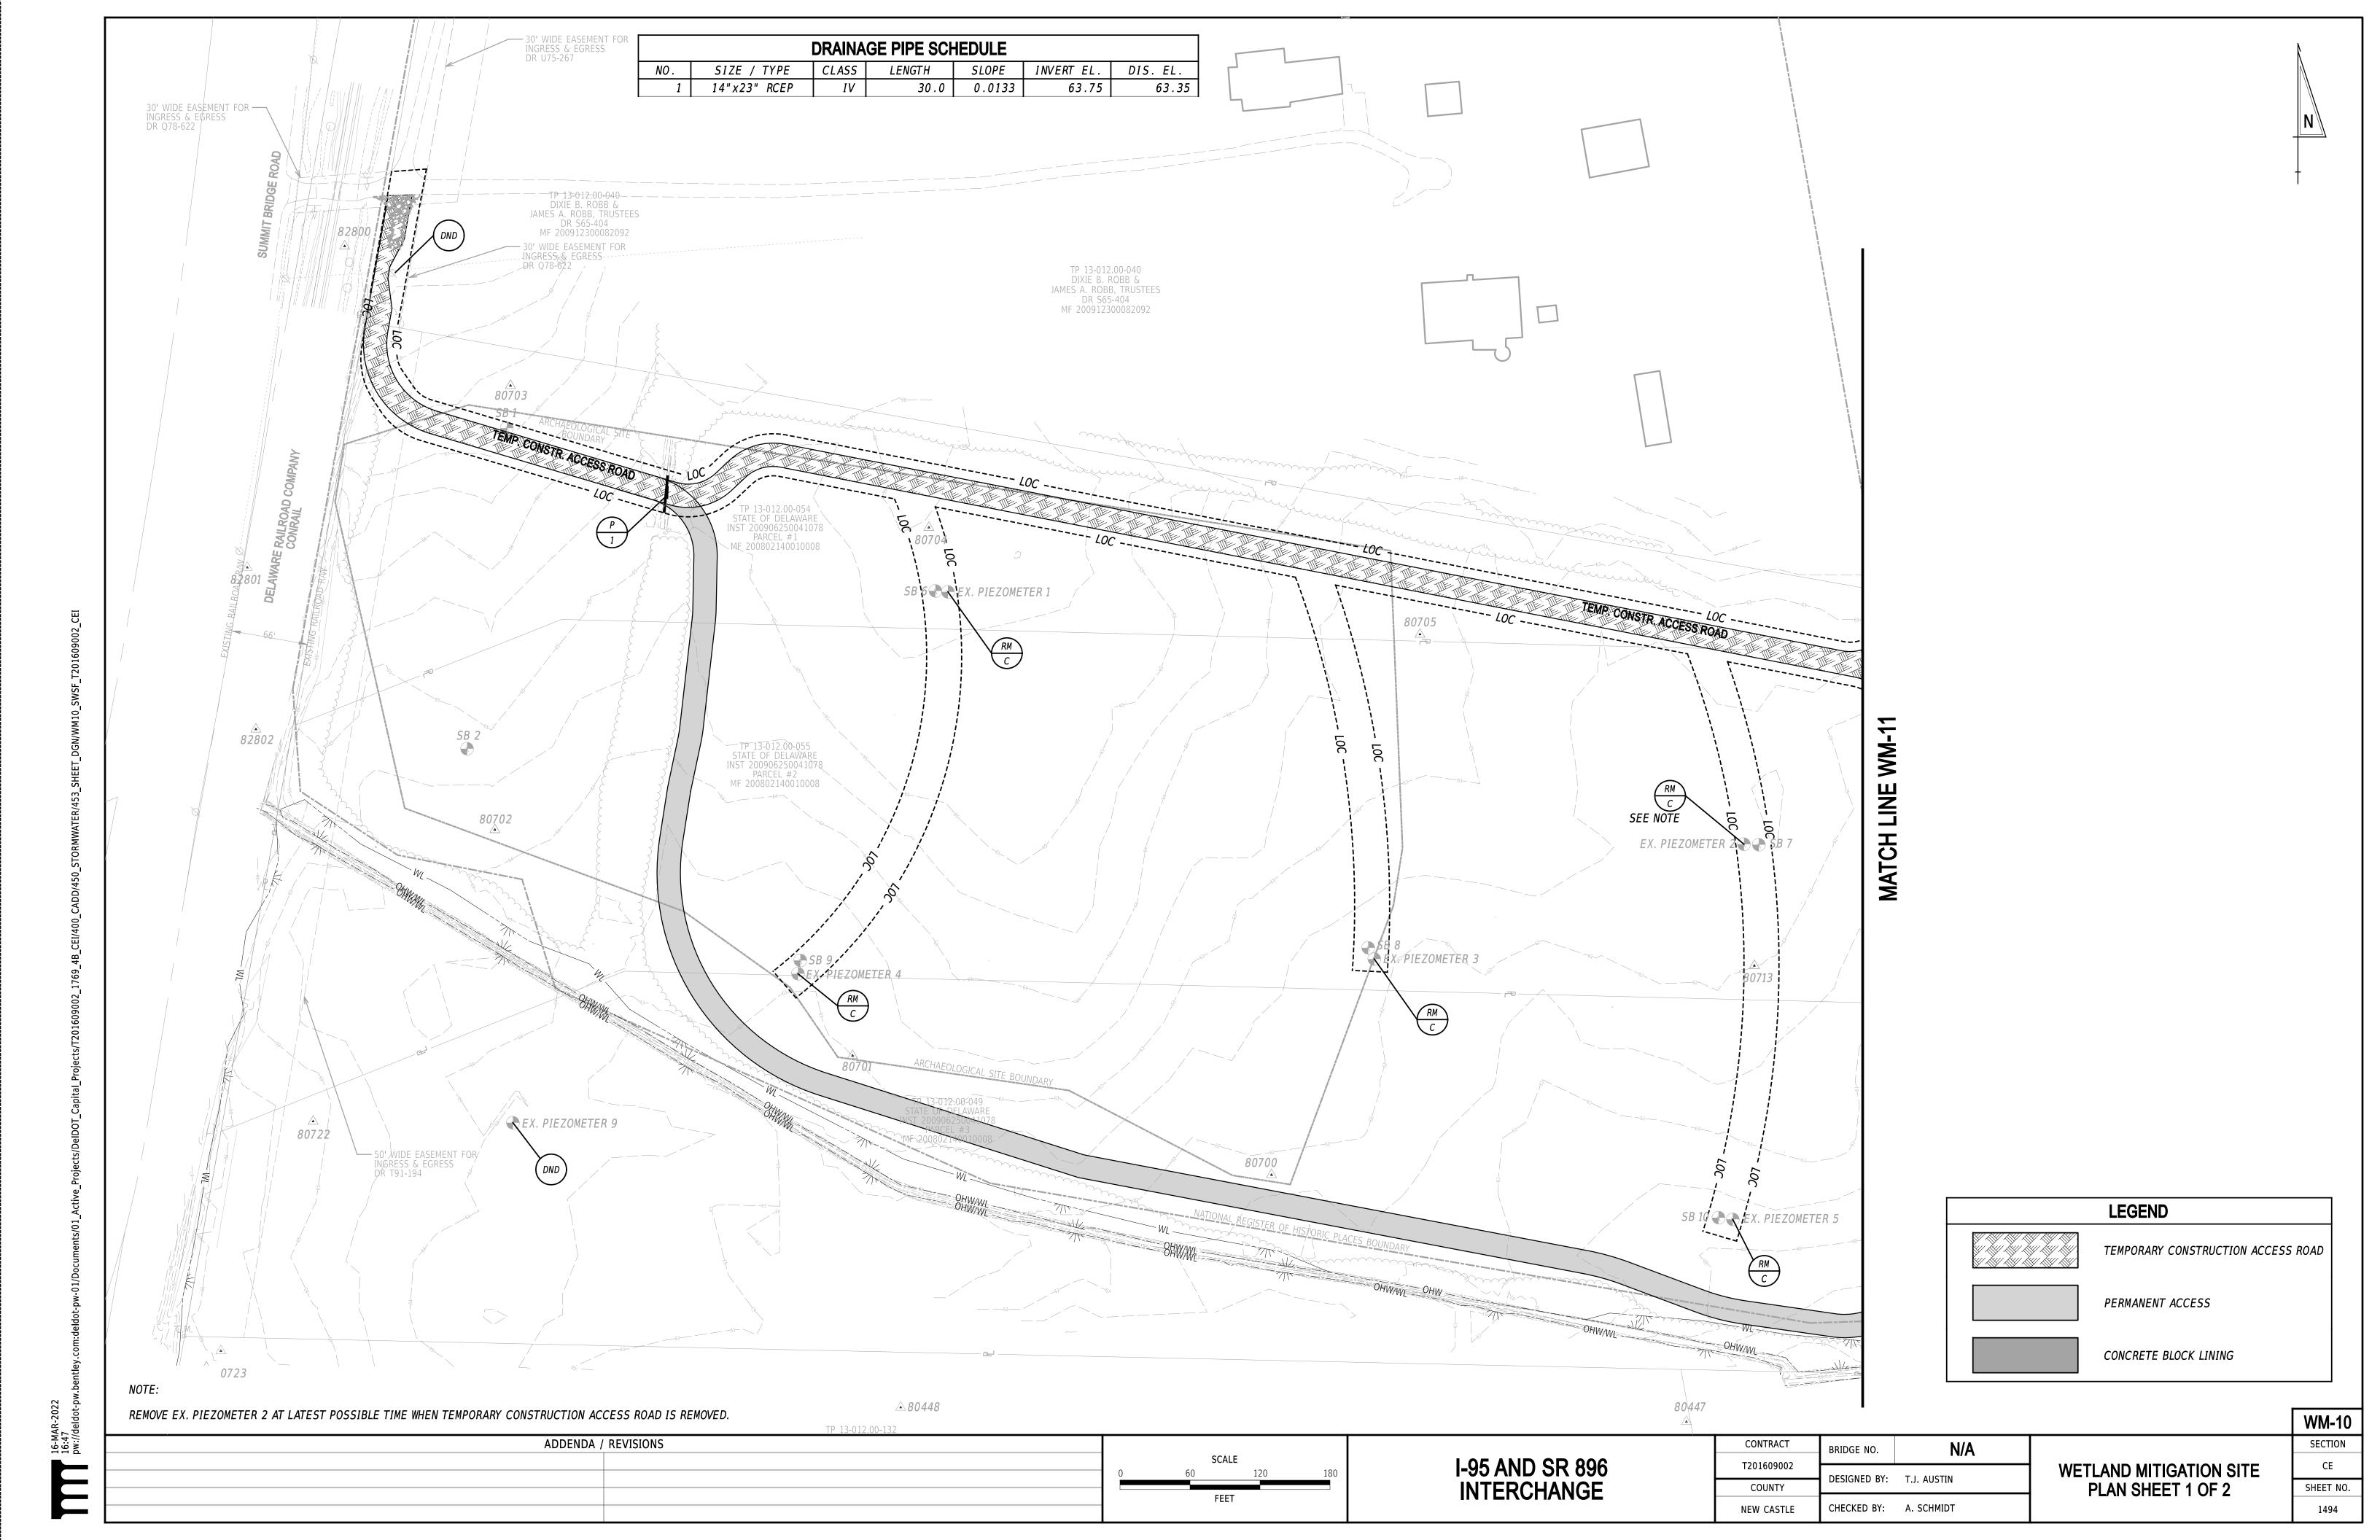





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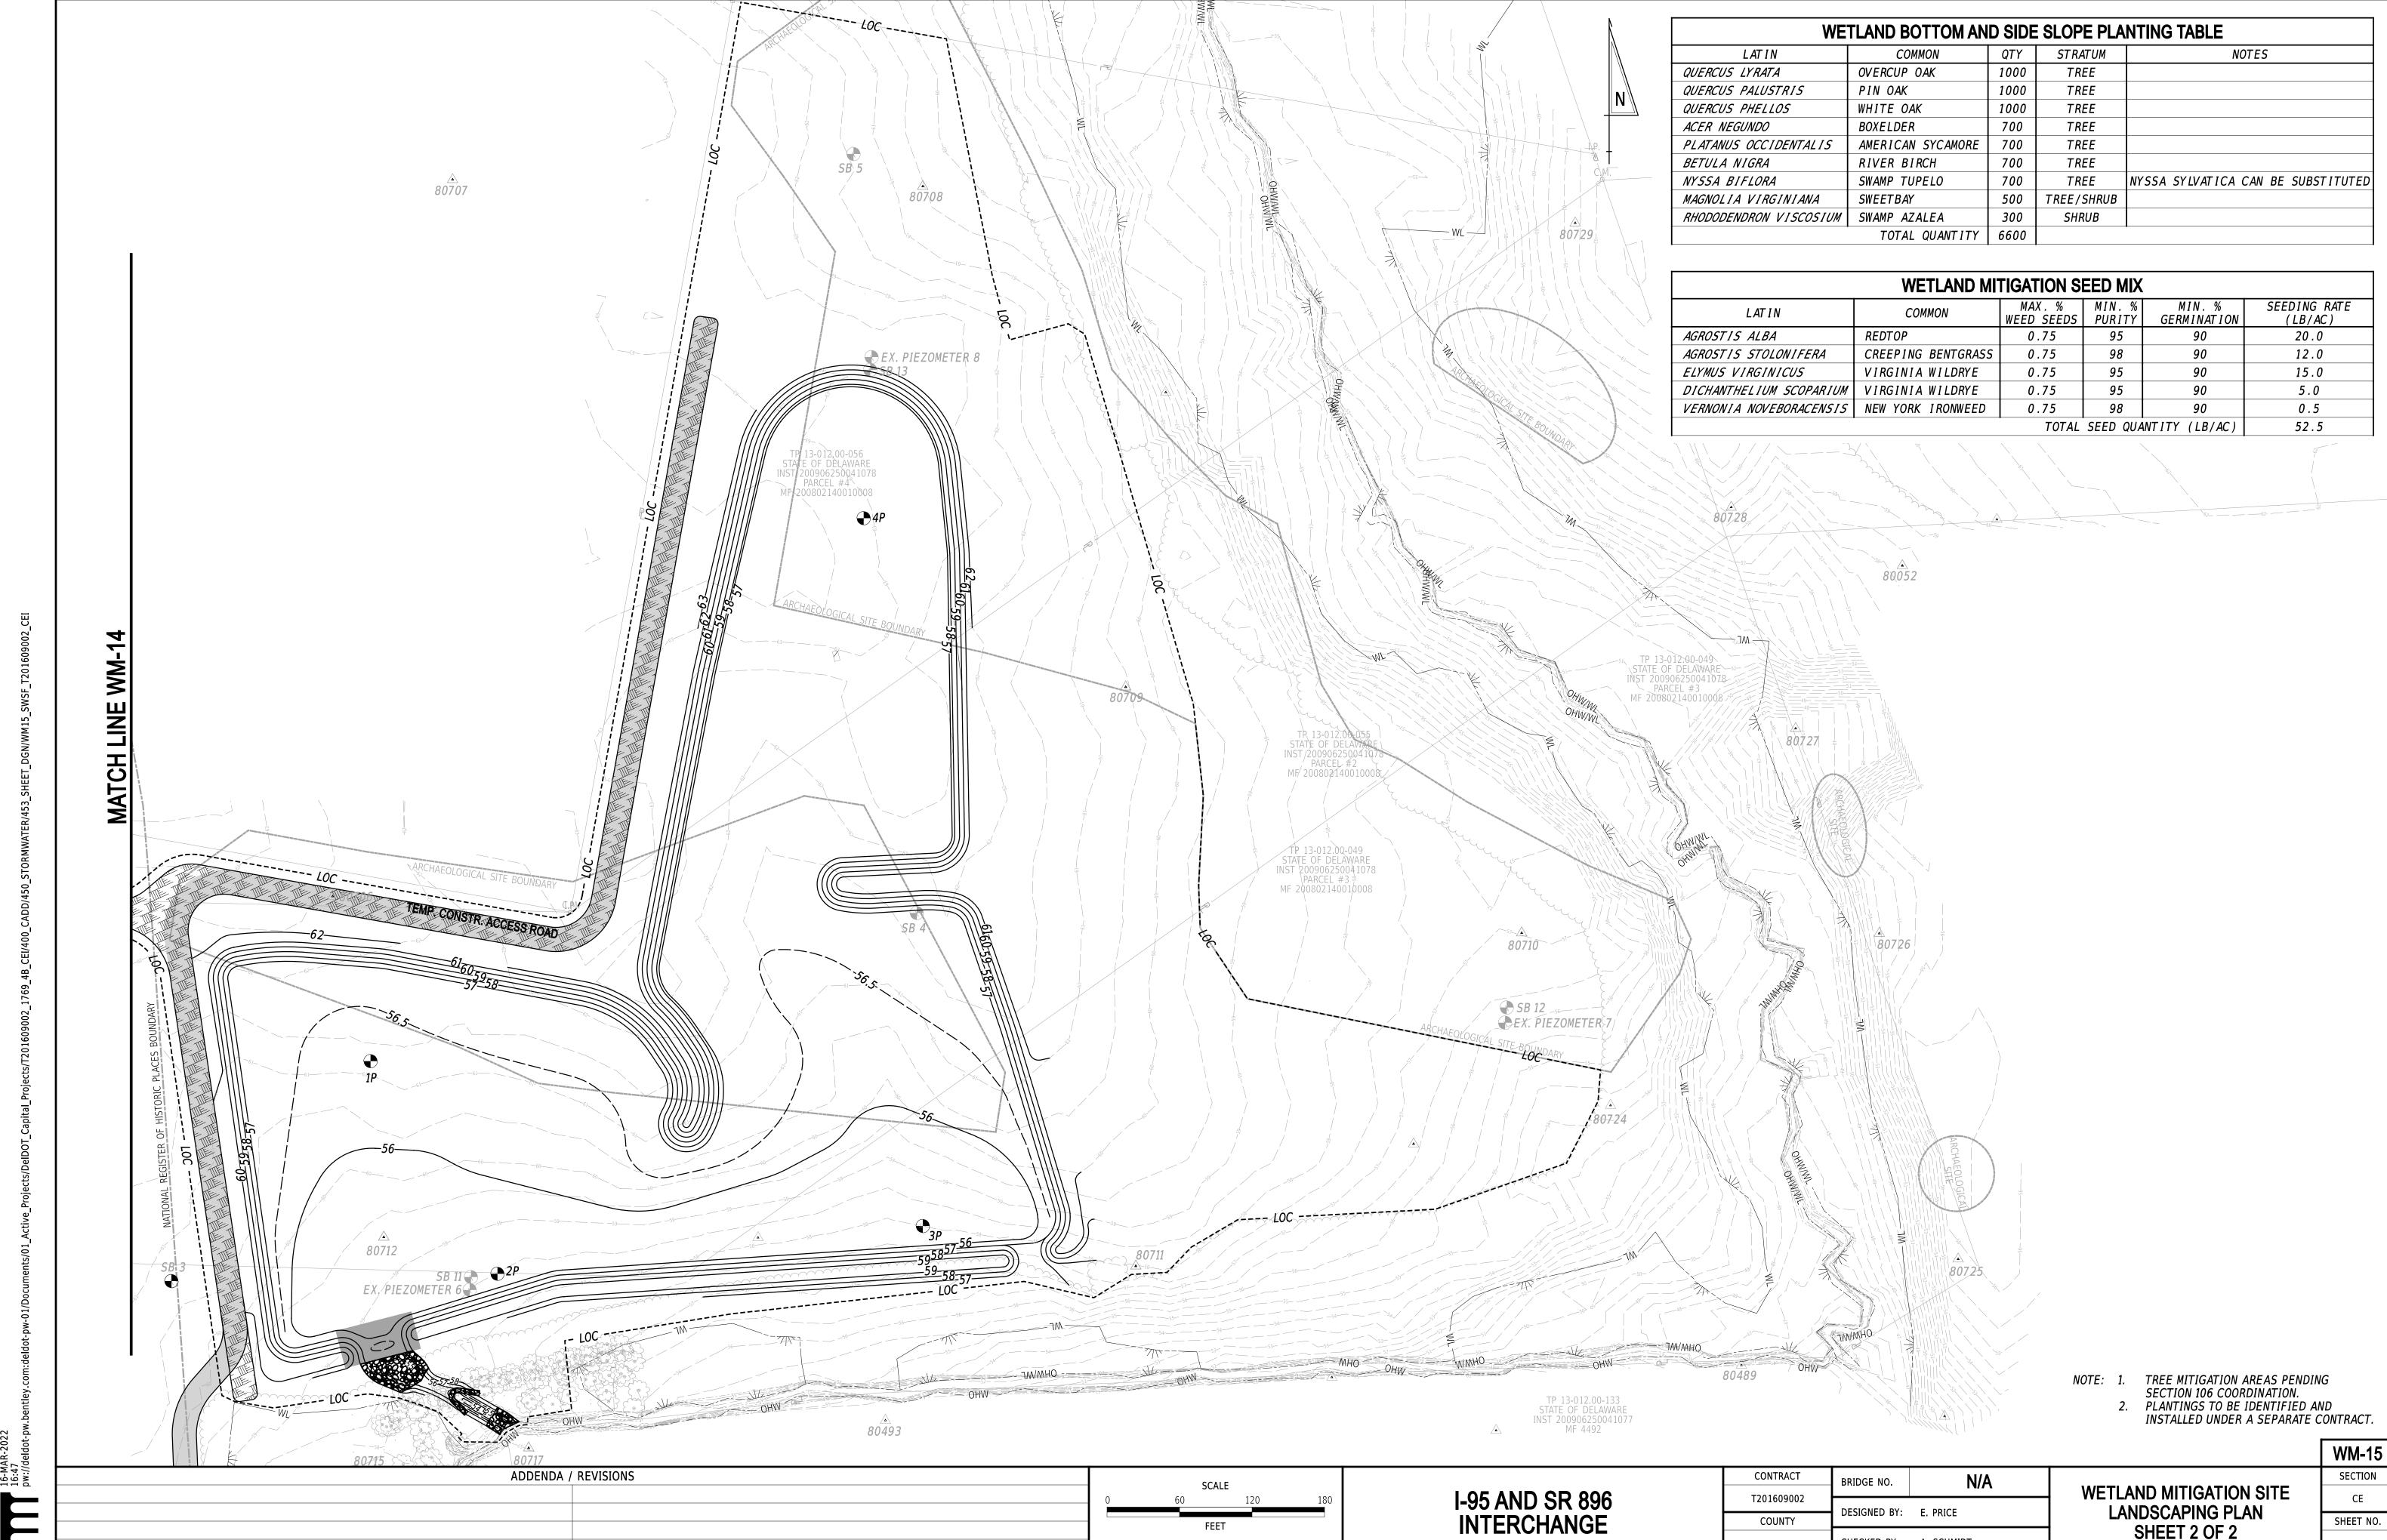
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PLAN SHEET 2 OF 2

1495






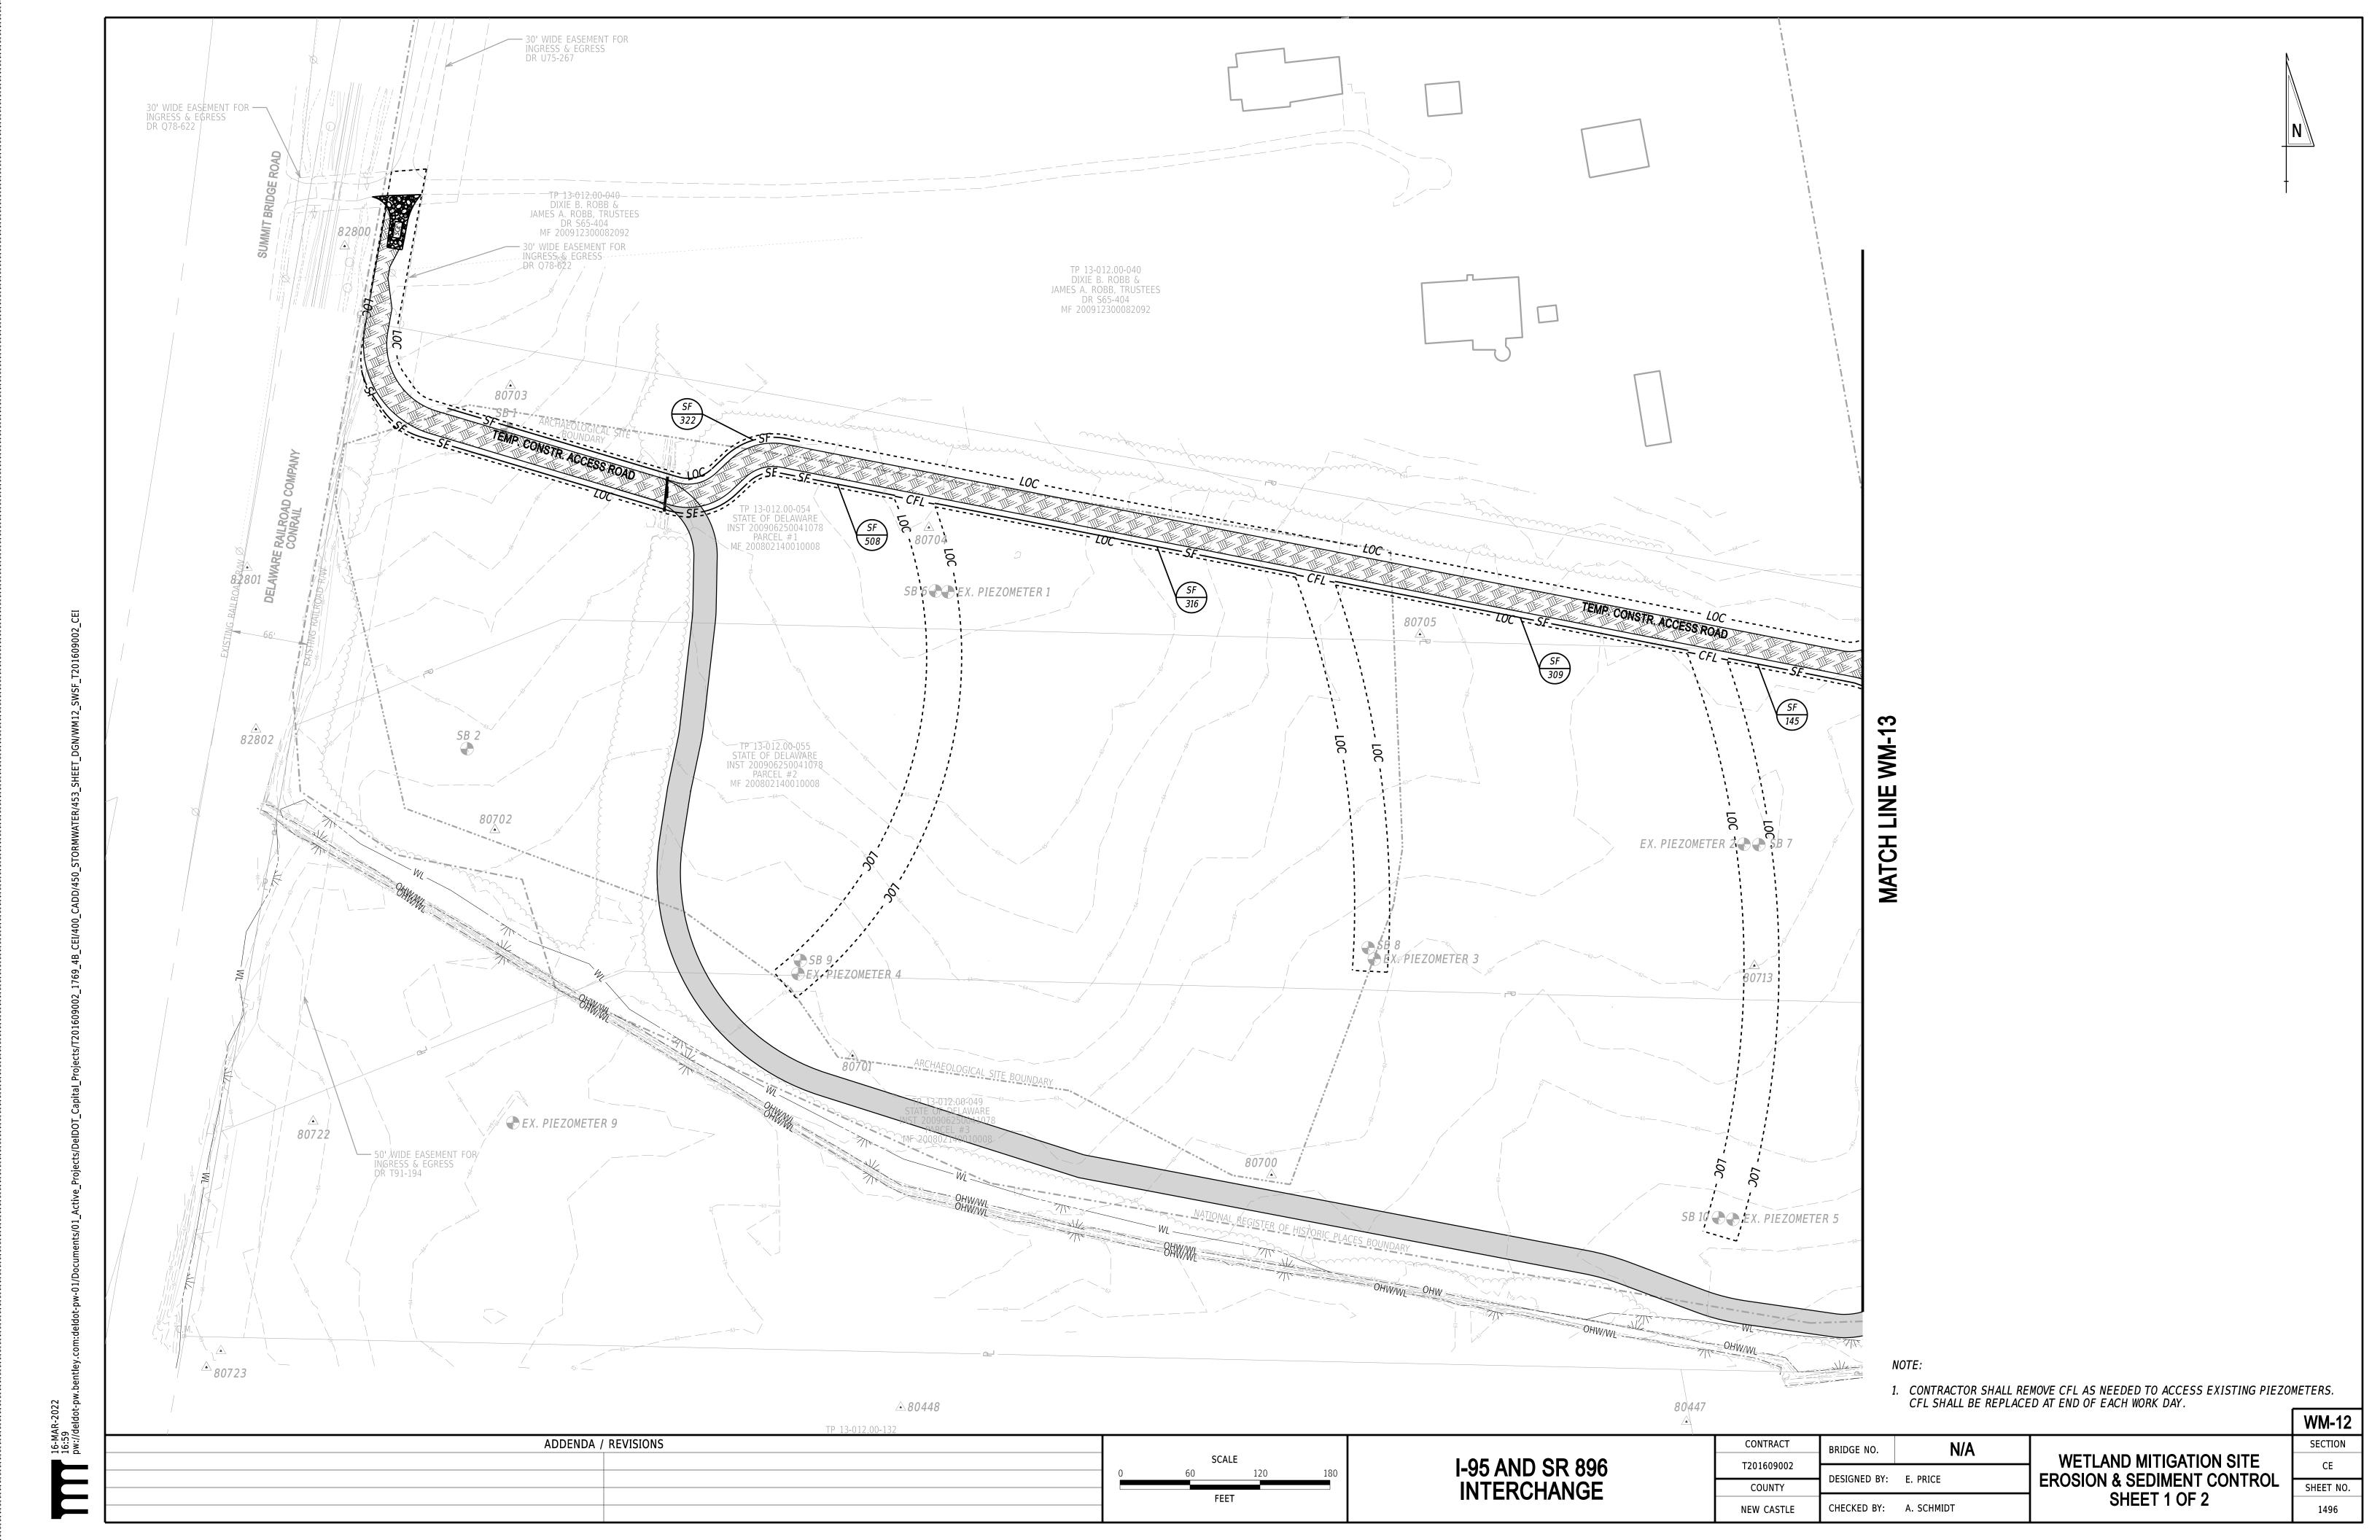
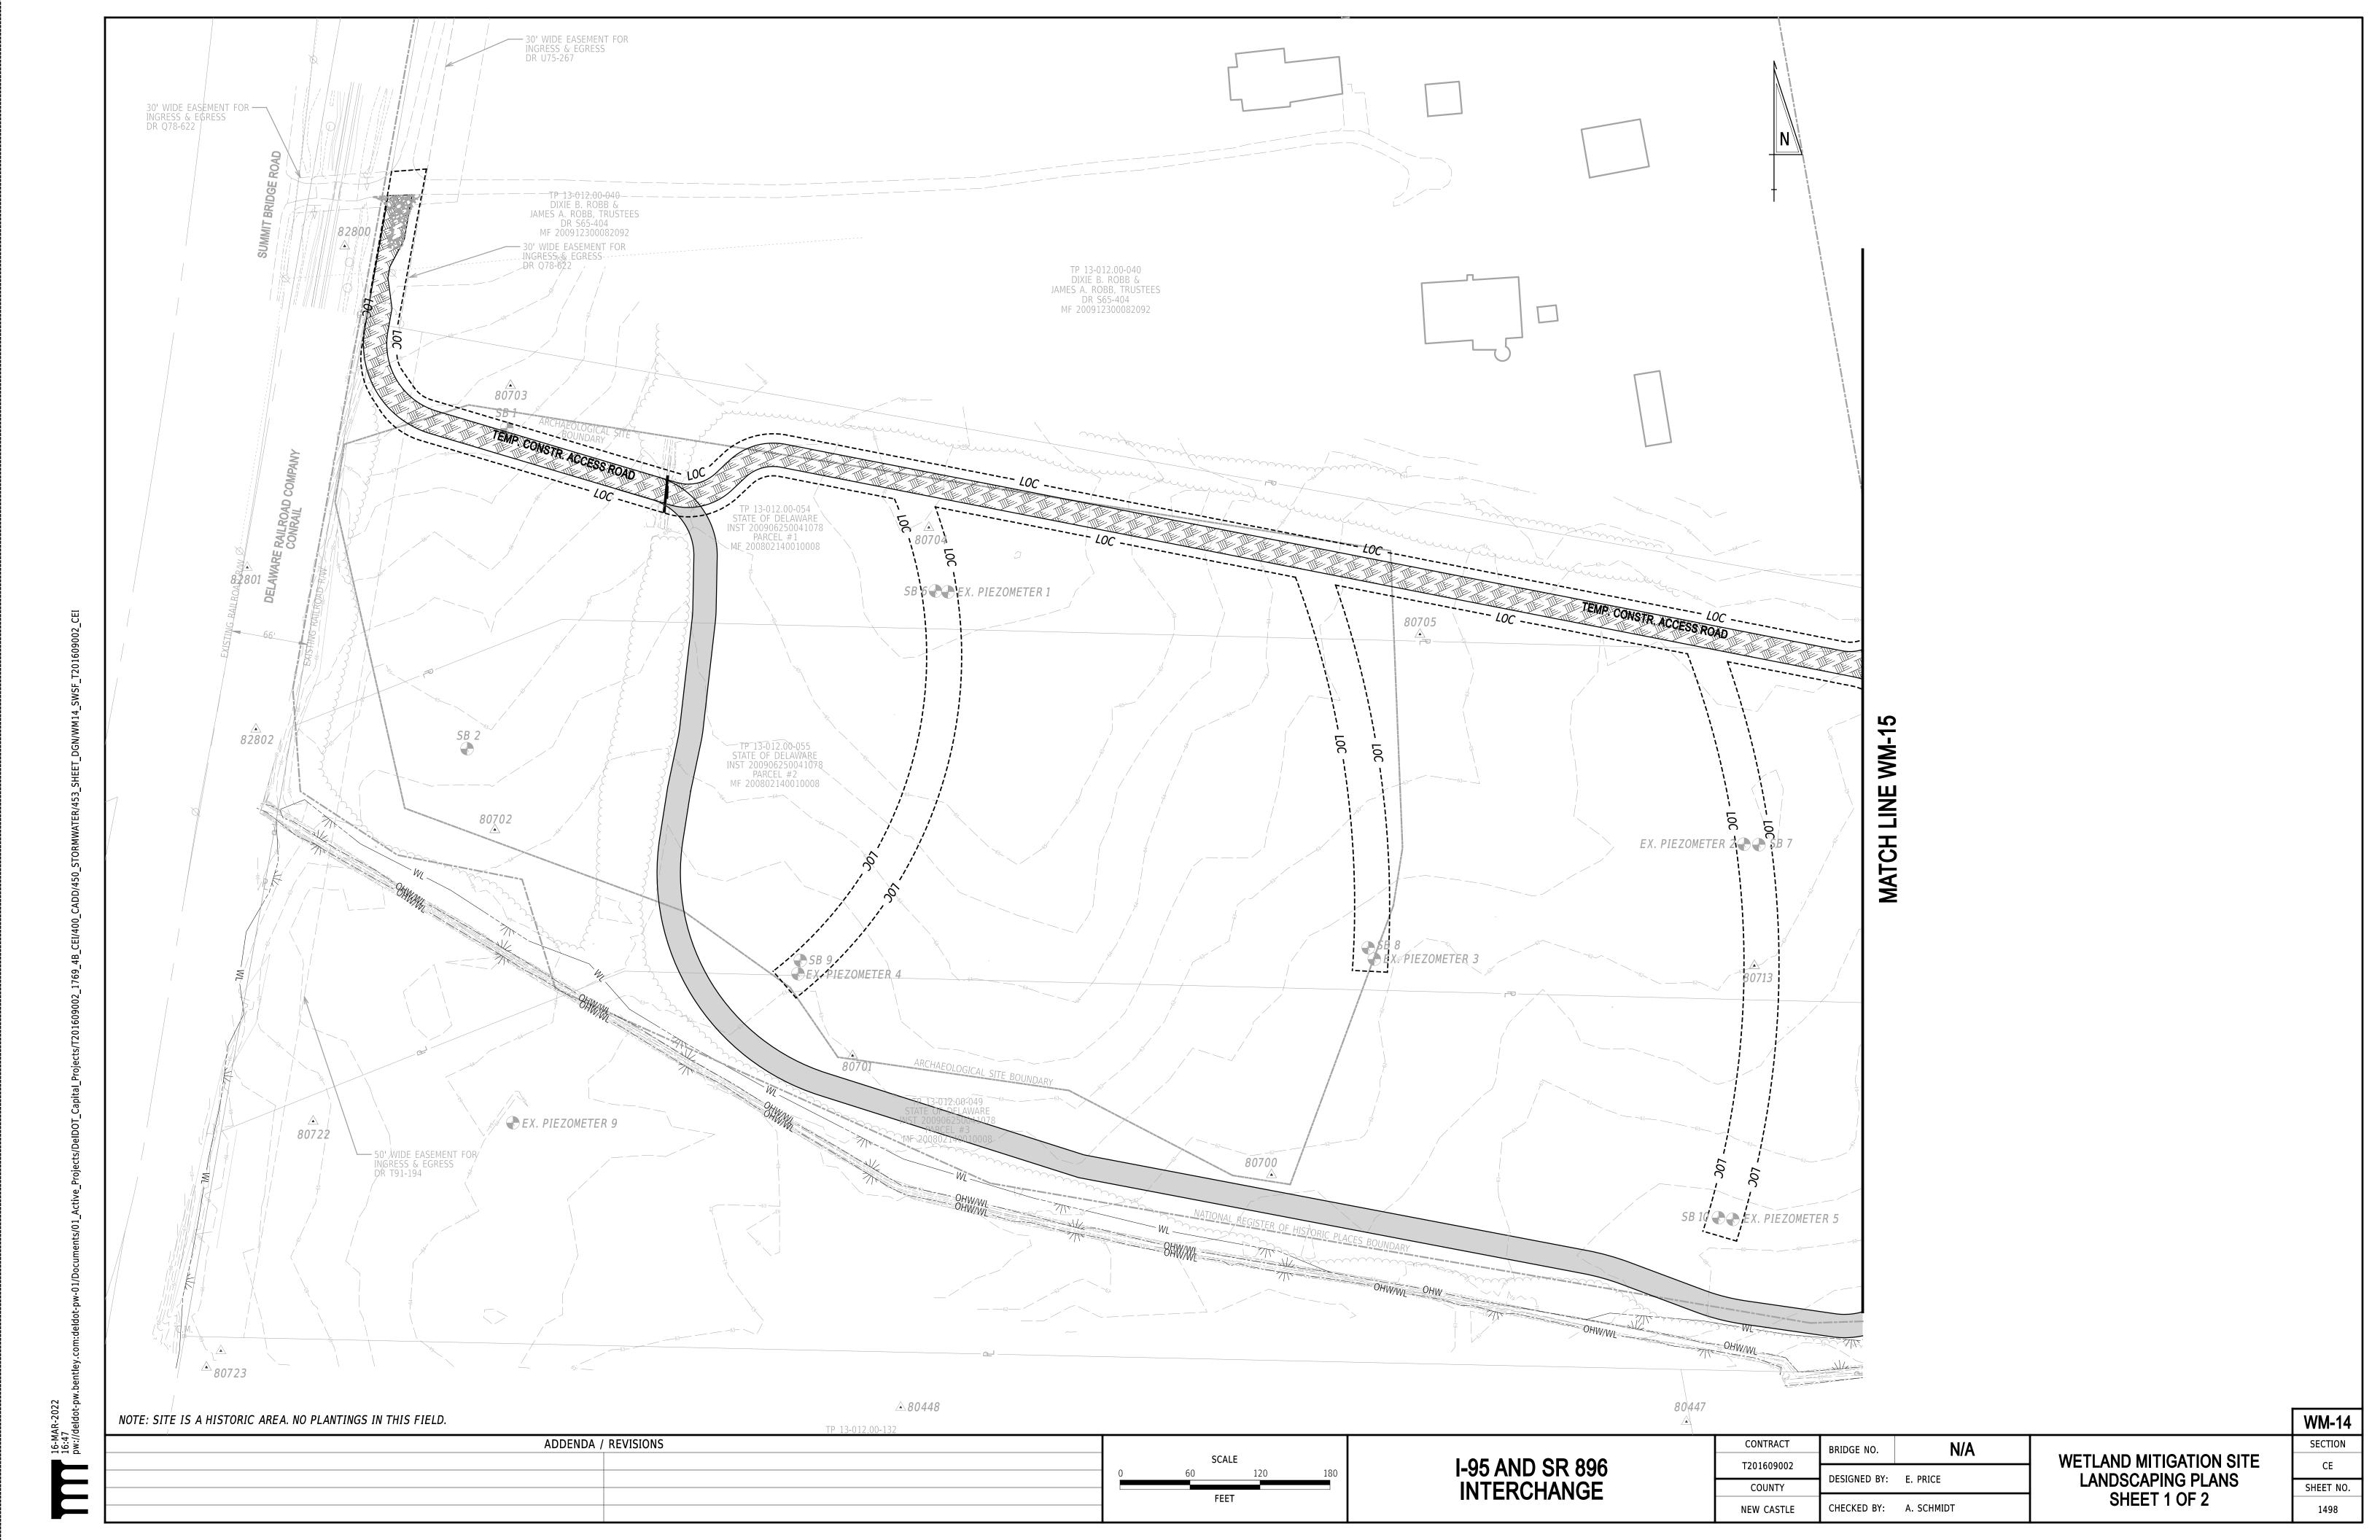
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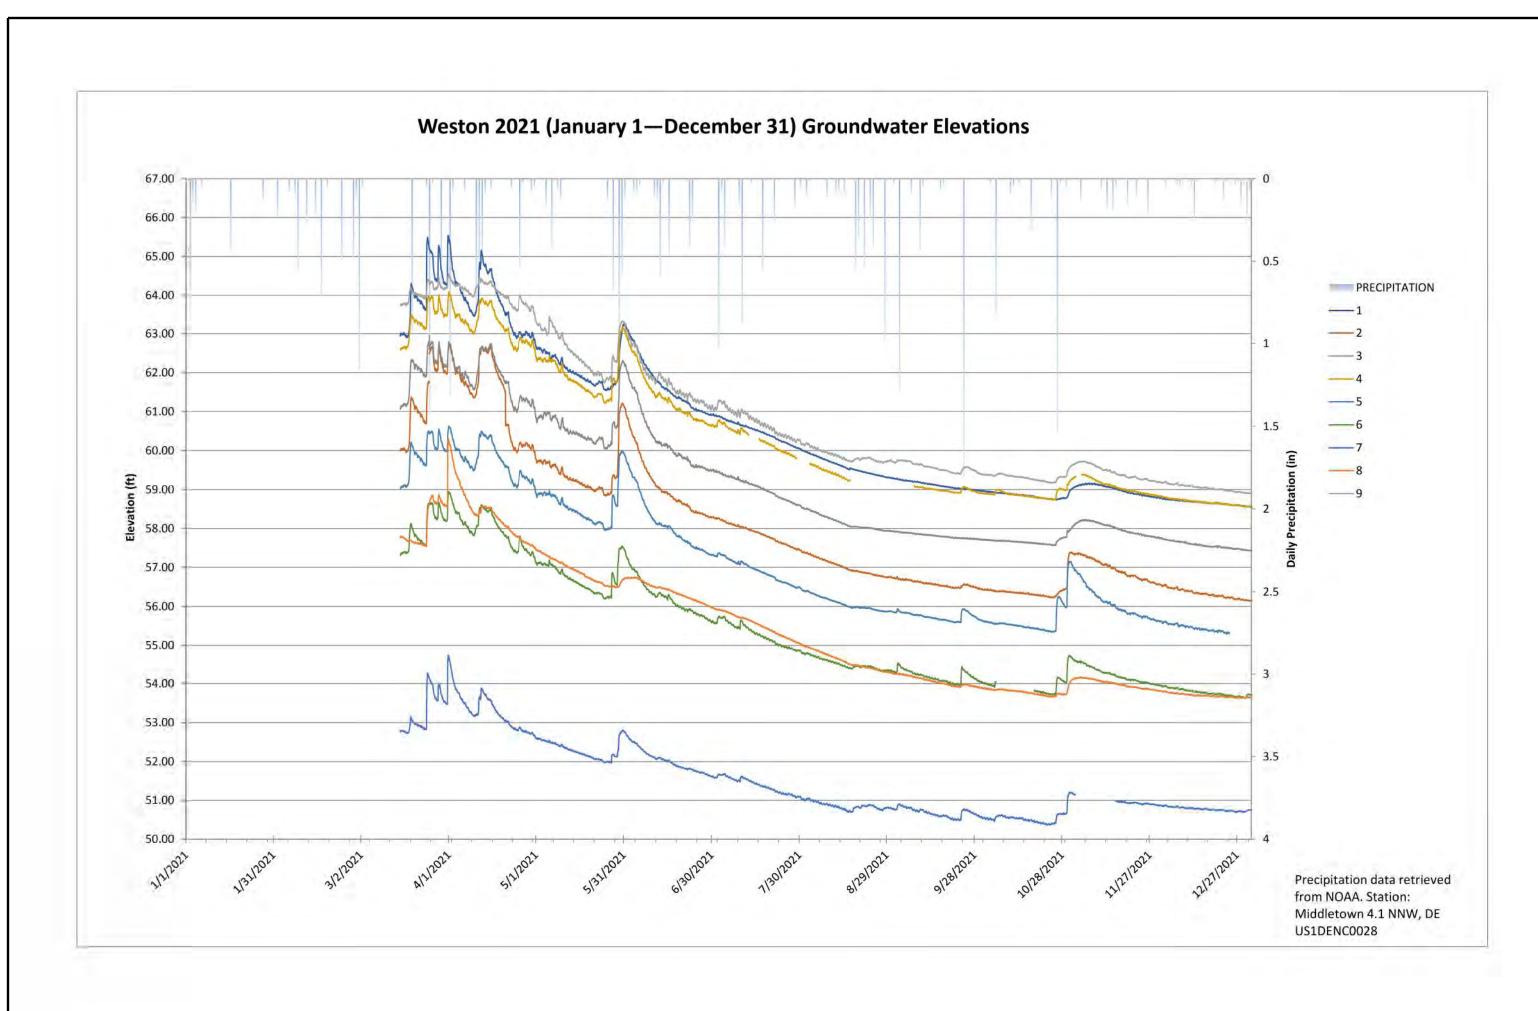
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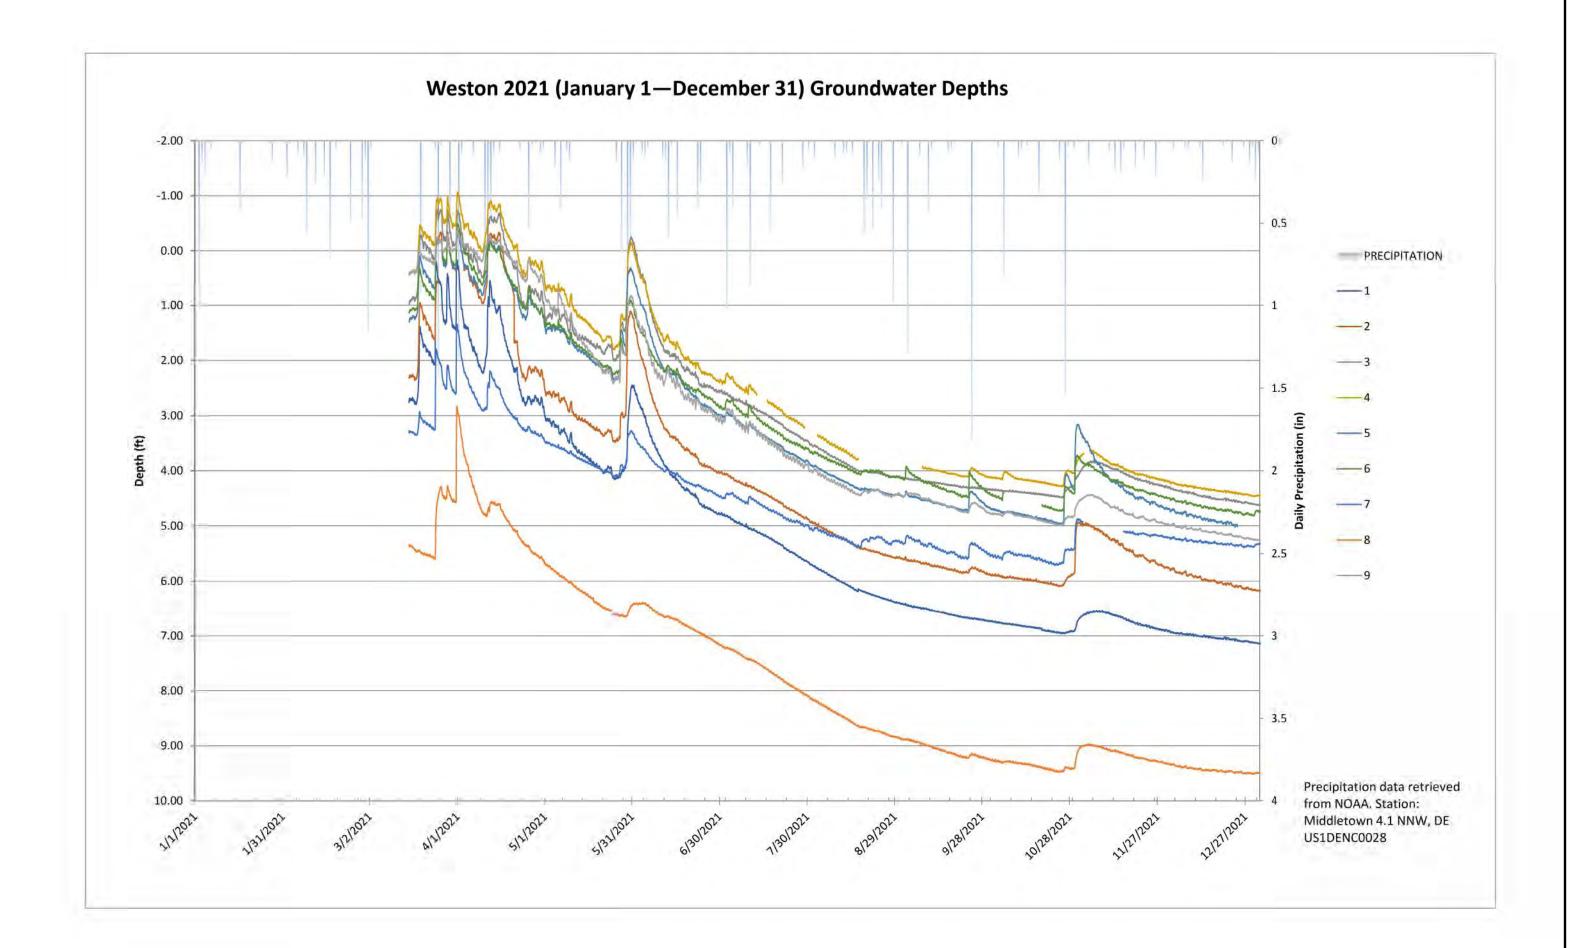
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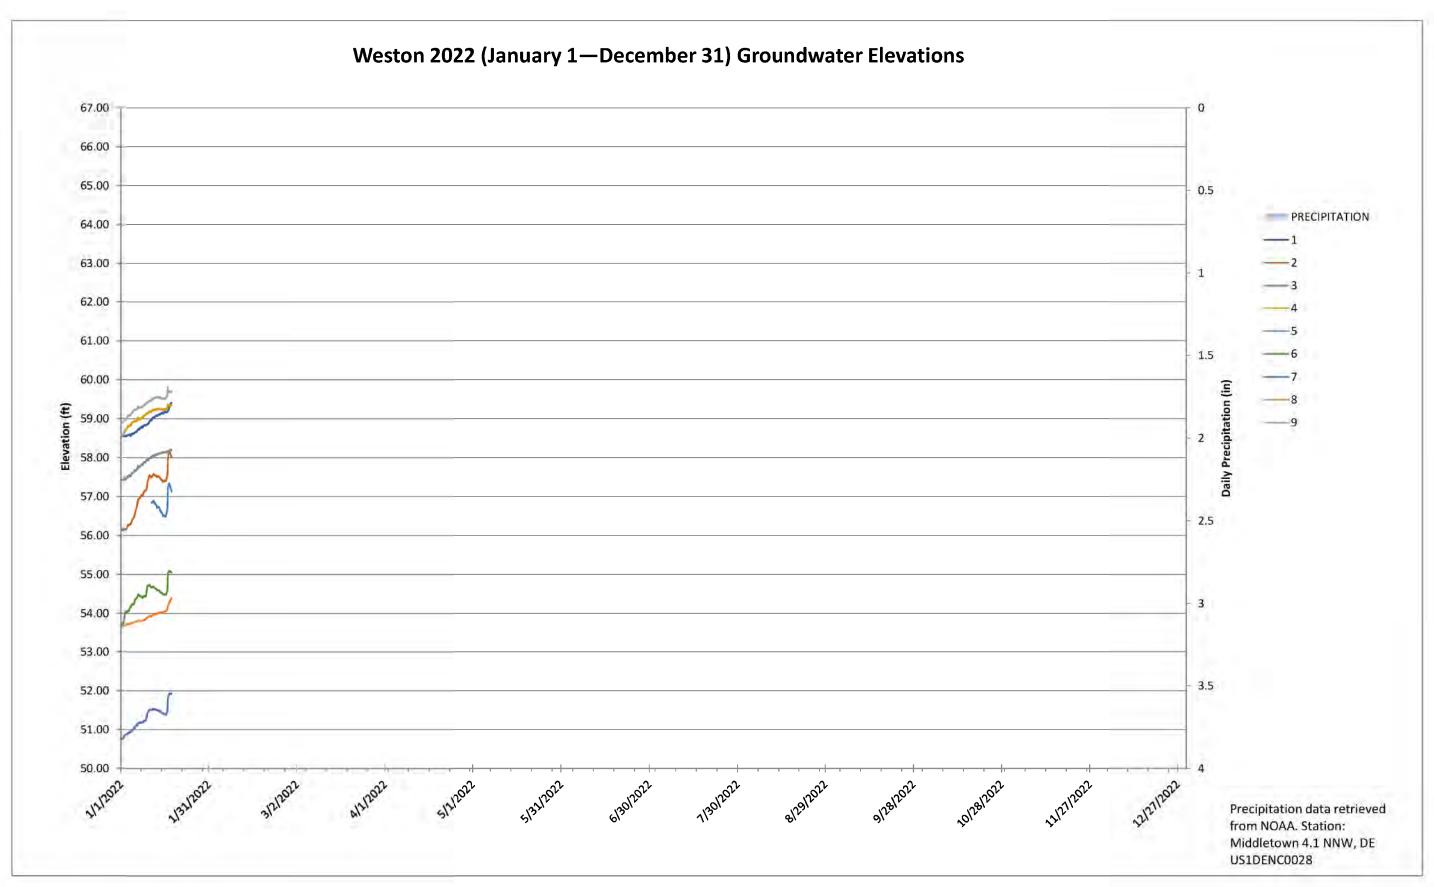



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ADDENDA / REVISIONS


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CONTRACT N/A BRIDGE NO. DESIGNED BY: E. PRICE COUNTY CHECKED BY: A. SCHMIDT NEW CASTLE

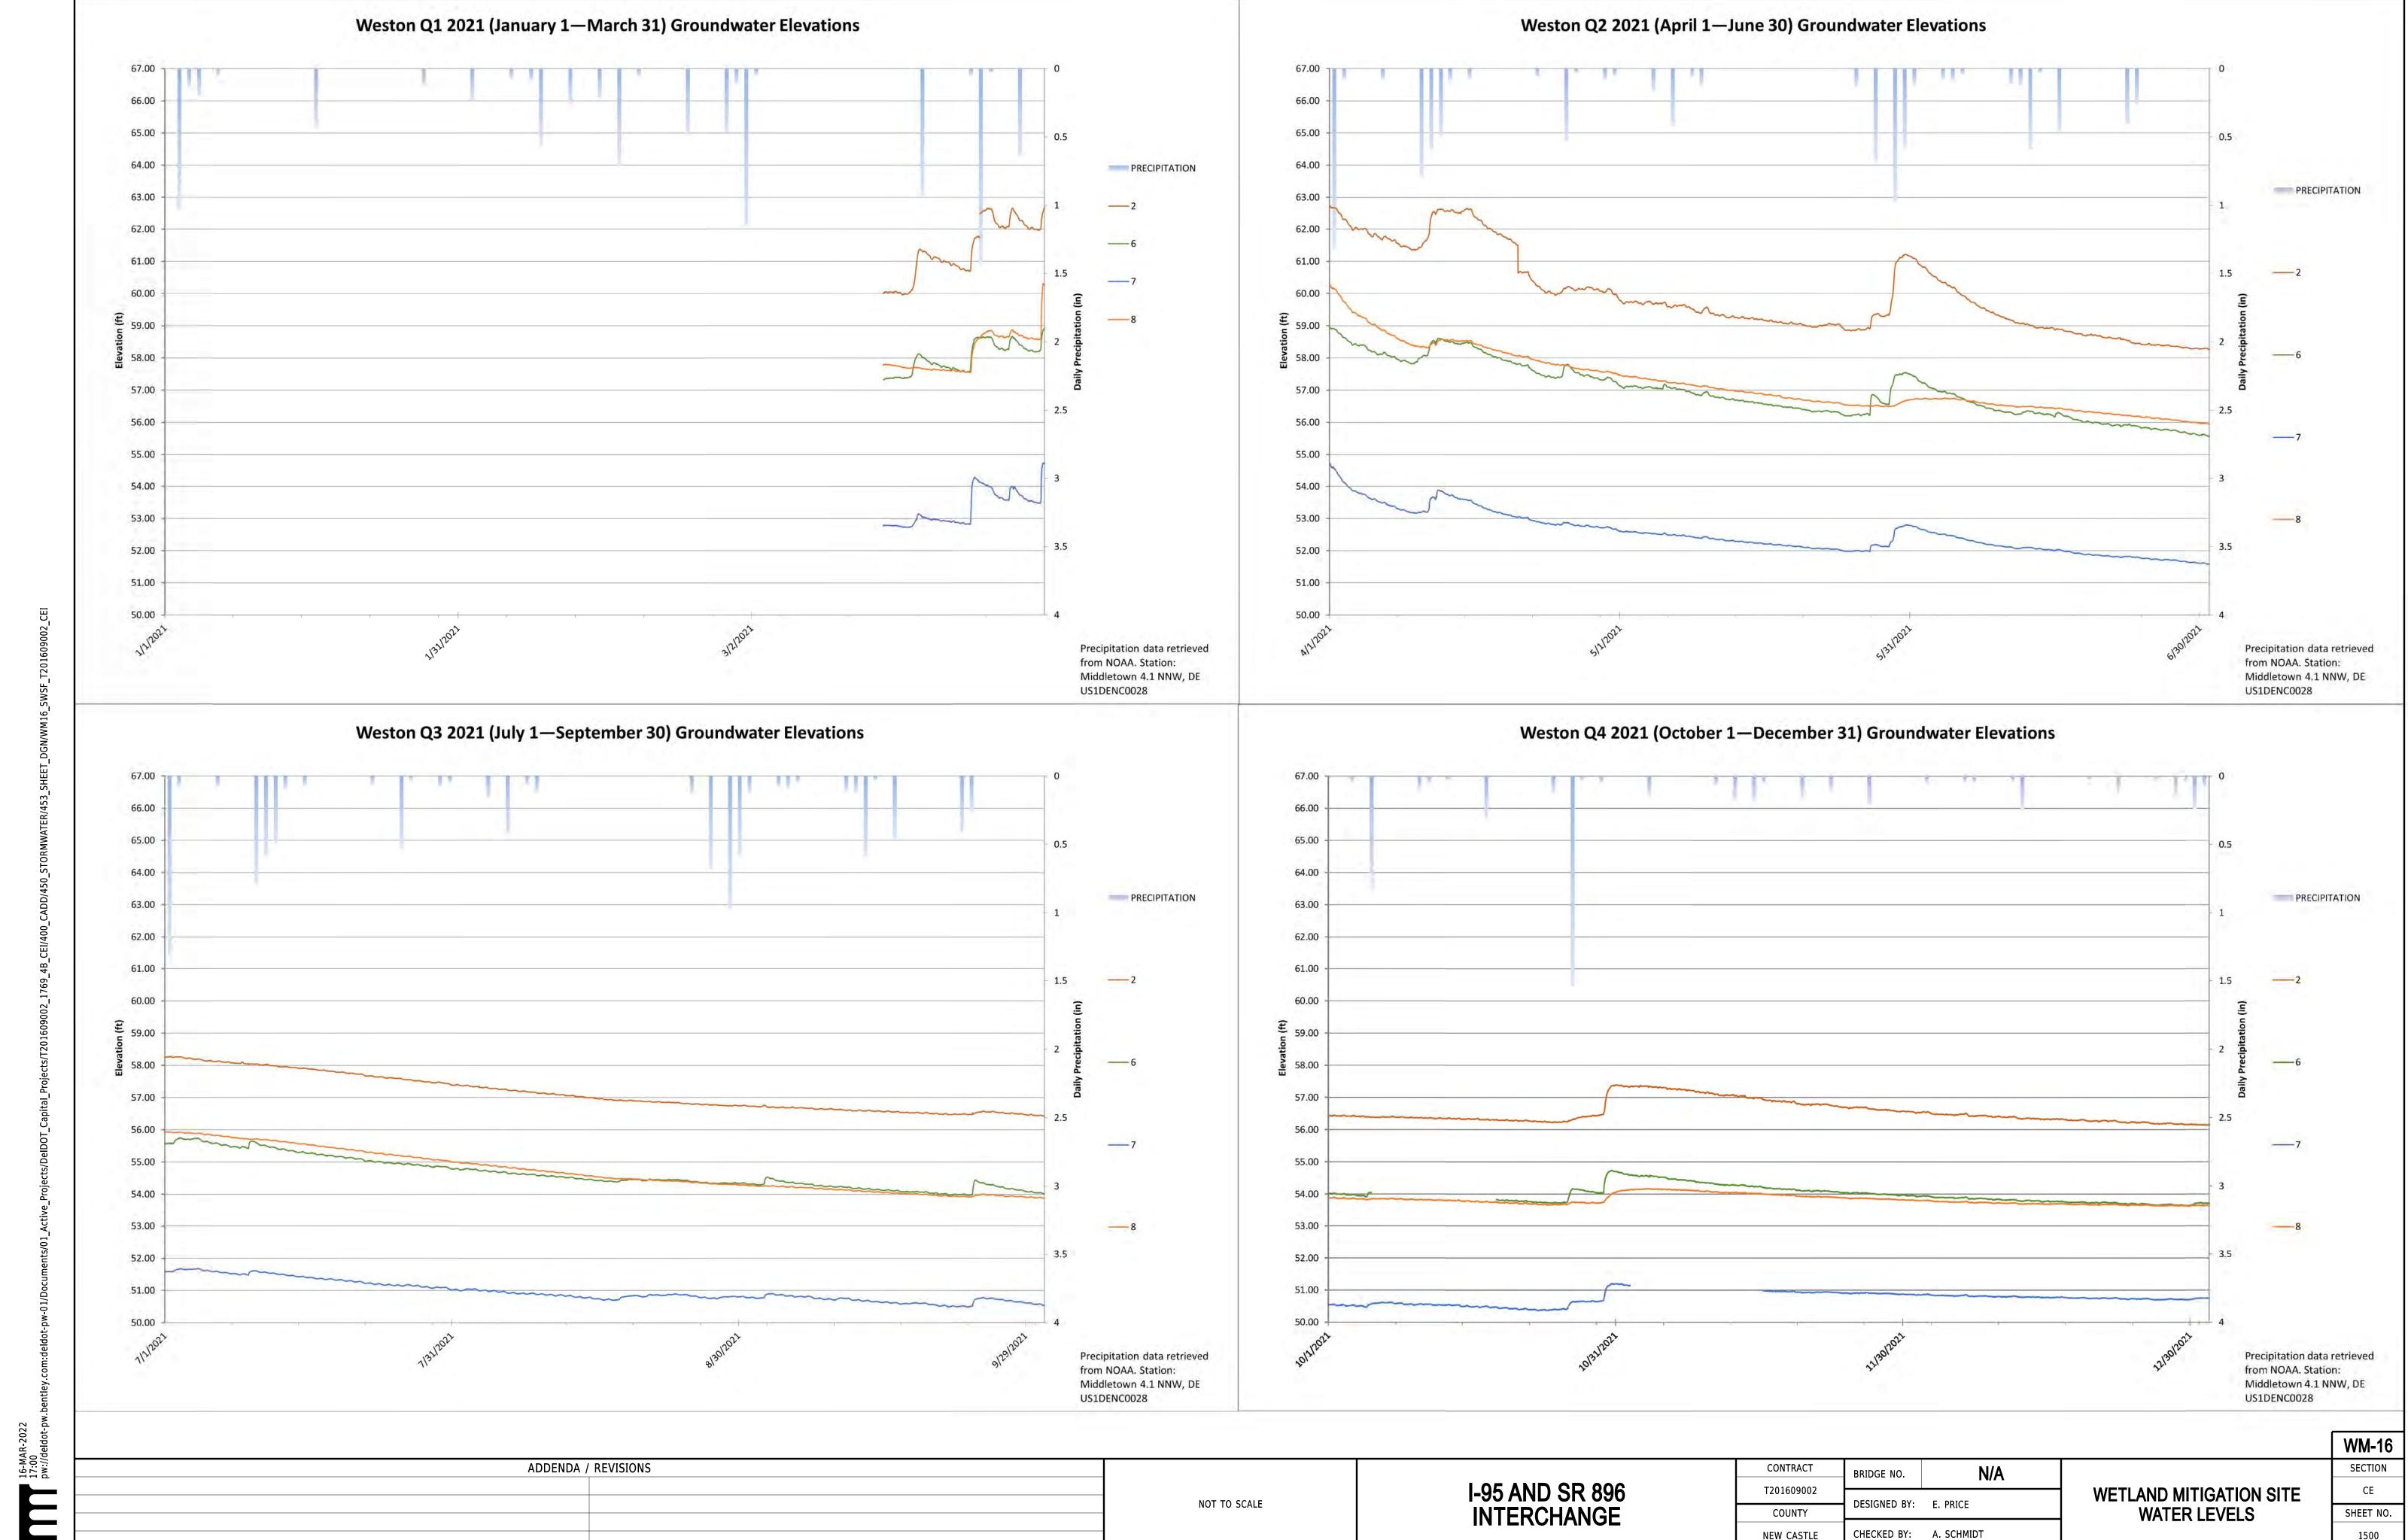SECTION WETLAND MITIGATION SITE CE WATER LEVELS SHEET NO. 1501

WM-17

T201609002

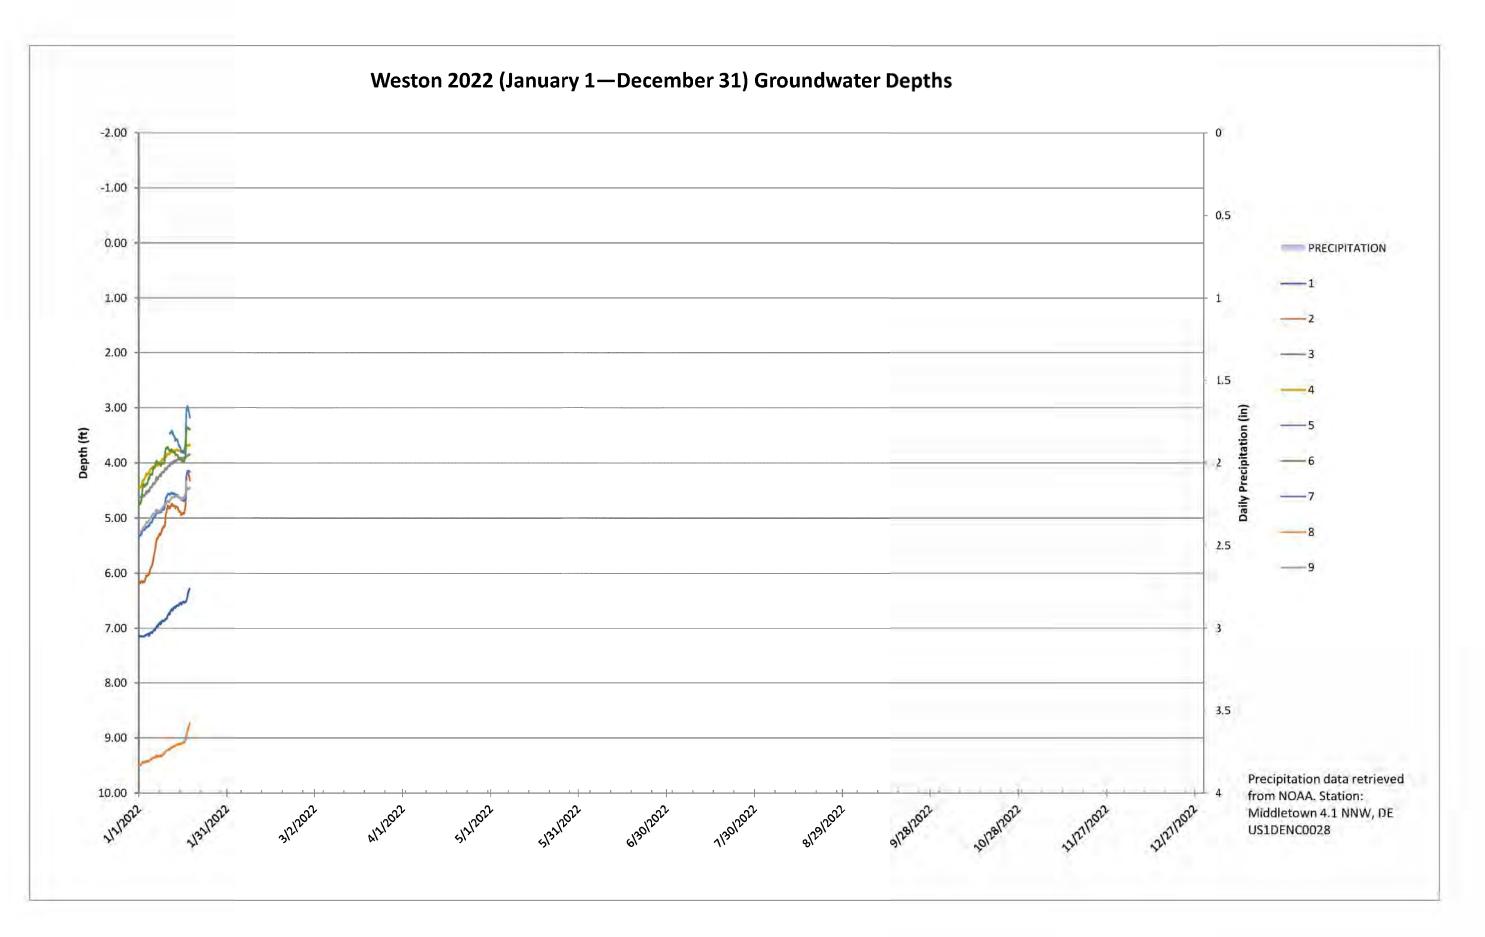

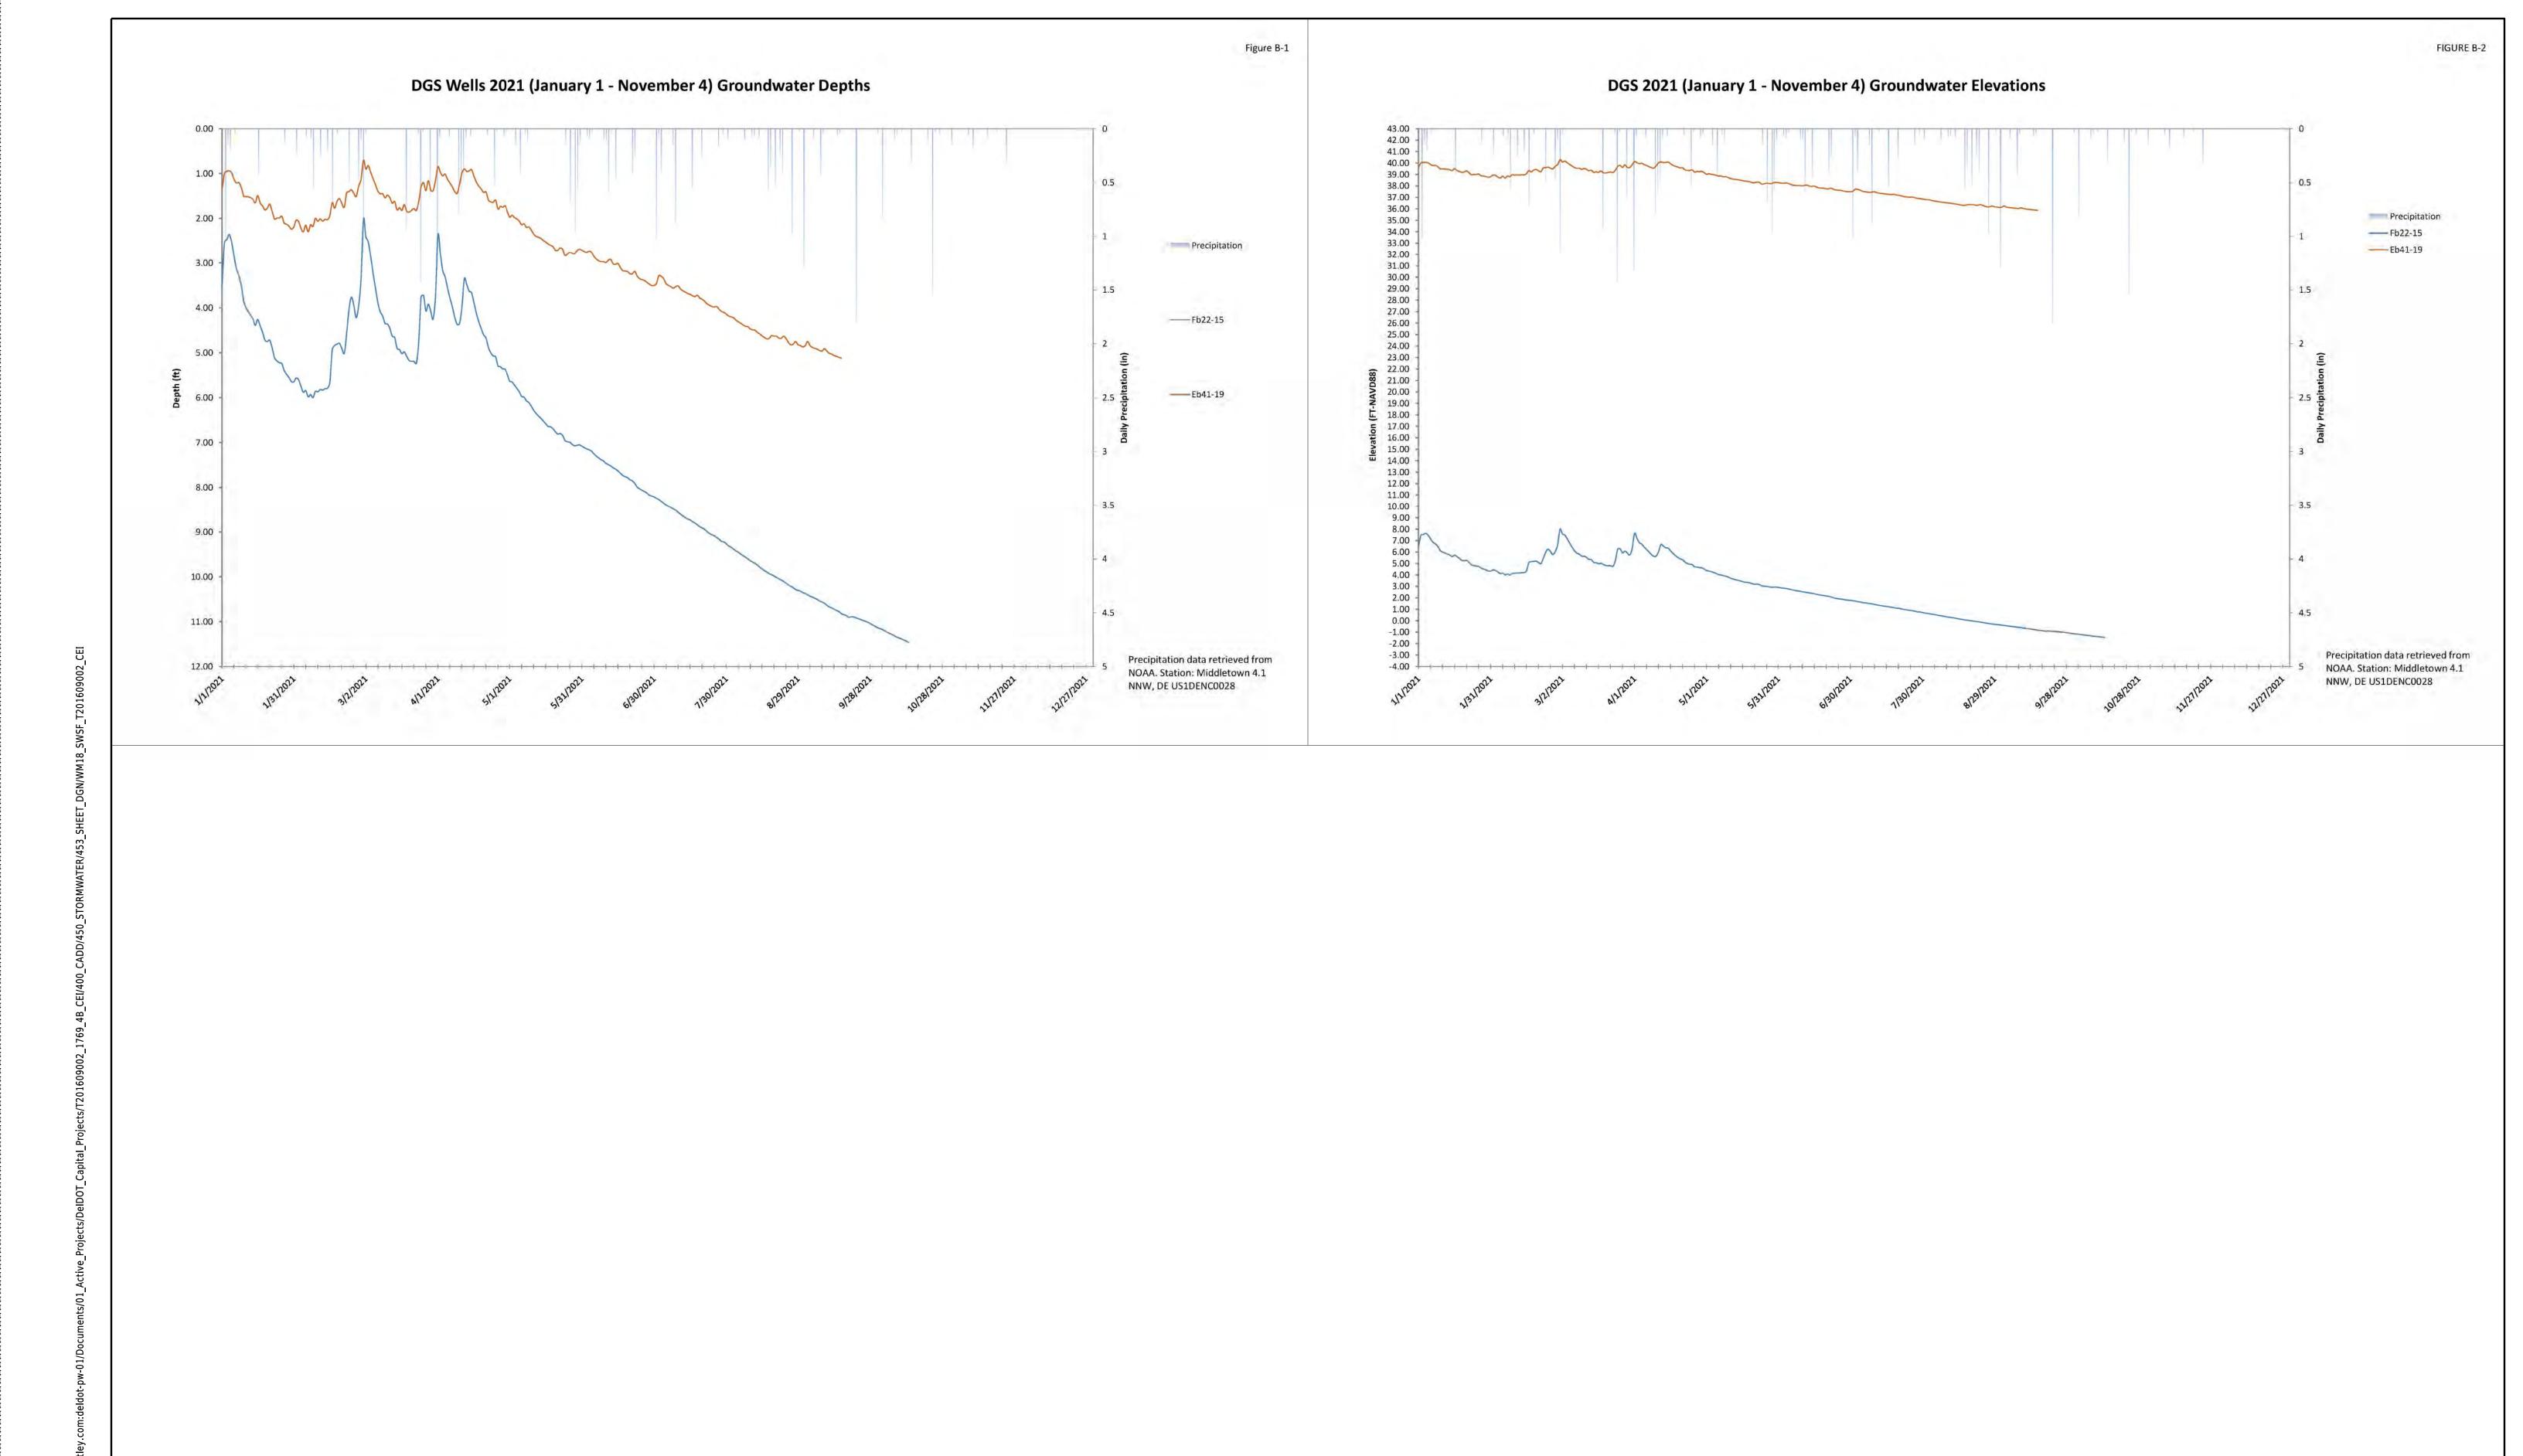16-MAR-2022 17:03 pw://deldot-pw.beni

ADDENDA / REVISIONS

I-95 AND SR 896 INTERCHANGE CONTRACT
BRIDGE NO.

T201609002

COUNTY

DESIGNED BY: E. PRICE


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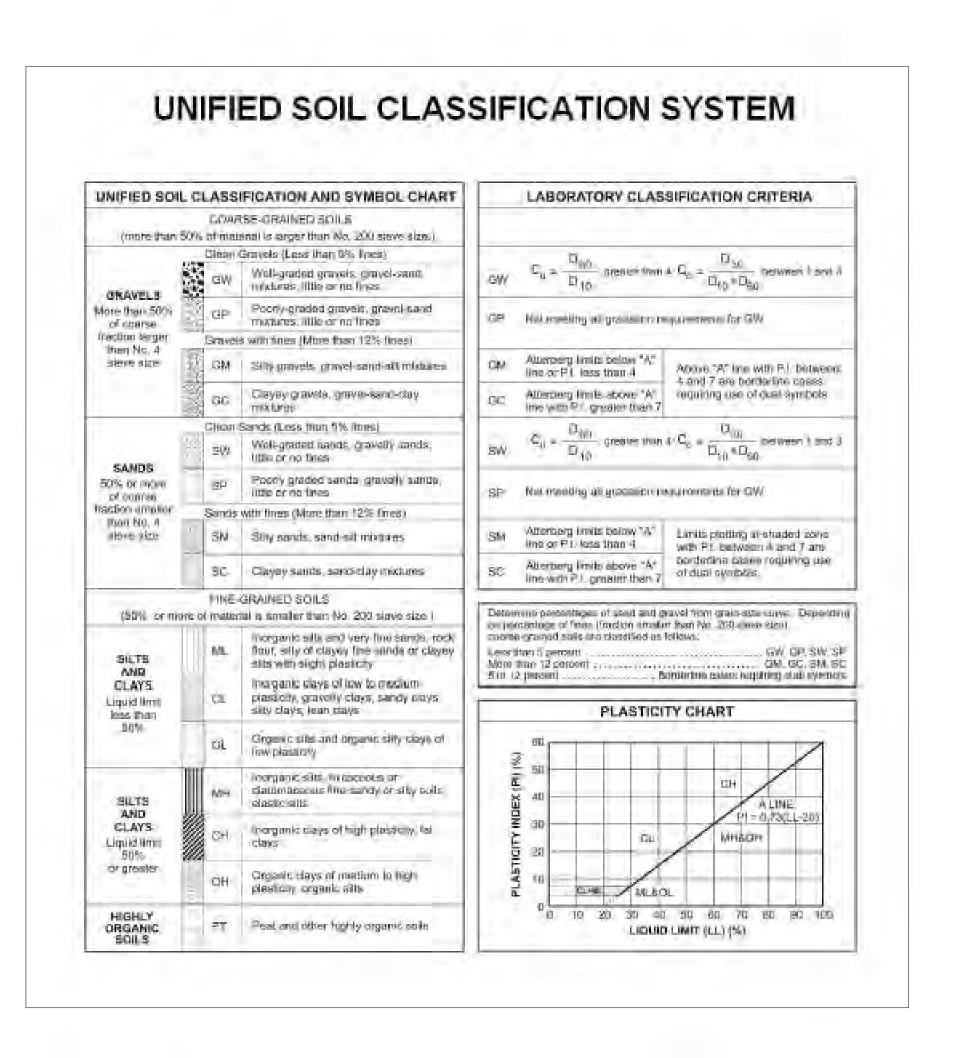
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WETLAND MITIGATION SITE
WATER LEVELS


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WM-18







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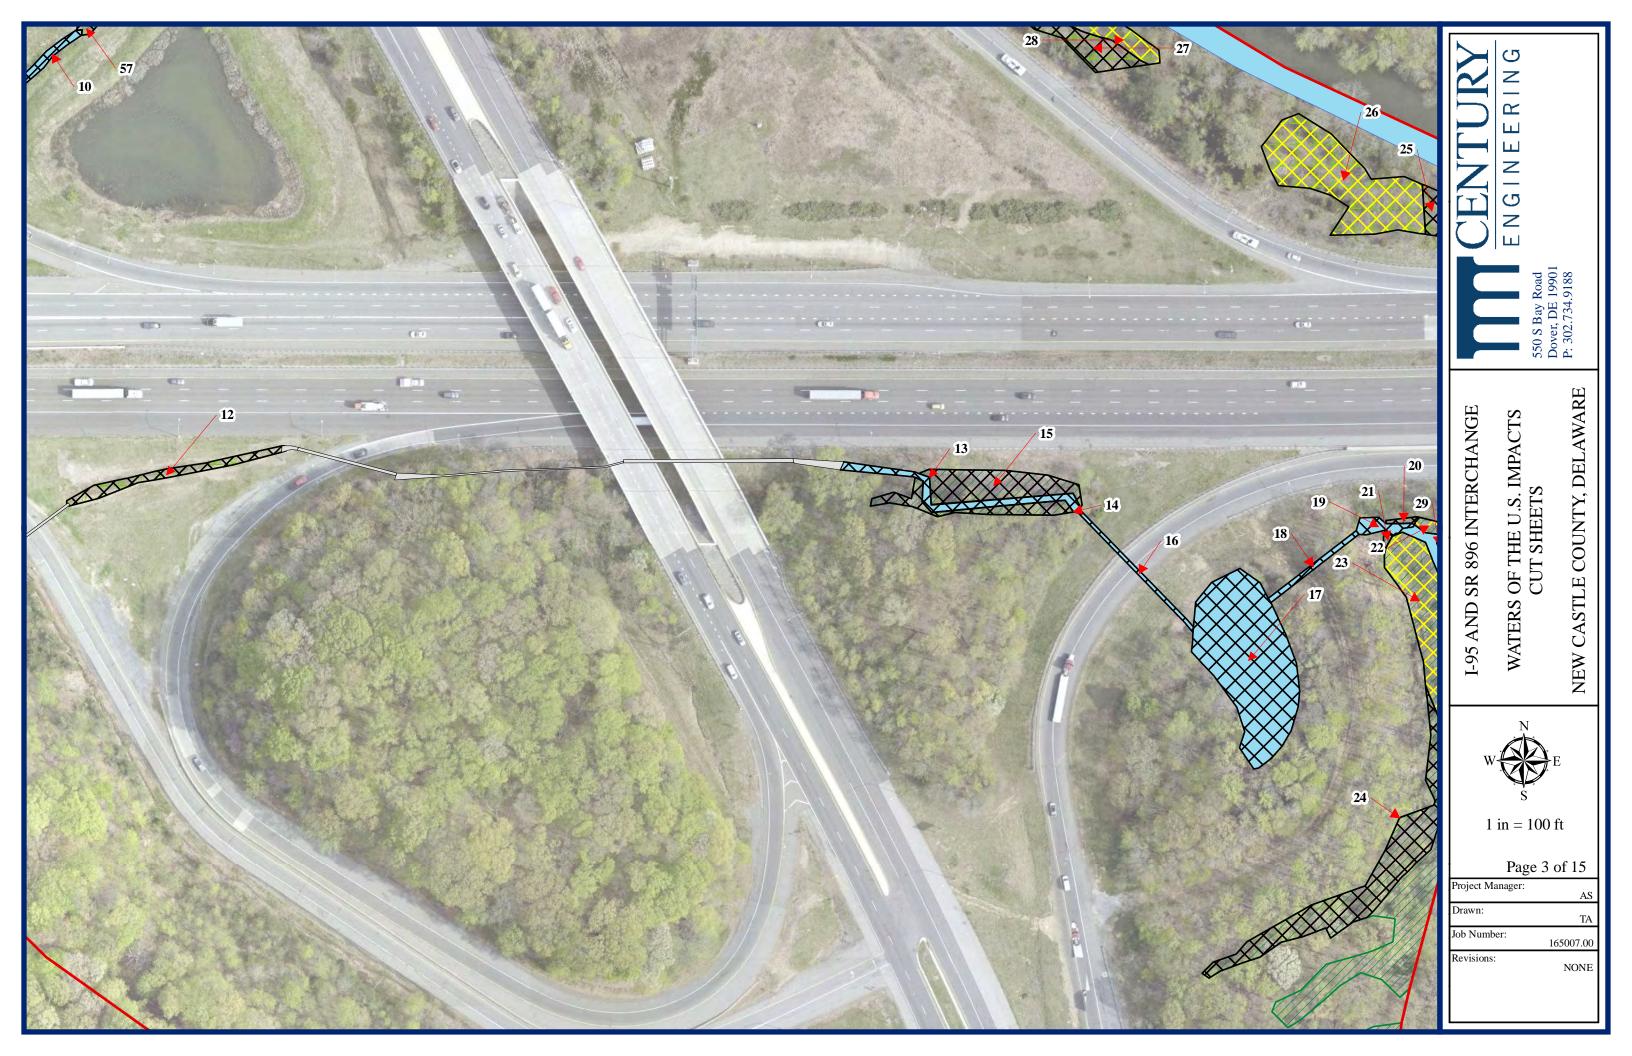


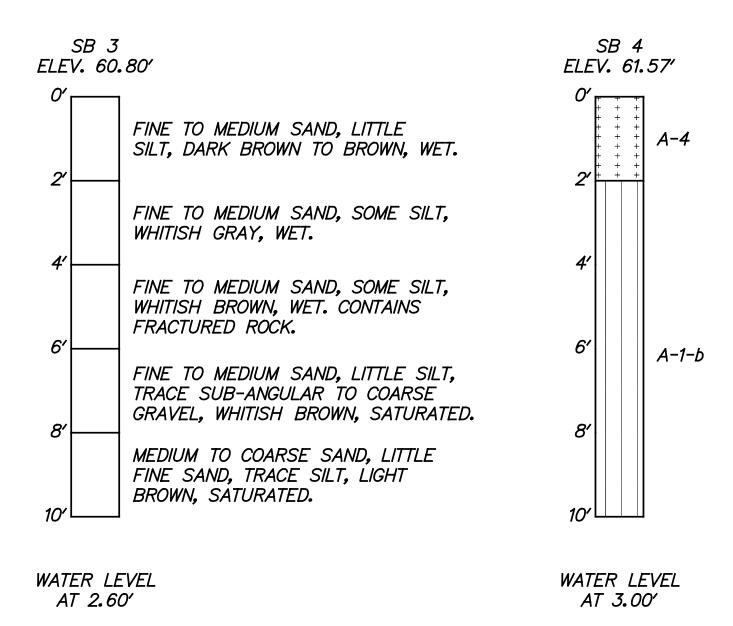
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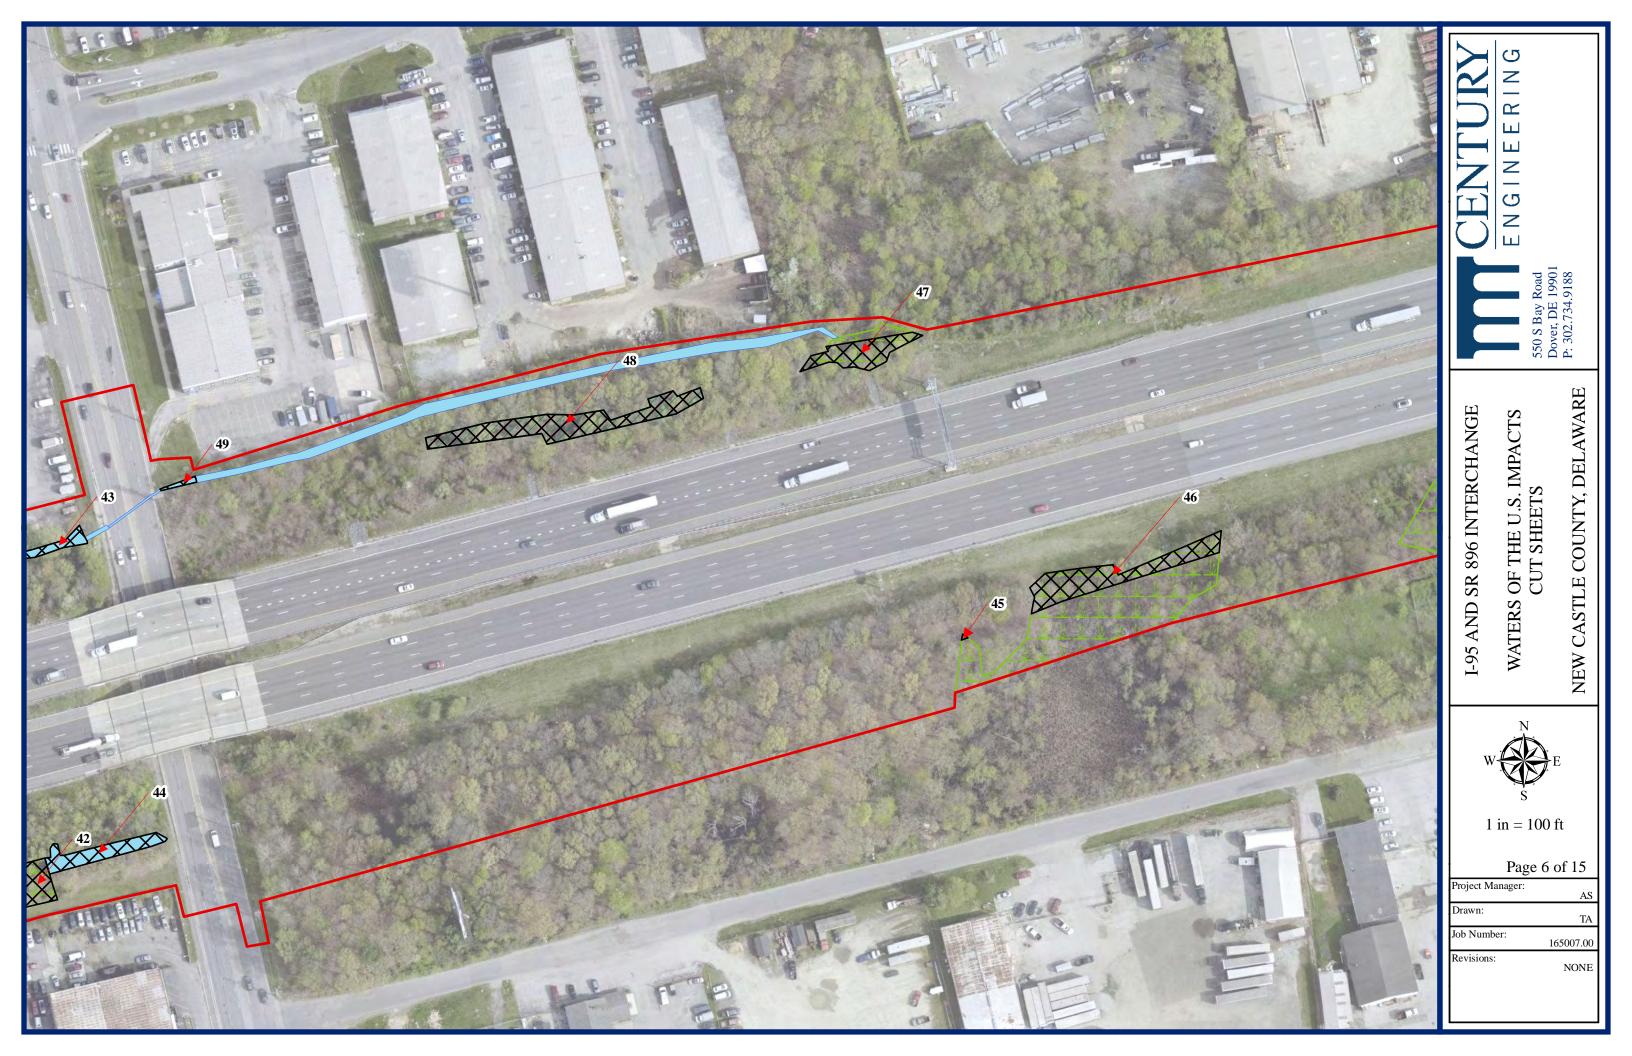


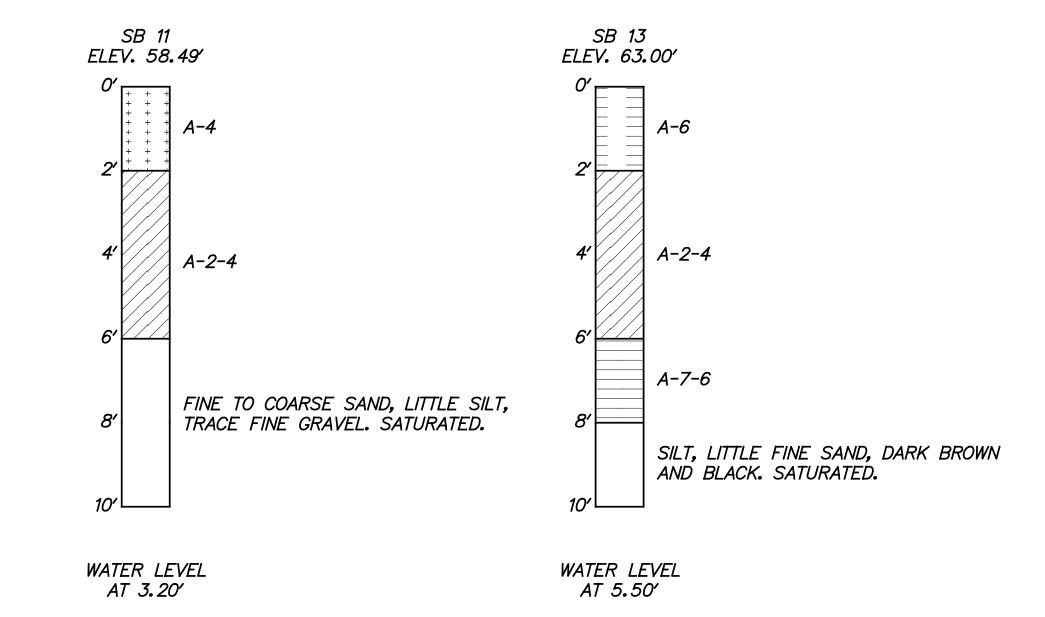


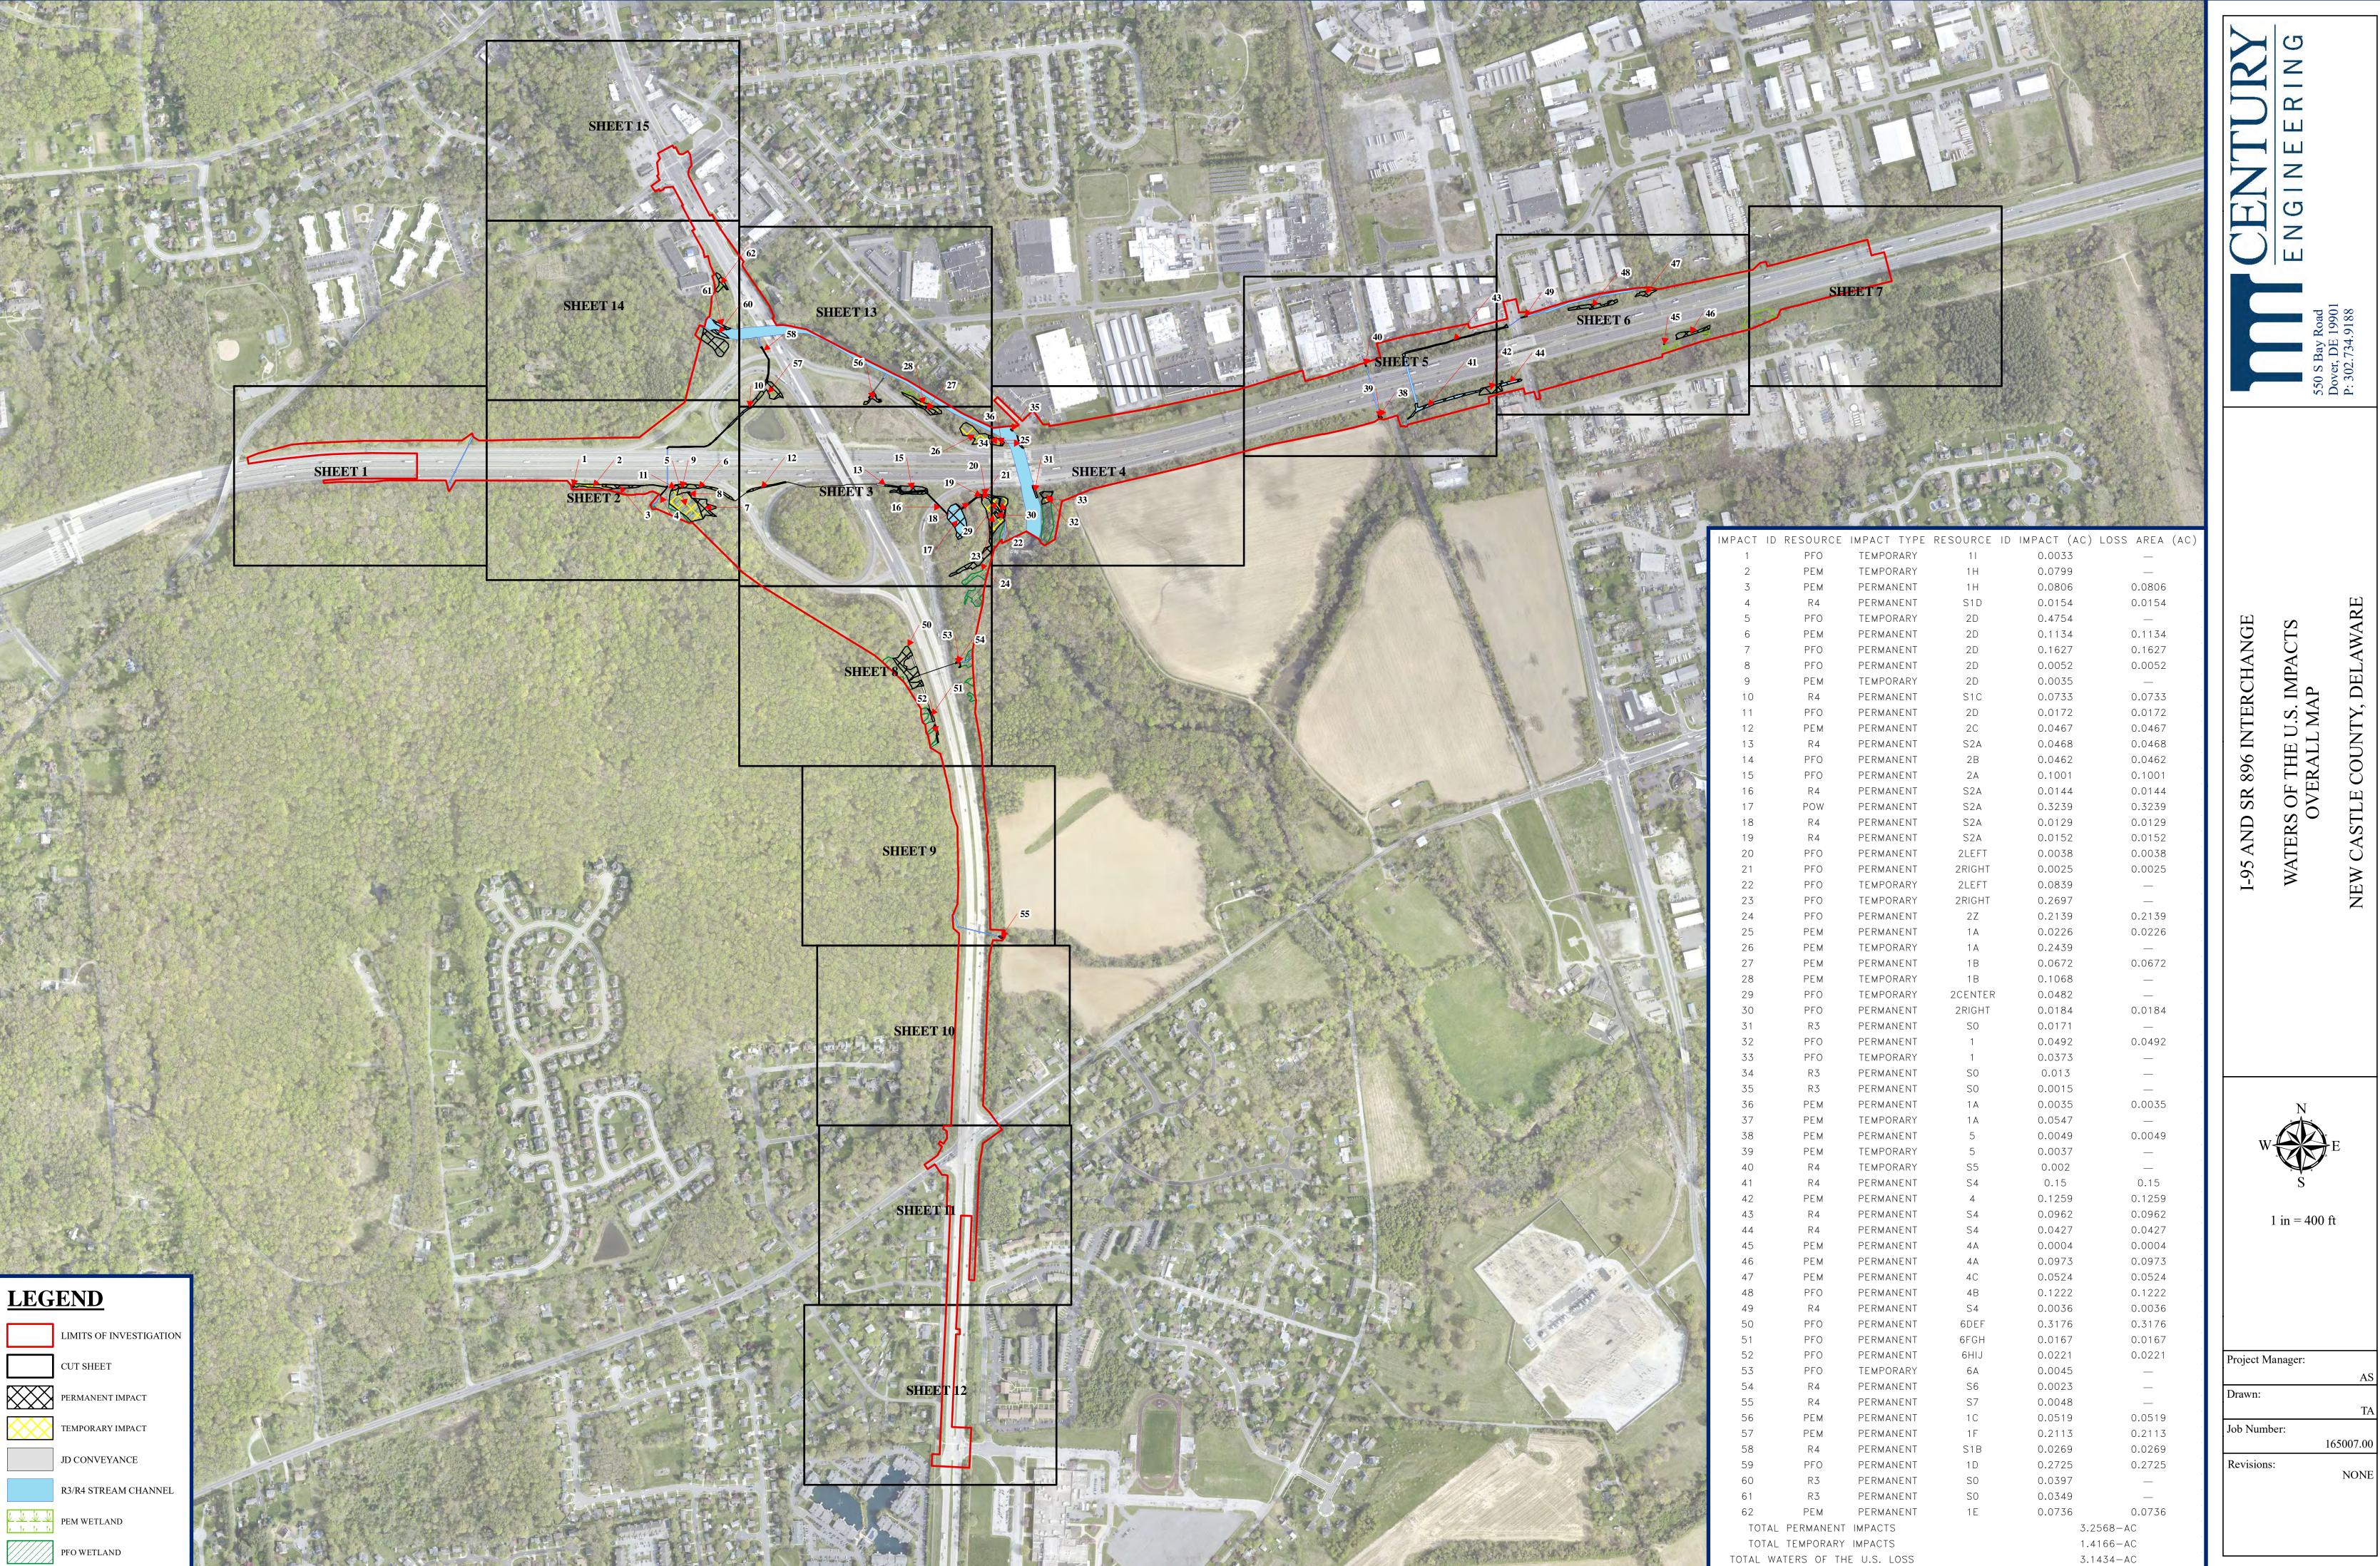

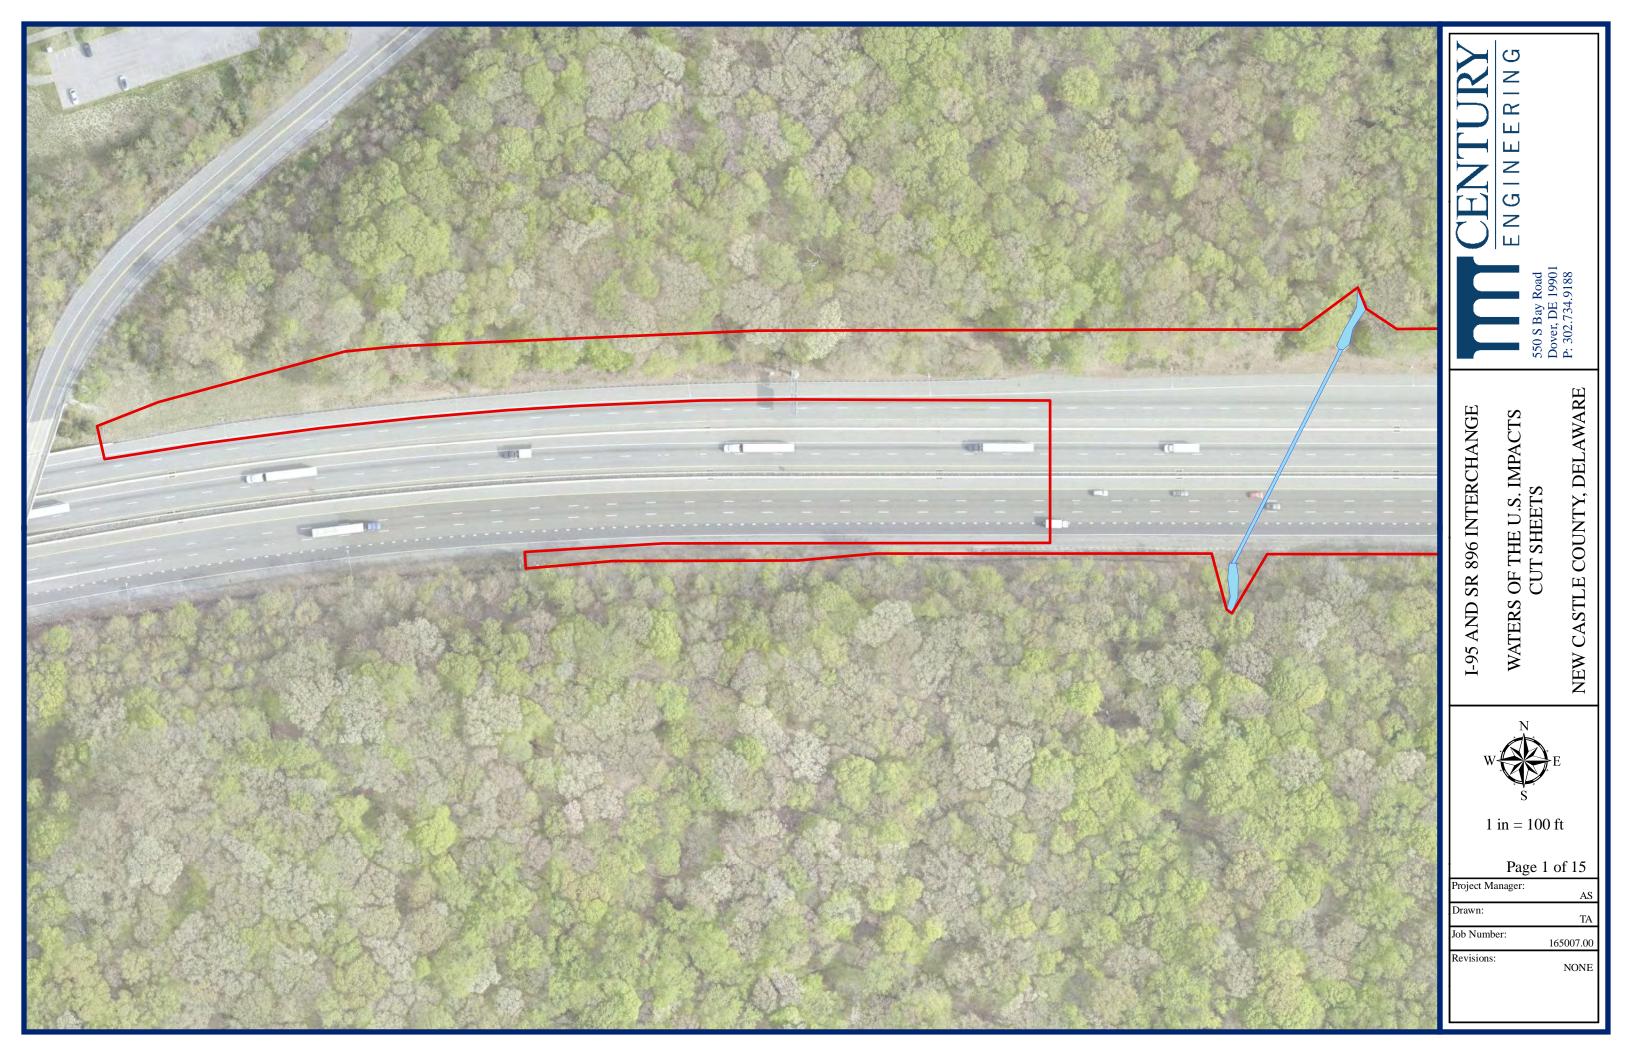



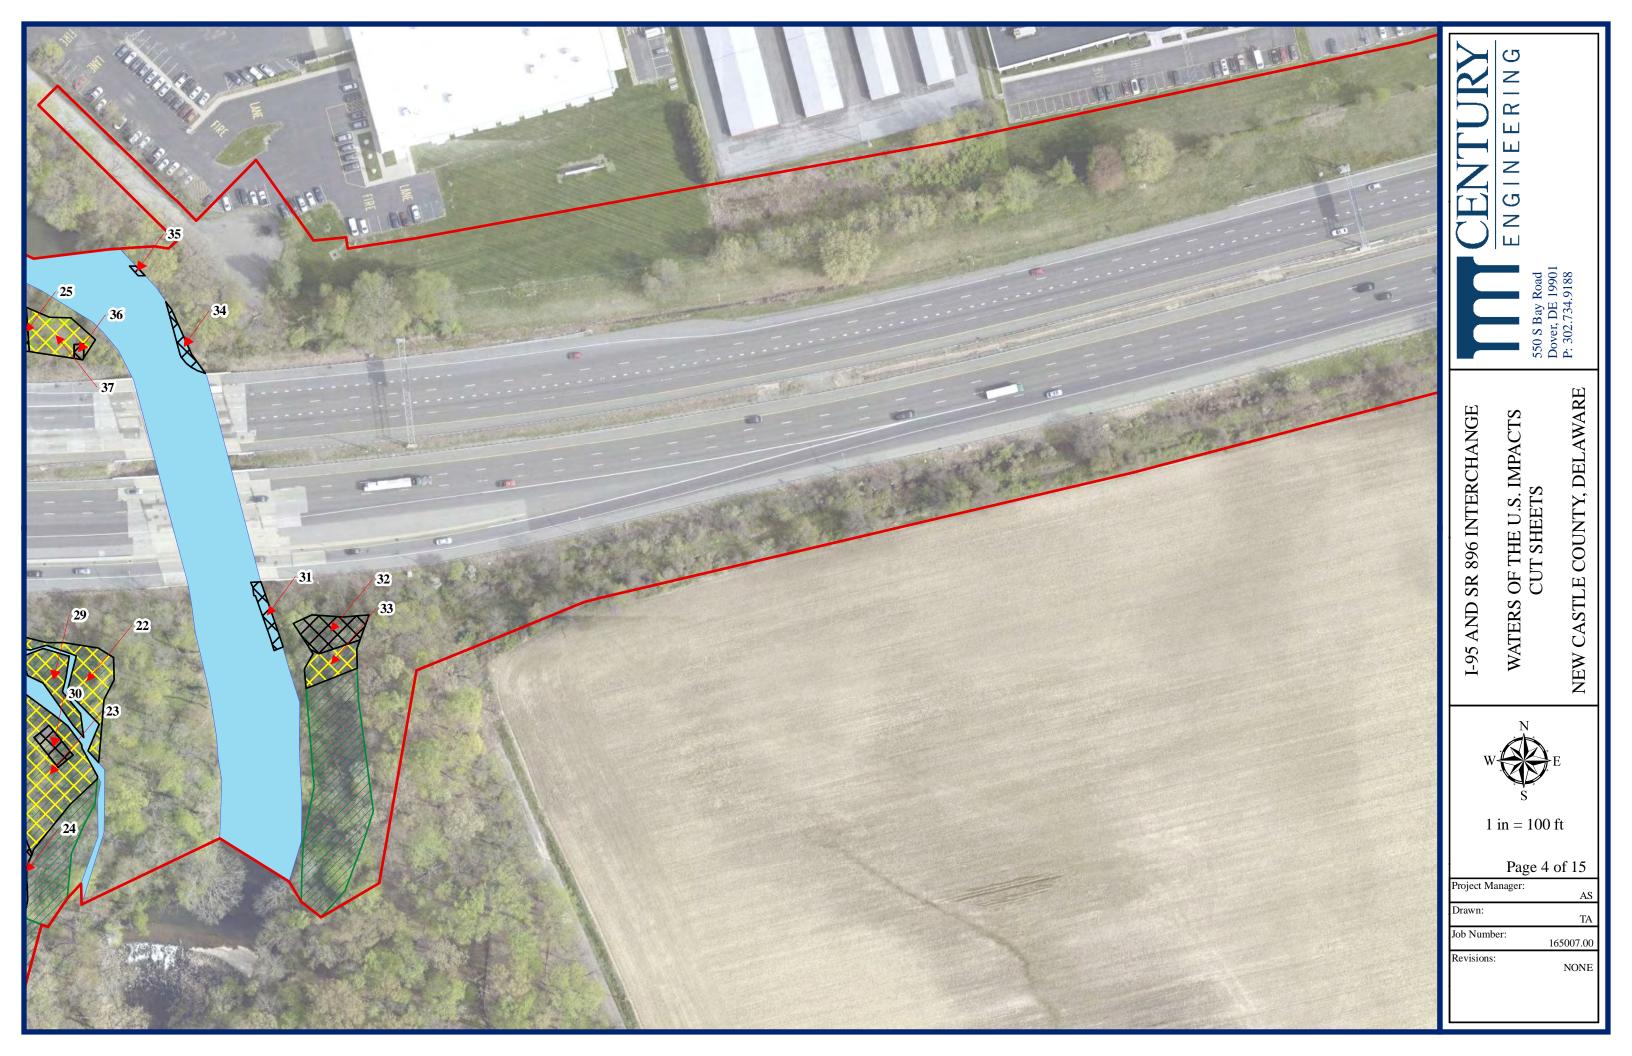

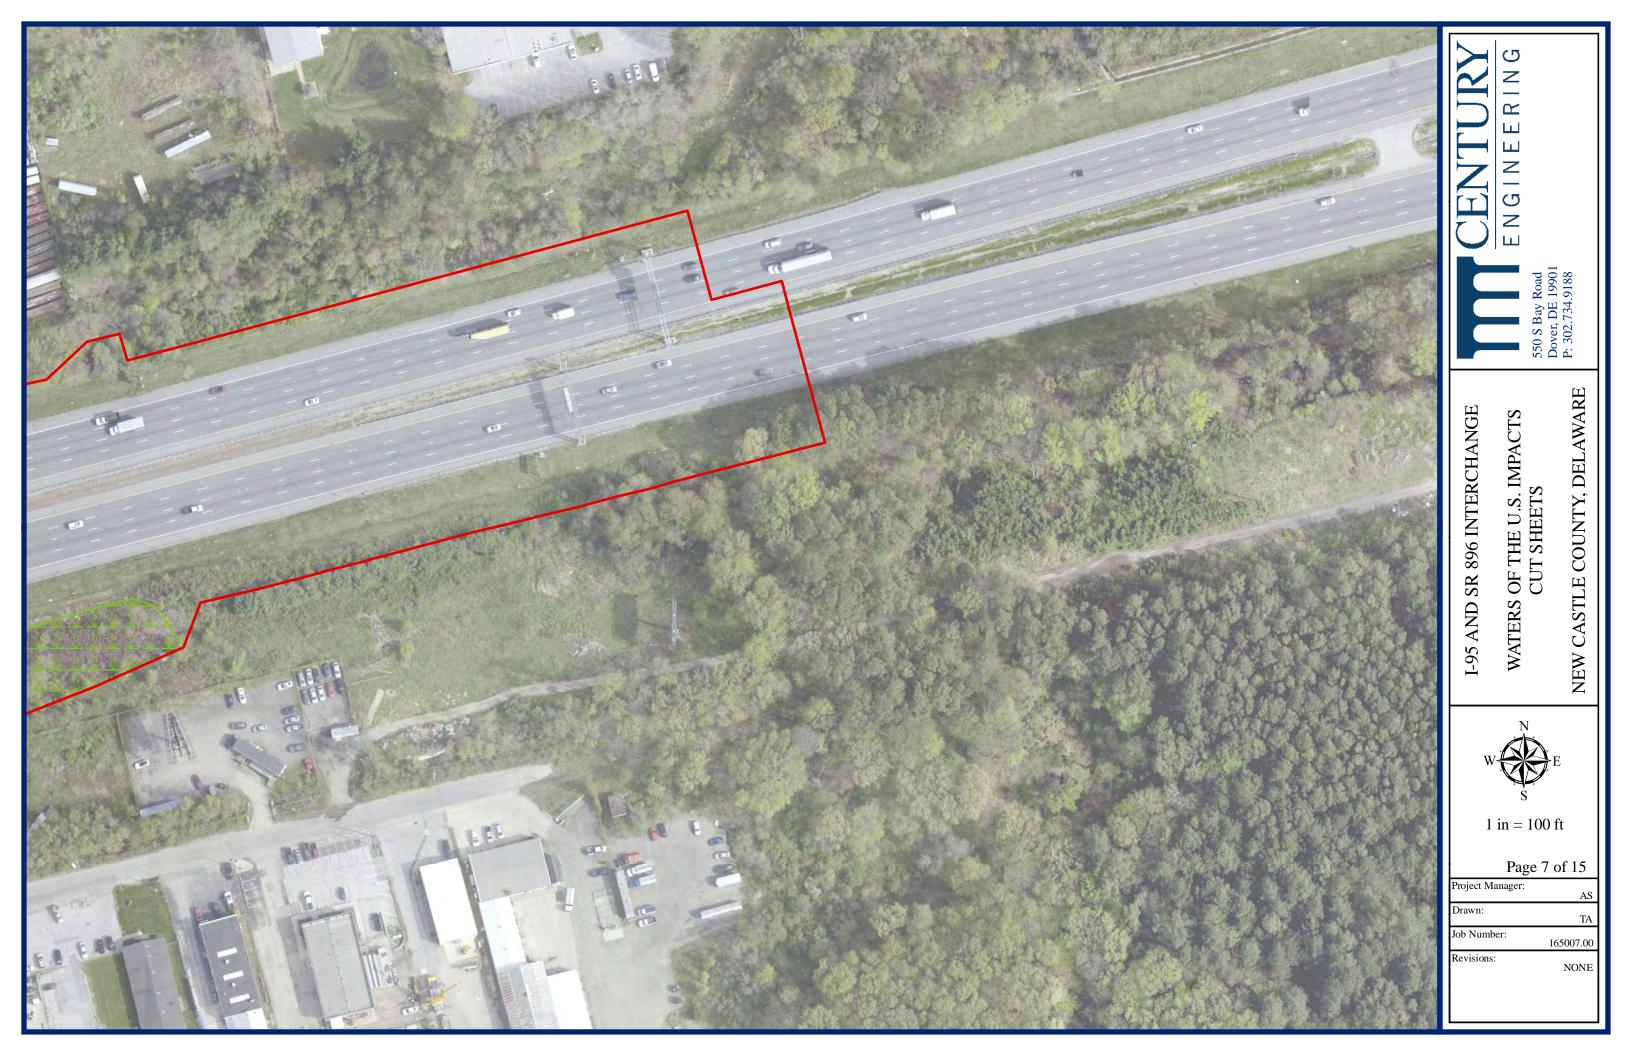











W N E

1 in = 100 ft

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NONE

NEW CASTLE COUNTY, DELAWARE

Project Manager:
AS
Drawn:
TA
Job Number:
165007.00





I-95 AND SR 896 INTERCHANGE WATERS OF THE U.S. IMPACTS CUT SHEETS

1 in = 100 ft

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NEW CASTLE COUNTY, DELAWARE

Project Manager:	
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Drawn:	
	TA
Job Number:	
	165007.00

NONE

